


OCCUPANCY LOAD CALCULATION PER 2018 IBC
TABLE 1004.5

NUMBER	NAME	AREA	S.F. PER PERSON	# OF PERSONS (OCCUPANTS)
BASEMENT				
A-3 OCCUPANCY				
B100	ENTRY	70 SF	150	0.5
B101	HALL	228 SF	150	1.5
B102	MEN	83 SF	150	0.6
B103	WOMEN	89 SF	150	0.6
B104	EXISTING UTILITY	174 SF	300	0.6
B105	EXISTING MAINTENANCE	208 SF	300	0.7
B106	EXISTING IT	200 SF	300	0.7
B107	EXISTING UTILITY	99 SF	300	0.3
B108	TRAINING	814 SF	15	54.2
B109	REFRESH	54 SF	15	3.6
B110	EXISTING UTILITY	100 SF	300	0.3
B111	HALL	229 SF	150	1.5
B111A	HALL	234 SF	150	1.6
B112	STORAGE	55 SF	300	0.2
B113	STORAGE	212 SF	300	0.7
B114	HALL	104 SF	150	0.7
B115	STORAGE	912 SF	300	3.0
B116	EXISTING UTILITY	156 SF	300	0.5
B117	EXISTING FAN ROOM	125 SF	300	0.4
B118	EXISTING UTILITY	95 SF	300	0.3
B119	EXISTING FAN ROOM	253 SF	300	0.8
B120	EXISTING ELECTRICAL	596 SF	300	2.0
B121	EXISTING JANITOR	25 SF	300	0.1
B122	EXISTING UTILITY	298 SF	300	1.0
B123	EXISTING UTILITY	207 SF	300	0.7
B124	STORAGE	93 SF	300	0.3
				75.9
LEVEL 1				
136	HALL	458 SF		0.0
A-2 OCCUPANCY				
122	DINING ROOM	478 SF	15	31.9
124	DINING ROOM	1001 SF	15	66.8
125	KITCHEN	724 SF	200	3.6
126	KITCHEN STORAGE	277 SF	300	0.9
127	KITCHEN OFFICE	69 SF	150	0.5
A-3 OCCUPANCY				
100	ELEVATOR	46 SF	150	0.3
102	TERMINAL WAITING	5925 SF	15	395.0
103	HALL	345 SF	100	3.5
104	MEN	345 SF	100	3.5
105	JANITOR	38 SF	300	0.1
106	WOMEN	459 SF	100	4.6
107	RAMP	206 SF	100	2.1
108	TA INSPECTION	1463 SF	100	14.6
109	PRIVATE SEARCH	48 SF	100	0.5
110	STORAGE	48 SF	300	0.2
111	RAMP	340 SF	100	3.4
112	EXIT	276 SF	100	2.8
113	HALL	162 SF	150	1.1
113A	STAIRS	123 SF	150	0.8
114	ISA STACKING	1034 SF	15	68.9
114A	ELEC.	32 SF	300	0.1
115	ISA SUPERVISOR	107 SF	150	0.7
116	BAGGAGE SCREENING	691 SF	300	2.3
117	ISA BREAK ROOM	174 SF	15	11.6
118	STAIRS	124 SF	150	0.8
119	MEN	57 SF	100	0.6
120	WOMEN	57 SF	100	0.6
121	LOBBY	1814 SF	100	18.1
123	ABANDONED STAIR	124 SF	0	0.0
128	JANITOR	38 SF	100	0.4
129	EXIT	251 SF	150	1.7
129A	STAIRS	113 SF	150	0.8
130	EXIST. STOR.	50 SF	300	0.2
131	FAMILY RESTROOM	64 SF	100	0.6
132	TICKETING	906 SF	100	9.1
133	OVERSIZED BAGGAGE CLAIM	123 SF	20	6.2
134	BAGGAGE DROP-OFF	1204 SF	300	4.0
135	BAGGAGE OFFICE	82 SF	150	0.5
137	INFO	75 SF	150	0.5
138	BAGGAGE CLAIM	840 SF	20	42.0
139	SEATING	469 SF	15	31.3
140	LOBBY	2057 SF	100	20.6
141	CAR RENTAL	686 SF	100	6.9
142	RENTAL OFFICE	124 SF	150	0.8
143	RENTAL OFFICE	132 SF	150	0.9
144	RENTAL OFFICE	130 SF	150	0.9
S-1 OCCUPANCY				
101	FIRE TRUCK BAY	1433 SF	200	7.3
101A	ELEC.	49 SF	300	0.2
LEVEL 2				
B OCCUPANCY				
201	HALL	163 SF	150	1.1
202	HALL	Not Proceed	150	0.0
203	WAITING	22 SF	15	1.4
204	MEN	58 SF	150	0.4
205	WOMEN	58 SF	150	0.4
206	JANITOR/STORAGE	34 SF	300	0.1
207	BAGGING	145 SF	150	1.0
208	WORKROOM	74 SF	150	0.5
209	MANAGER OFFICE	219 SF	150	1.5
210	OPEN OFFICE	1186 SF	150	7.9
211	EXTERIOR PATIO	229 SF	150	1.5
212	COLLABORATION	49 SF	15	3.2
213	REFRESH	17 SF	15	1.1
214	CONFERENCE	397 SF	15	26.5
				46.6

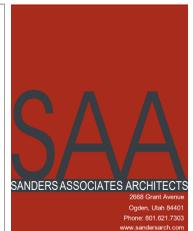

Stacey Construction
Construction Manager
General Contractor
376B Pacific Ave.
Ogden, UT 84405
801.521.6210
www.staceyco.com

Consultant

OGDEN-HINCKLEY AIRPORT
TERMINAL EXPANSION
3909 AIRPORT ROAD
OGDEN, UT 84405

Project Name

Issued	No.	Date	Description
1	11-15-2022	BID SET	

Revision


No.	Date	Description

SAA Project No. 2021-10
Drawing Title

CODE SUMMARY PLANS

Sheet Number
GI003

E
D
C
B
A

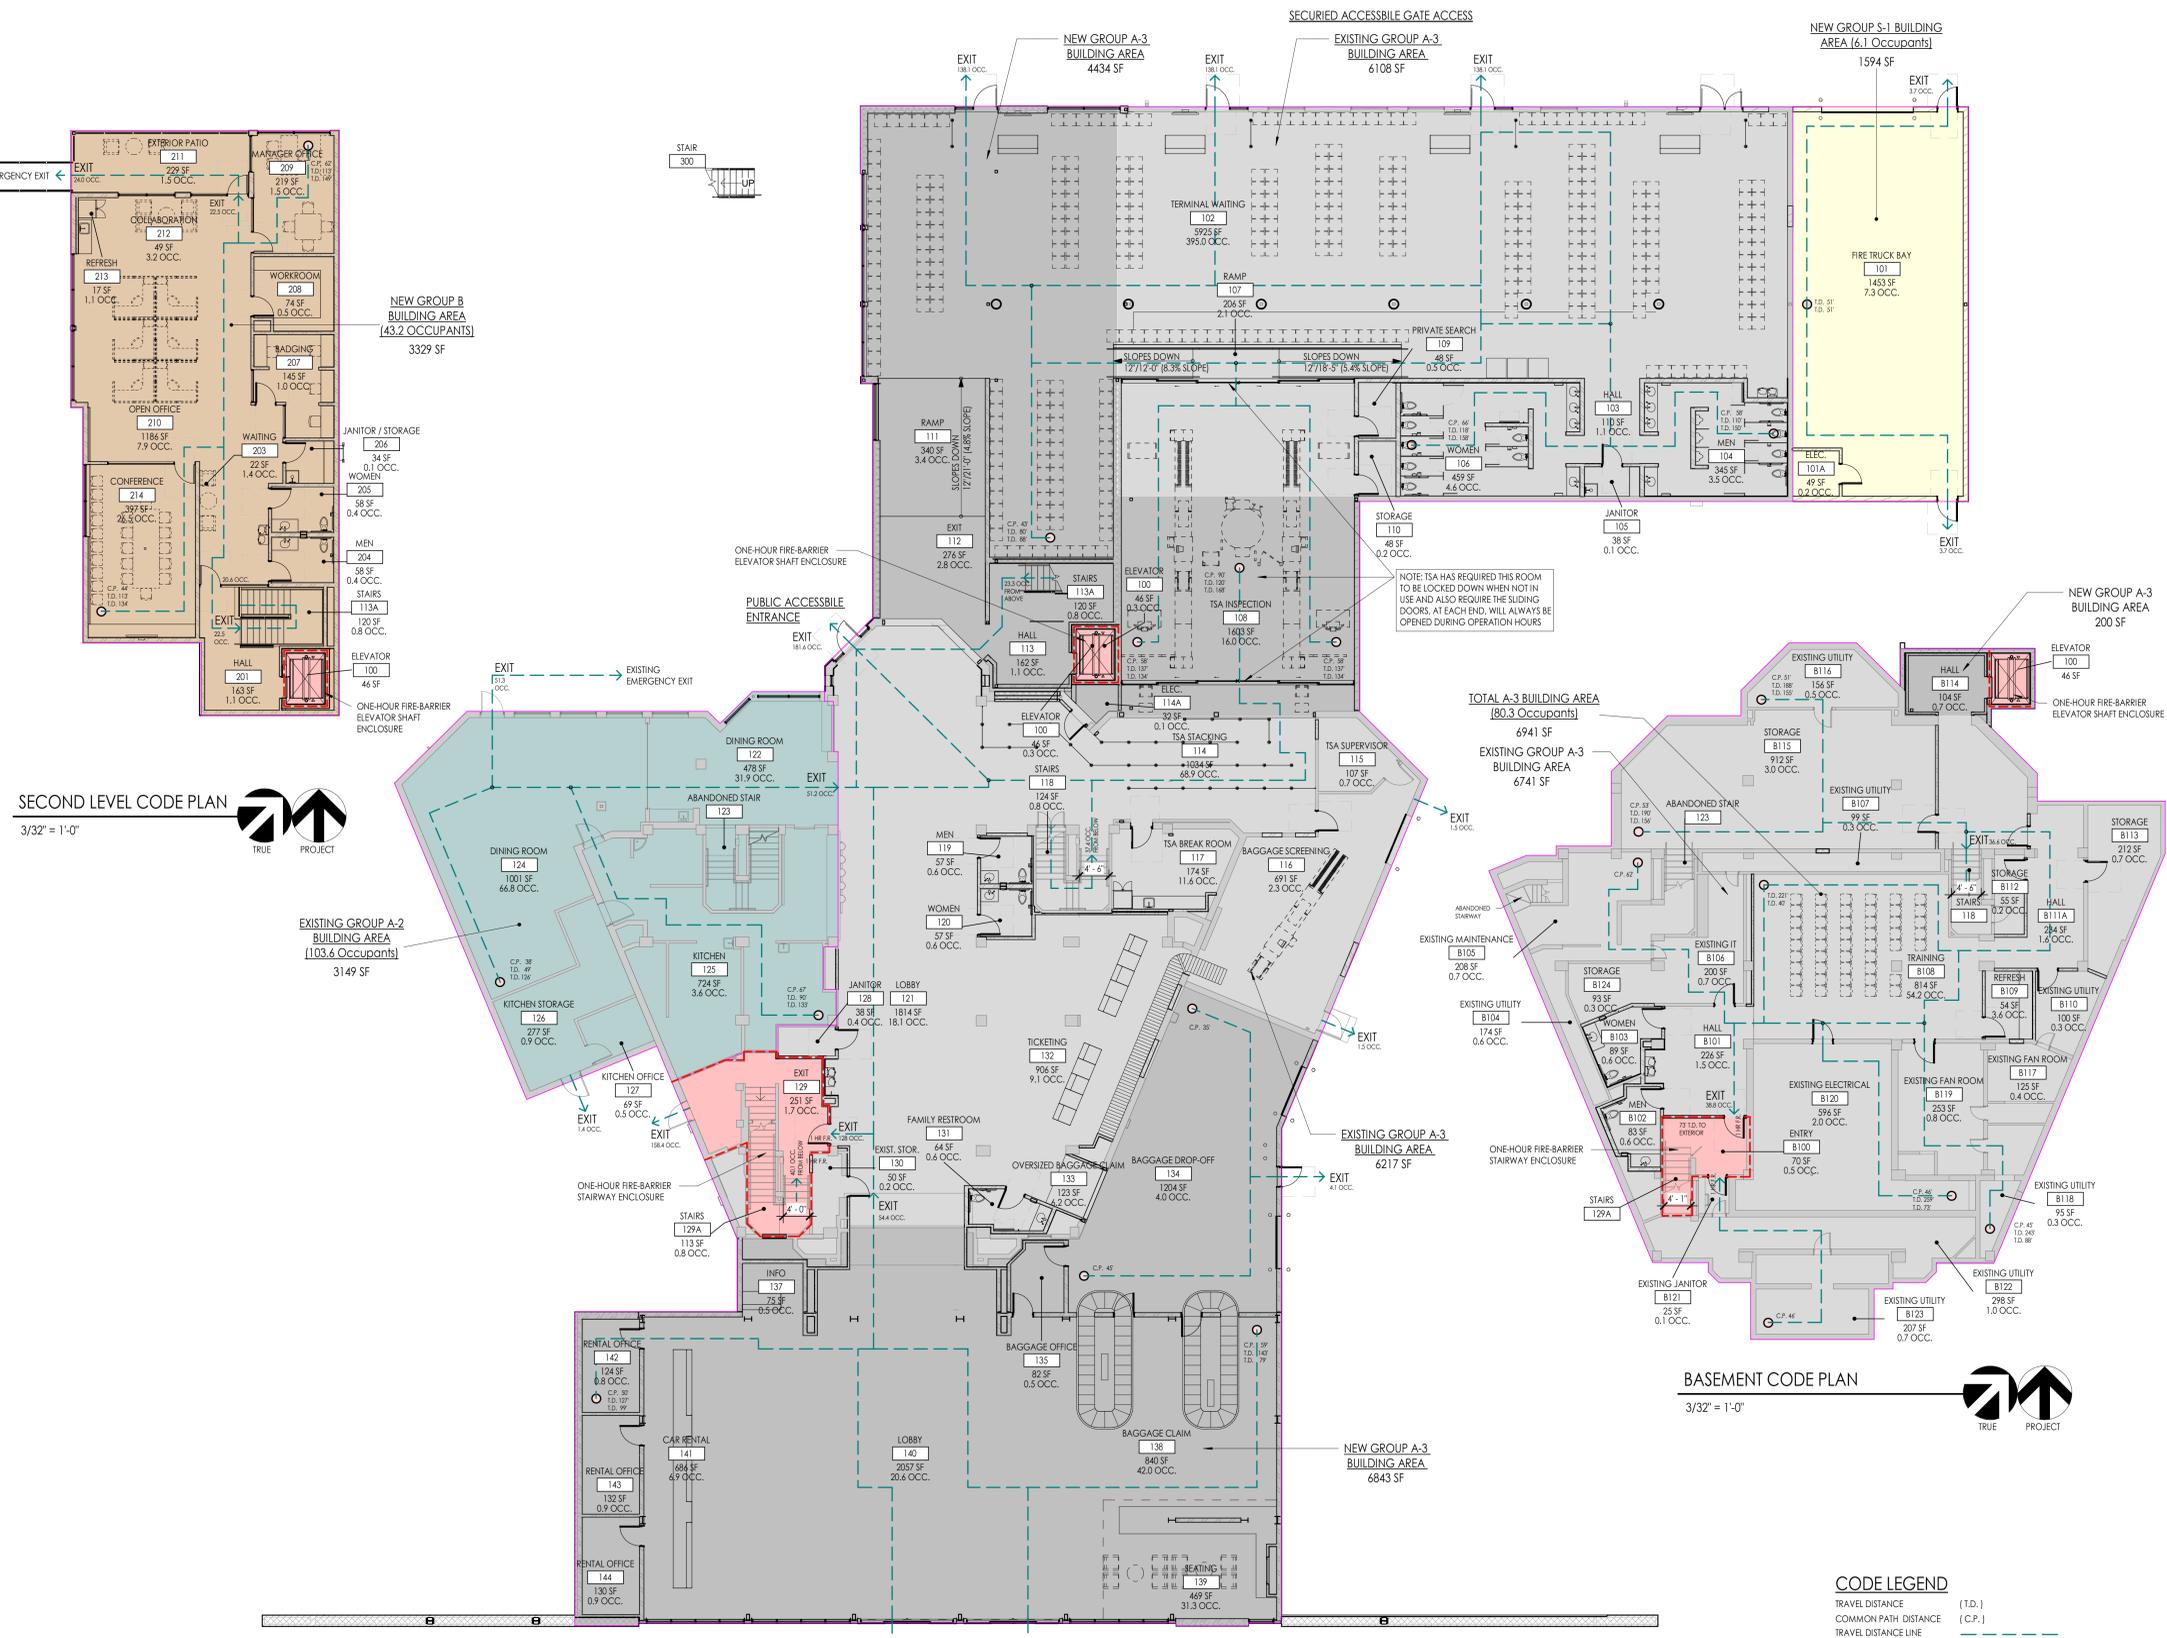

SECOND LEVEL CODE PLAN
3/32" = 1'-0"

BASEMENT CODE PLAN
3/32" = 1'-0"

MAIN LEVEL CODE PLAN
3/32" = 1'-0"

OCCUPANCY GROUP LEGEND

- NEW CONSTRUCTION - GROUP S-1
- NEW CONSTRUCTION - GROUP B
- NEW CONSTRUCTION - GROUP A-3
- EXISTING - GROUP A-3
- EXISTING - GROUP A-2

BUILDING AREA TABULATIONS:

BASEMENT:	EXISTING A-3	6,741 SF
	NEW A-3	200 SF
TOTAL BASEMENT		6,941 SF
MAIN LEVEL:		
	EXISTING A-2	3,149 SF
	EXISTING A-3 (SOUTH)	6,217 SF
	EXISTING A-3 (NORTH)	6,108 SF
	NEW A-3 (SOUTH)	6,843 SF
	NEW A-3 (NORTH)	4,434 SF
TOTAL A-3		23,602 SF
NEW S-1		1,594 SF
TOTAL MAIN FLOOR		28,345 SF
SECOND LEVEL: NEW B		
		3,344 SF
TOTAL SECOND LEVEL		3,344 SF

CODE LEGEND

- TRAVEL DISTANCE (T.D.)
- COMMON PATH DISTANCE (C.P.)
- TRAVEL DISTANCE LINE
- ONE-HOUR FIRE RATED SHAFT ENCLOSURE
- ONE-HOUR FIRE-RATED FIRE BARRIER WALL ASSEMBLY

CODE ANALYSIS

APPLICABLE CODES:

2018	IBC	International Building Code
2018	IFC	International Fire Code
2018	IPC	International Plumbing Code
2018	IMC	International Mechanical Code
2018	IFGC	International Fuel Gas Code
2017	NEC	National Electrical Code
2018	IECC	International Energy Conservation Code
2017	ANSI	ICC/ANSI A117.1 & Utah State/Local Amendments

GENERAL CODE INFORMATION

Total Basement: 6,941 sf (A-3 Occupancy)
Total Level 1: 28,345 sf (A-2, A-3, S-1 Occupancies)
Total Level 2: 3,344 sf (B Occupancy)
Construction Type: VB (Refer to Chapter 6 items below)
Building Area: (Refer to Section 506 & 506.2.1 below)
28,500 sf Allowable Building Area < 28,345 sf actual (Building Size Compliant)
Mixed Use - Non Separated: (Refer to Section 508 below)
Automatic Fire Sprinkler System: Meet NFPA 13 (Refer to Chapter 9 below)
 (New and existing building area to be provided with a new automatic sprinkler system)

ZONING INFORMATION - OGDEN CITY

Zone: A-C (Airport Commercial)
Maximum building height: Refer to Federal Aviation Regulation part 77
Front Yard Setback: 20'
Side Yard Setback: 10', 20' when facing a street
Rear Yard Setback: 20'
Maximum impervious coverage: 80%

Chapter 3 USE AND OCCUPANCY CLASSIFICATION

303.3	Assembly	Restaurant	A-2	Level 1: 3,149 sf
303.4	Assembly	Transportation Terminal	A-3	Basement: 6,941 sf
				Level 1: 23,602 sf
304	Business	Offices	B	Level 2: 3,344 sf
311	Storage	Garage	S-1	Level 1: 1,594 sf

Chapter 5 GENERAL BUILDING HEIGHTS AND AREAS

504	Building Height & Number of Stories
Table 504.3	Allowable Building Height in Feet Above Grade Plane Occupancy Groups A-3 (S), A-2 (S), B (S), S-1 (S) Construction Type Type VB Allowable Height 60 feet Proposed Design Height 36'-8" above grade plane Existing Elevation 31'-8" (Existing Flue), 22'-0 Building

Table 504.4	Allowable Number of Stories Above Grade Plane Occupancy Group A-2 (S), A-3 (S), S-1 (S) Construction Type Type VB Allowable # Stories 2 (Most restrictive requirement) Proposed Building Stories 2
	Occupancy Group B (S) Construction Type Type VB Allowable # Stories 3

506	Building Area
Table 506.2	Allowable Area Factor in Square Feet Occupancy Classification Type VB

Table 506.2	Allowable Area Factor in Square Feet
	A-2 (S1) 24,000 (Most restrictive requirement)
	A-3 (S1) 24,000 (Most restrictive requirement)
	B (SM) 27,000
	S-1 (S1) 36,000

506.2.4 Mixed-Occupancy, Multistory Buildings (Based on Non-separate Occupancies)
 Equation 5-3 $A_a = [A + (NS \times I)]$
 $A_a = [24,000 + (6,000 \times 0.75)] =$ **28,500 sf Allowable Area > 28,345 sf actual (Building Size - Compliant)**

506.3.2 Minimum Frontage Distance
 Equation 5-4 $W = (L_1 \times w_1 + L_2 \times w_2 + L_3 \times w_3 \dots) / F$
 $W = 38,430 / 1281 = 30$ (Public Way Open Space more than 30 feet the entire perimeter)

506.3.3 Amount of Increase
 $I = [F / P - 0.25] W / 30$
 $I = [1281 / 1281 - 0.25] 30 / 30 = 0.75$

508 Mixed Use and Occupancy
 508.2.3 Accessory Occupancies Allowable building area
 Aggregate accessory occupancy shall not occupy more than 10% of the floor area of the story in which they are located and shall not exceed the tabular values for non-sprinklered buildings in Table 506.2 for each accessory occupancy.

508.3 Nonseparated Occupancies
 Buildings or portions of buildings that comply with the provisions of this section shall be considered as

508.3.1 Occupancy Classification
 Nonseparated occupancies shall be individually classified in accordance to Section 302.1. The requirements of this code shall apply of each portion of the building based on the occupancy classification of that space. In addition, the most restrictive provisions of Chapter 9 that apply to the nonseparated occupancies shall apply to the total nonseparated occupancy area.

508.3.2 Allowable building area and height
 The allowable building area and height of the building or portion thereof shall be based on the most restrictive allowances for the occupancy groups under consideration for the type of construction of the building in accordance with Section 503.1.

Maximum Allowable Area = 28,500 sf
Proposed Level One Area = 28,345 sf

Maximum Allowable Building Height (A-2, A-3, B, S-1) = 60' Proposed New Building Height = 36'-8" Existing Height = 31'-8" Flue, 22'-0" building

Maximum Allowable Number of Stories (A-2, A-3, S-1) = 2; Proposed Building Stories = 2 story above grade plane

Chapter 6 Types of Construction

602.2	Construction Type VB
Table 601	Fire-Resistance Rating Requirements for Building Elements (Hours)
	Primary Structural Frame 0
	Bearing Walls - Exterior 0
	Bearing Walls - Interior 0
	Exterior Non-bearing Walls & Partitions Refer to Table 602
	Interior Non-bearing Walls & Partitions 0
	Floor Construction & Associated Secondary Members 0
	Roof Construction & Associated Secondary Members 0

Table 602	Fire-Resistance Rating Req'ts for Exterior Walls Based on Fire Separation Distance
	Construction Type VB Occupancy Group
	Fire Separation Distance = x (ft)
	X < 5 1 2
	5 < X < 10 1 1
	10 < X < 30 0 0
	X > 30 0 0

Chapter 7 Fire and Smoke Protection Features

704 **Fire-Resistance of Structural Members**
 704.1 Requirements (Not Applicable)

705 Exterior Walls

705.8.1 Allowable Area of Openings

Table 705.8.1	Max. Area of Exterior Wall Openings Based on Fire Separation Distance and Degree of Opening Protection
	0 < X < 3 Unprotected (S) Not Permitted
	3 < X < 5 Unprotected (S) 15%
	5 < X < 10 Unprotected (S) 25%
	10 < X < 15 Unprotected (S) 45%
	15 < X < 20 Unprotected (S) 75%
	20 < X < 25 Unprotected (S) No Limit

705.11 Parapets
 Shall be provided on exterior walls of buildings. Parapet is not required when the wall is not required to be fire-resistance rated.

706.2 Structural Stability
 Fire Walls shall be designed and constructed to allow collapse of the structure on either side without collapse of the wall under fire conditions.

707 Fire Barriers

707.3.1	Shaft Enclosures	1 Hour	Comply with Section 713.4
707.3.2	Interior Exit Stairway	1 Hour	Comply with Section 1023.1
707.3.3	Exit Access Stairway	1 Hour	Comply with Section 713.4
707.3.4	Exit Passageway	1 hour	Comply with Section 1024.3
707.3.5	Horizontal Exit	2 Hour	Comply with Section 1026.1
707.3.7	Incidental Uses	As Req'd	Comply with Table 509
707.3.8	Control Areas	As Req'd	Comply with Section 414.2.4

707.4 Exterior Walls
 Where exterior walls serve as a part of a required fire-resistance-rated shaft or stairway, or separation, such as walls shall comply with the requirements of Section 705 for exterior walls and the fire-resistance-rated enclosure or separation requirements shall not apply.
 Exception: Exterior walls required to be fire-resistance-rated in Section 1021 for exterior exit balconies, Section 1037.7 for interior exit stairways and ramps, and Section 1027.6 for exterior exit stairways and ramps.

707.5 Continuity
 Fire Barriers shall extend from the foundation or floor/ceiling assembly below to the underside of a floor or roof sheathing above or to fire-resistance rated floor/ceiling or roof/ceiling assemblies. Shall be continuous through concealed spaces. Joints and voids at intersections shall comply with Sections 707.8 and 707.9
 Exception 1: Shaft enclosures shall be permitted to terminate at top enclosure complying with Section 713.12.
 Exception 2: Interior exit stairway enclosures required by Section 1023 shall be permitted to terminate at top enclosure complying with Section 713.12.

707.5.1 Supporting Construction
 Interior exit stairways meeting Section 1023 shall be permitted to terminate at top enclosure complying with Section 713.12.
 Exception 2:

708 Fire Partitions
 708.3 Fire-resistance Rating for Corridor Walls
 Group A-2, A-3, B, & S-1 Corridor walls are not required to be have a fire-resistance rating by Table 1020.1 with a fire sprinkler system.

708.4 Continuity
 Fire Partitions shall extend from the top of the foundation or floor/ceiling assembly below and be securely attached to one of the following:
 The underside of a floor or roof sheathing, deck or slab above.
 The underside of a floor/ceiling or roof/ceiling assembly having a fire-resistance rating that is not less than the fire-resistance rating of the fire partition.

708.6 Openings
 Fire Partitions shall be protected per Section 716.

708.7 Penetrations
 Fire Partition penetrations shall be comply with Section 714.

708.8 Joints
 Fire Partition joints shall comply with Section 715.

708.9 Ducts & Transfer Openings
 Fire Partition penetrations by ducts and air transfer openings shall comply with Section 717.

711 **Floor & Roof Assemblies**
 711.2.2 Continuity
 Assemblies shall be continuous without vertical openings, except as permitted by Section 712.

711.2.3 Supporting Construction
 The supporting construction shall be protected to afford the required fire-resistance rating of the horizontal assembly.

712 **Vertical Openings**
 712.1.1 Shaft Enclosures
 Vertical openings contained entirely within a shaft enclosure meeting Section 713.

714 **Penetrations**
 714.4.2 Membrane Penetrations
 Penetrations shall be sealed to meet Section 714.4.1 for fire-resistance rated assembly.

Chapter 8 Interior Finishes

803 Wall & Ceiling Finishes

Table 803.13	Interior Wall & Ceiling Finish Requirements By Occupancy		
	Group Exit Stairways, Ramps & Exit Passageways	Corridors & enclosure for exit access stairways	Rooms & enclosed spaces
	A-2;(S) Class B	Class B	Class C
	A-3;(S) Class B	Class B	Class C
	B;(S) Class B	Class C	Class C
	S-1;(S) Class C	Class C	Class C

Chapter 9 Fire Protection Systems

903 Automatic Sprinkler Systems

903.2.1.3 Group F-1
 A Group A-3 fire area exceeds 12,000 sf, an Automatic sprinkler system shall be provided.

903.3.1 NFPA 13
 Automatic sprinkler system to be provided.

903.4.1 Monitoring
 Alarm, supervisory & trouble signals shall be distinctly different & shall be automatically transmitted to an approved supervising system.

903.4.2 Alarms
 Exterior approved audible device shall be connected to the automatic sprinkler system and actuate when sprinkler system is activated.

905 Standpipe Systems

905.1 General
 Standpipe systems are required in new construction.

905.2 Installation Standard
 Standpipe systems shall be installed as per Section 905 & NFPA 14. Fire department connections shall be installed per Section 912.

906 Portable Fire Extinguishers

906.1 Group B & F
 Portable fire extinguishers shall be installed as required in Section 906

Chapter 10 Means of Egress

1004.1 Occupant Load
 (Refer to Occupancy Load Calculation per IBC 2018 Table 1004.5 located on drawing GI003 for Total Occupancy Load)

1005 Means of Egress Sizing

1005.3.2 Other Egress
 0.2 inches x Occupant
Total occupants = 901
890.4 x 0.2 = 182 total inches door clearance required (588 inches public exit / emergency exit door clearance provided)

1006 Number of Exits and Access Doorways

1006.2.1 Egress based on Occupant Load and Common Path of Egress Distance
 Two exits, or exit access doorways, from any space shall be provided where the Design Occupancy Load or the Common Path of Egress Travel distance exceeds the values listed in Table 1006.2.1

Table 1006.2.1	Spaces with One Exit or Exit Access Doorway
	Occupancy: Max. Occupant Load of Space With Sprinkler System
	A-2, A-3 49 75 feet
	B 49 100 feet
	S-1 29 100 feet

Table 1006.3.2 Min. Number of Exits or Access to Exits per Story

	Occupant Load per Story	Min. Number of exits or Access to Exits from a Story
	1-500	2
	501-1000	3
	More than 1000	4

1009 Accessible Means of Egress

1009.1 # of Required Accessible Means of Egress is Req'd
 Not less than one accessible means of egress is required, or not less than Two accessible means of egress is required where more than one means of egress is required.

1009.2 Continuity
 Each required accessible means of egress shall be continuous to a public way.

Accessible Routes
 1009.3 Interior Exit Stairways
 1011.2 Exterior Exit Stairways
 1011.2 Elevators
 1011.2 Horizontal Exits
 1011.2 Ramps
 Comply with Section 1104
 Comply with Section 1009.3 & 1019.4
 Comply with Section 1009.3 & 1019.3 or 1019.4
 Comply with Section 1009 & 1027
 Comply with Section 1009.4
 Comply with Section 1026
 Comply with Section 1012

1009.3 Stairways
 Exception 2: Clear width of 48 inches between handrails for accessible stairways is not required with automatic fire sprinklers installed.

1011 Stairways
 1011.2 Width & Capacity
 The required capacity of stairways shall be determined as specified in Section 1005.1 but not less than 44 inches min. required, or as indicated in Section 1009.3
 Exception 1: Stairways serving an occupant load of less than 50 shall have a width of not less than 36 inches.

1017 Exit Access Travel Distance

Table 1017.2 Occupancy Distance with sprinkler system
 Group A 250 feet
 Group B 300 feet
 Group S-1 250 feet

1020 Corridors

Table 1020.1	Corridor Fire-Resistance Rating
	Occupancy Occupant Load Served by Corridor Required Fire Resistance Rating w/ Sprinklers
	Group A, B, S Greater than 30 Not Required

Table 1020.2	Minimum Corridor Width
	Occupancy Any facilities not listed below Occupant load less than 50
	Minimum Width (inches) 44 inches 36 inches

1020.4 Dead Ends
 Exception 2: Where more than one exit is required, and equipped with a sprinkler system, length of any dead end corridor shall not exceed 50 feet.

Chapter 11 ACCESSIBILITY

1104 Accessible Route
 1104.1 Site Arrival Points
 At least one accessible route within the site shall be provided from public transportation stops, accessible parking, accessible loading zones, and public streets or sidewalks to the accessible entrance served.

1104.3 Connected Spaces
 Accessible buildings shall have at least one accessible route to each portion of the building, to accessible building entrances connecting accessible pedestrian walkways and to the public way.

1104.4 Multistory Buildings and Facilities
 At least one accessible route shall connect each accessible story, mezzanine & occupied roofs on multilevel buildings and facilities.

1105 Accessible Entrances
 1105.1 Public Entrances
 At least 60% of all public entrances shall be accessible. (All public entrances are accessible)

Chapter 12 Interior Environment

1207.2 Minimum Ceiling Heights
 Occupiable spaces, habitable spaces and corridors shall have a ceiling height of not less than 7'-6". Bathrooms, toilet rooms, kitchens, storage rooms and laundry rooms shall have a ceiling height of not less than 7 feet. The height of mezzanines and spaces below mezzanines shall be in accordance with Section 505.2.

Exception 3

1207.2.1 Furred Ceiling
 Any room with a furred ceiling shall be required to have the minimum ceiling height in two-thirds of the area thereof, but in no case shall the height of the furred-ceiling be less than 7 feet.

Chapter 15 Roof Assemblies and Rooftop Structures

1505 Fire Classification
 Table 1505.1: Type VB = Class C Roof Covering Min. (Class A specified)

Chapter 29 Plumbing Fixtures

Table 2902.1 Min. Number of Plumbing Fixtures

	Group A-2 Restaurant	71.7 Occupants (36 Men - 36 Women)
		Requirement Men Women
	Water Closets/Urinals	1/75 0.5 required 0.5 required
	Lavatories	1/200 0.2 required 0.2 required
	Drinking Fountain	1/500 0.2 required
	Service Sink	1 required
	Group A-3 Transportation Terminal (Main Floor)	756.4 Occupants (379 Men - 379 Women)
		Requirement Men Women
	Water Closets	1/500 0.8 required 0.8 required
	Lavatories	1/750 0.5 required 0.5 required
	Drinking Fountain	1/1000 0.8 required
	Service Sink	1 required

Group A-3 Transportation Terminal (Basement)

	Requirements	Men	Women
Water Closets	1/500	0.1	0.1
Lavatories	1/750	0.1	0.1
Drinking Fountain	1/1000	0.1	0.1
Service Sink	1 required		
Group B Office	47.9 Occupants (24 Men - 24 Women)		
	Requirement Men Women		
Water Closets	1/25 to 50, 1/50 beyond	1 required	1 required
Lavatories	1/40 to 80, 1/80 beyond	0.6 required	0.6 required
Drinking Fountain	1/100	0.5 required	
Service Sink	1 required		
Group S-1 Garage	14.4 Occupants (8 Men - 8 Women)		
	Requirement Men Women		
Water Closets	1/100	0.1 required	0.1 required
Lavatories	1/100	0.1 required	0.1 required
Drinking Fountain	1/1000	0.1 required	
Service Sink	1 required		

Total Proposed Plumbing Fixtures

Main Floor	Men	Women
Water Closets/Urinals	1.4 required (8 provided)	1.4 required (8 provided)
Lavatories	0.8 required (8 provided)	0.8 required (8 provided)
Drinking Fountains	1.1 required (4 drinking fountains provided - 2 ADA)	
Service Sinks	1 required (2 provided)	
(Note: One Family Restroom not included in calculations)		
Second Floor	Men	Women
Water Closets/Urinals	1 required (1 provided)	1 required (1 provided)
Lavatories	0.6 required (1 provided)	0.6 required (1 provided)
Drinking Fountains	0.5 required (2 provided - 1 ADA)	
Service Sink	1 required (1 provided)	
Basement	Men	Women
Water Closets/Urinals	0.1 required (1 provided)	0.1 required (1 provided)
Lavatories	0.1 required (1 provided)	0.1 required (1 provided)
Drinking Fountains	0.1 required (2 provided - 1 ADA)	
Service Sinks	1 required (1 provided)	



Project Name

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1	11-15-2022		BID SET


Revision

No.	Date	Description

SAA Project No. 2021-10
 Drawing Title

ACCESSIBILITY DETAILS
 FOR NEW & EXISTING
 CONSTRUCTION

Sheet Number
G1005

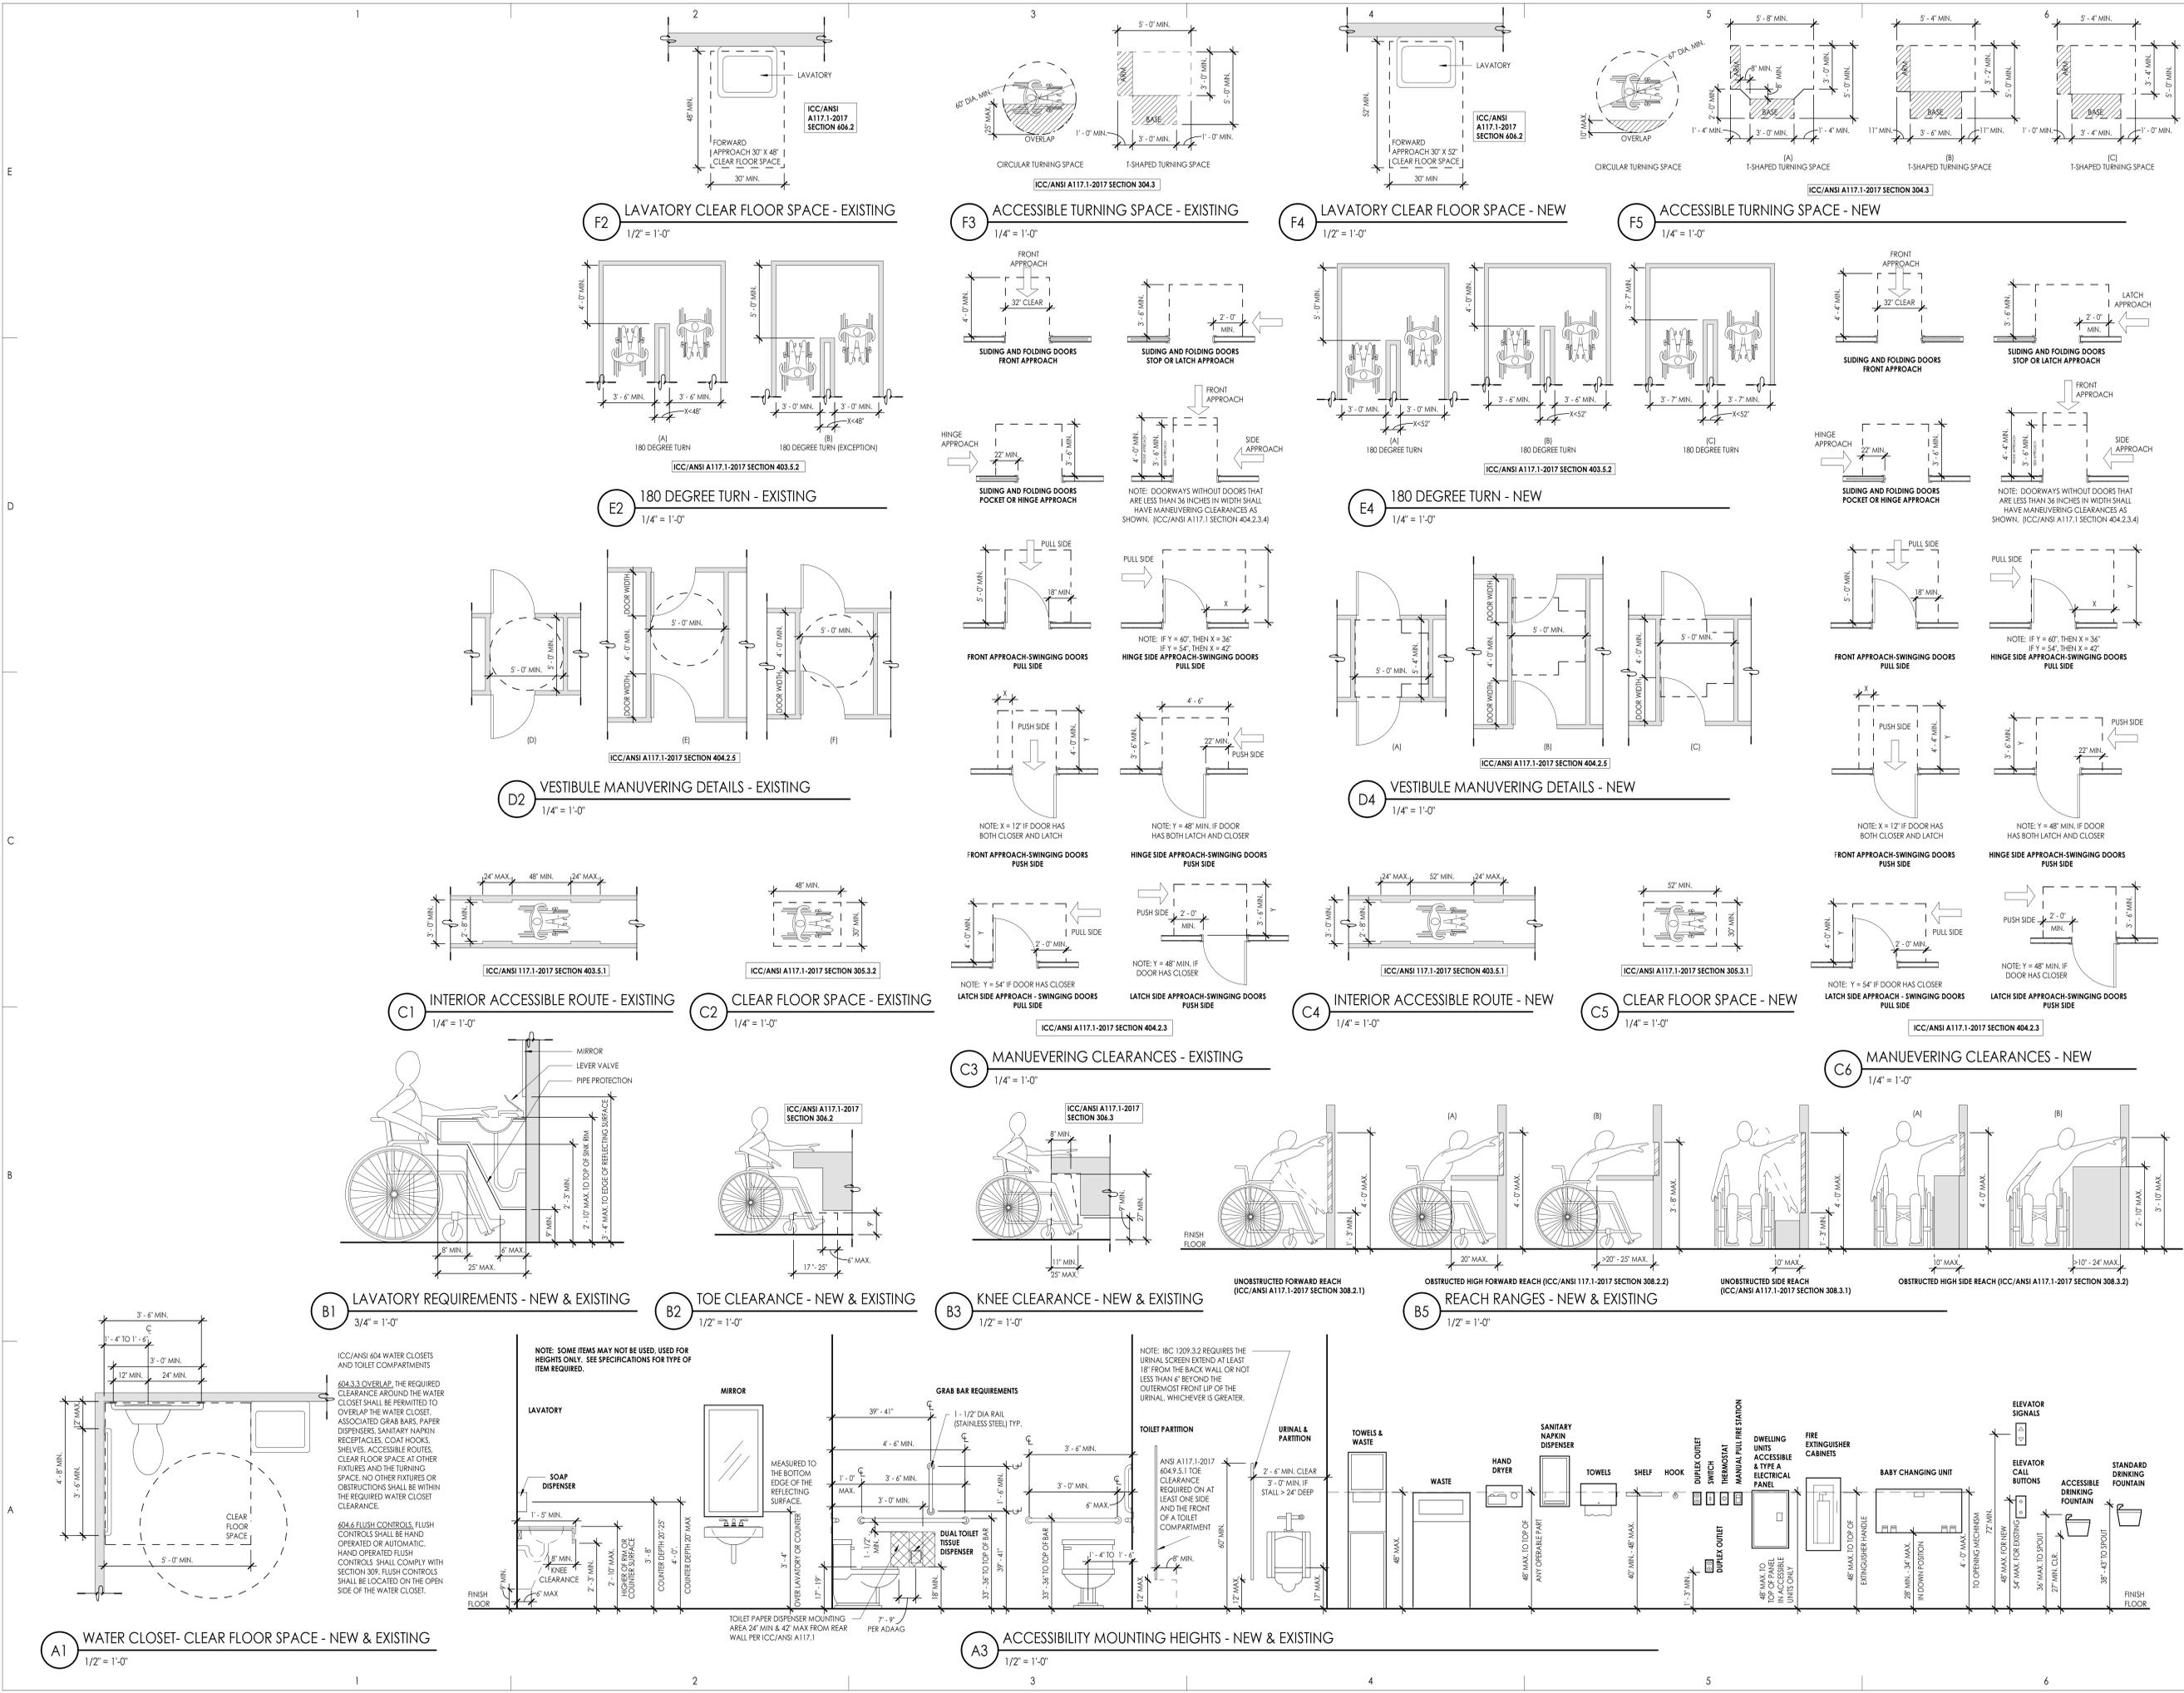



Stacey Construction
Construction Manager
General Contractor
3788 Pacific Ave.
Ogden, UT 84405
801.621.6210
www.staceygc.com

Consultant

Project Name
**OGDEN-HINCKLEY AIRPORT
TERMINAL EXPANSION**
3909 AIRPORT ROAD
OGDEN, UT 84405

Issued	No.	Date	Description
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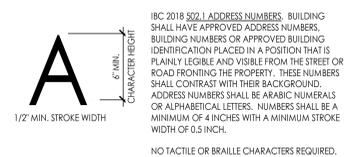
Revision	No.	Date	Description

SAA Project No. 2021-10
Drawing Title

SIGNAGE TYPES AND DETAILS

Sheet Number

G1007




E3 BUILDING ADDRESS SIGNAGE
3" = 1'-0"

NOTE: ADAAG: TEMPORARY SIGNS, WHICH ARE EXEMPT INCLUDE IDENTIFICATION OF TENANCIES, NAMES AND TITLES OF ROOM OCCUPANTS, NOT-FIXED SIGNAGE, AND TEMPORARY POSTINGS. TEMPORARY SIGNS ARE NOT REQUIRED TO HAVE TACTILE OR BRAILLE CHARACTERS.


ADAAG 4.30 TACTILE SIGNAGE. RAISED AND BRAILLE CHARACTERS ARE REQUIRED ON SIGNS THAT DESIGNATE PERMANENT ROOMS AND SPACES INCLUDING RESTROOMS, EXITS, ROOMS BY NUMBER.

ICC 2015 605.3.1 LABELING. DOORS INTO ELECTRICAL PANEL ROOMS SHALL BE MARKED WITH A PLAINLY VISIBLE AND LEGIBLE SIGN STATING "ELECTRICAL ROOM" OR SIMILAR APPROVED WORDING.

TACTILE AND BRAILLE CHARACTERS REQUIRED.

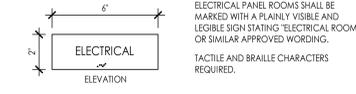

D3 ROOM IDENTIFICATION SIGNAGE
3" = 1'-0"

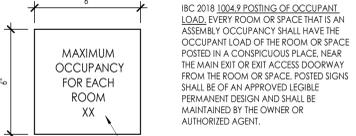


C3 OCCUPANCY SIGNAGE
3" = 1'-0"





B3 EXIT SIGNAGE
3" = 1'-0"



E2 ACCESSIBLE ELEMENT SIGNAGE
3" = 1'-0"

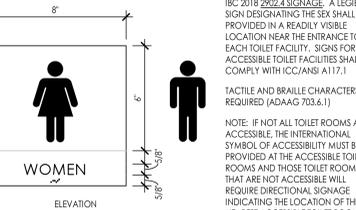

B2 WALL MOUNTED VAN SIGNAGE
1 1/2" = 1'-0"

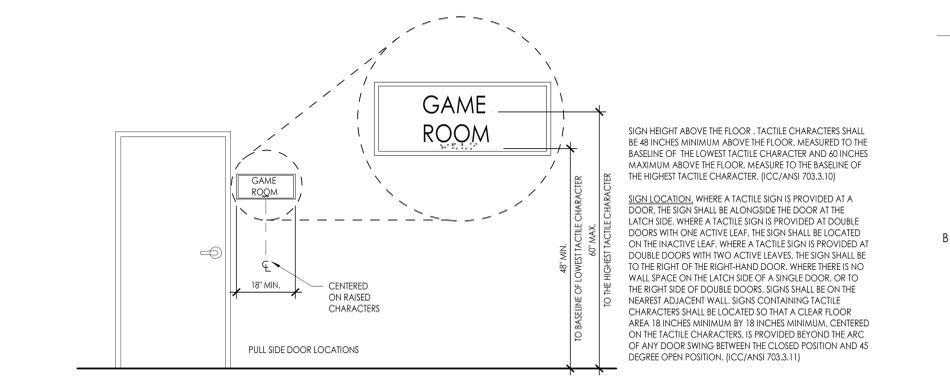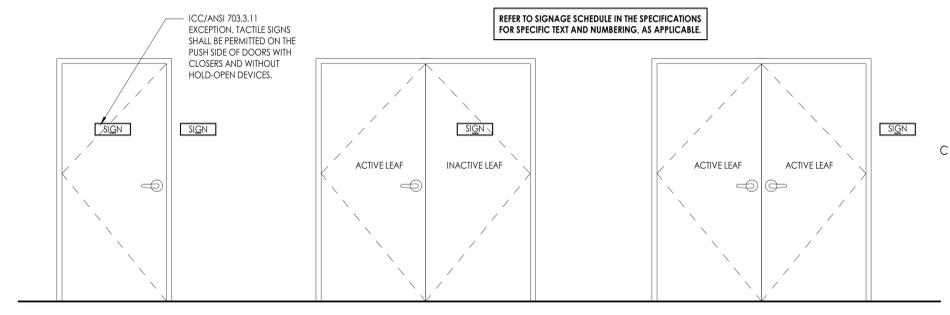

B5 SIGNAGE LOCATIONS
1/2" = 1'-0"

ICC/ANSI A117.1-2017
VISUAL CHARACTER HEIGHT
TABLE 703.2.4


HEIGHT ABOVE FLOOR TO BASELINE OF CHARACTER	HORIZONTAL VIEWING DISTANCE	HORIZONTAL VIEWING DISTANCE
40 INCHES TO LESS THAN OR EQUAL TO 70 INCHES	LESS THAN 6 FEET	5/8" INCH
	6 FEET AND GREATER	5/8 INCH, PLUS 1/8 INCH PER FOOT OF VIEWING DISTANCE ABOVE 6 FEET
GREATER THAN 70 INCHES TO LESS THAN OR EQUAL TO 120 INCHES	LESS THAN 15 FEET	2 INCHES
	15 FEET AND GREATER	2 INCHES, PLUS 1/8 INCH PER FOOT OF VIEWING DISTANCE ABOVE 15 FEET
GREATER THAN 120 INCHES	LESS THAN 21 FEET	3 INCHES
	21 FEET AND GREATER	3 INCH, PLUS 1/8 INCH PER FOOT OF VIEWING DISTANCE ABOVE 21 FEET

703.2.4 CHARACTER HEIGHT. THE UPPER-CASE LETTER 'Y' SHALL BE USED TO DETERMINE THE ALLOWABLE HEIGHT OF ALL CHARACTERS A FONT. THE HEIGHT OF THE UPPER-CASE LETTER 'Y' OF THE FONT, MEASURED VERTICALLY FROM THE BASELINE OF THE CHARACTER, SHALL HAVE A MINIMUM HEIGHT COMPLYING WITH TABLE 703.2.4.



A5 VISUAL CHARACTER HEIGHT
12" = 1'-0"


KEYED NOTES		
3.07	INFILL EXISTING RECESS IN CONCRETE SLAB WITH NEW CONCRETE	
12.01	FURNISHINGS BY OTHERS	
D2.87	EXISTING WATER HEATER TO REMAIN	
D2.88	EXISTING SLUMP PUMP TO REMAIN	

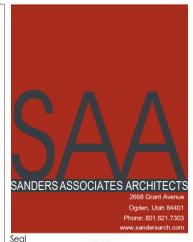

General Contractor

STACEY CONSTRUCTION
Stacey Construction
Construction Manager
General Contractor
3768 Pacific Ave.
Ogden, UT 84405
801.621.6210
www.staceycg.com

Consultant

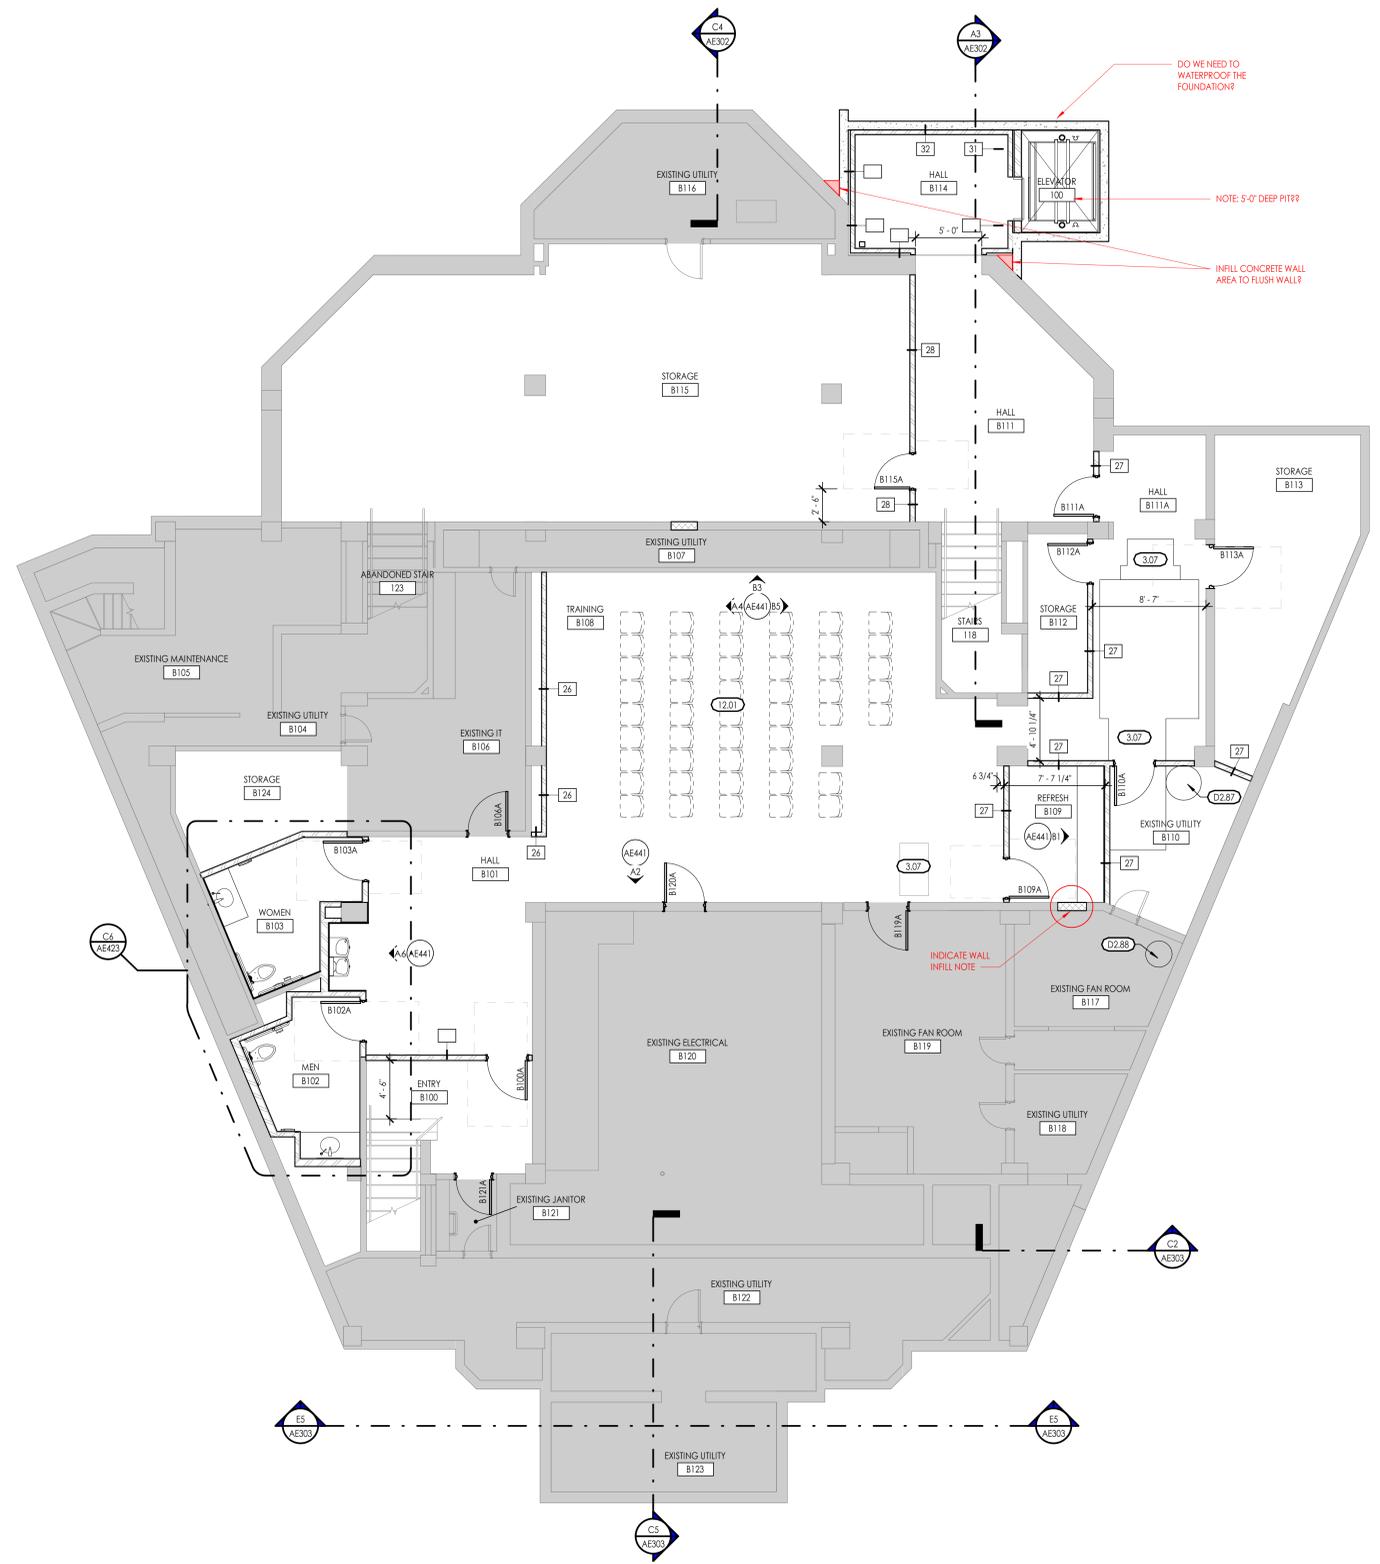


DO WE NEED TO WATERPROOF THE FOUNDATION?

NOTE: 5'-0" DEEP PIT??

INFILL CONCRETE WALL AREA TO FLUSH WALL?

INDICATE WALL INFILL NOTE

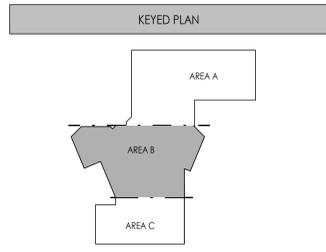

BASEMENT FLOOR PLAN
3/16" = 1'-0"

OGDEN-HINCKLEY AIRPORT
TERMINAL EXPANSION
3909 AIRPORT ROAD
OGDEN, UT 84405

Project Name

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No.	Date	Description
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SAA Project No. 2021-10
Drawing Title

BASEMENT FLOOR PLAN

Sheet Number

AE105

KEYED NOTES

SEE KEYED NOTES - MASTER LIST ON SHEET G002 IF KEYNOTE MISSING

8.05 SLIDING GLASS DOORS. TSA HAS REQUIRED THE ROOM TO BE LOCKED DOWN WHEN NOT IN USE AND ALSO REQUIRE THE SLIDING DOORS TO BE OPENED DURING OPERATION HOURS


11.01 SURFACE MOUNTED TV, BY OWNER, VERIFY SIZE

11.05 FREE-STANDING STANCHION WITH RETRACTABLE BELT, BY OWNER

11.08 VENDING MACHINES, BY OWNER, VERIFY SIZE & POWER REQUIREMENTS

12.01 FURNISHINGS BY OTHERS

32.01 6" DIAMETER PIPE BOLLARD FILLED WITH CONCRETE. REFER TO DETAILS, TYP.

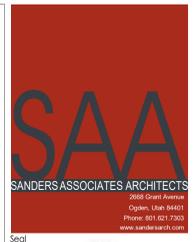


General Contractor



STACEY CONSTRUCTION

Stacey Construction
Construction Manager
General Contractor
376B Pacific Ave.
Ogden, UT 84405
801.521.6210
www.staceygc.com

Consultant

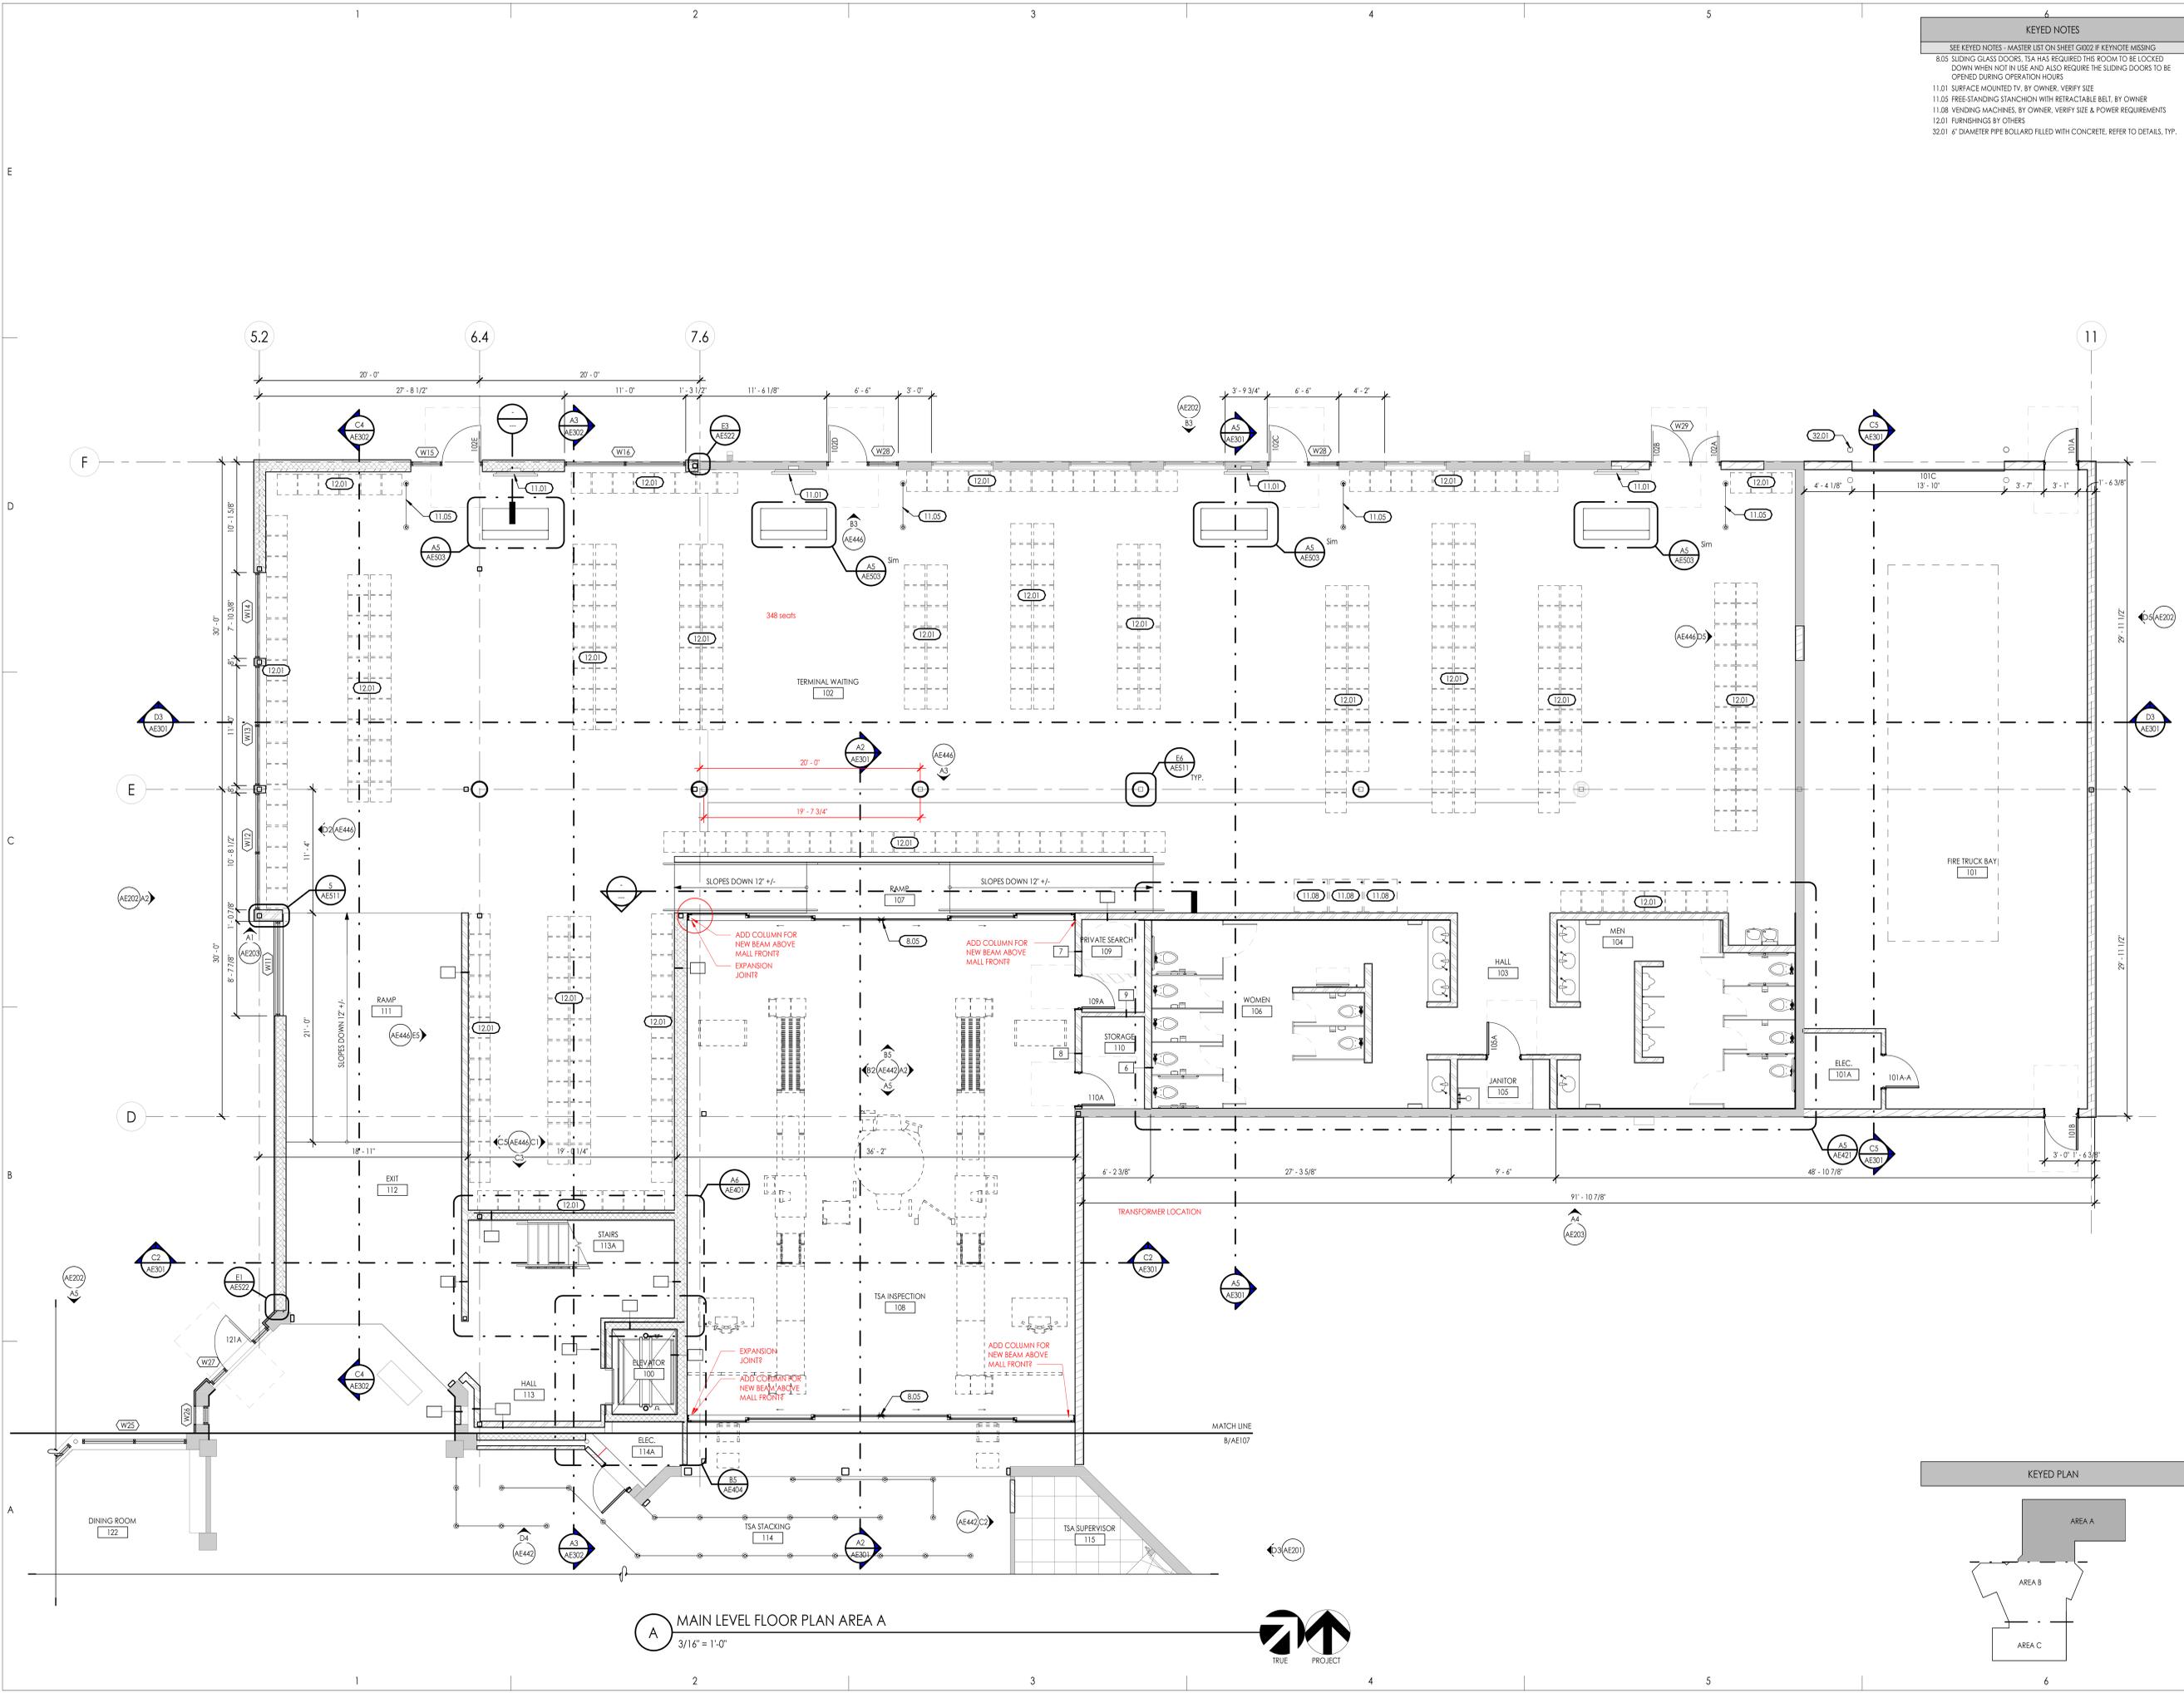

A MAIN LEVEL FLOOR PLAN AREA A
3/16" = 1'-0"

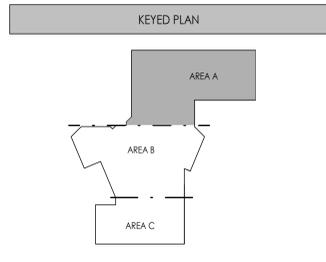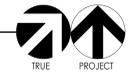

Project Name
**OGDEN-HINCKLEY AIRPORT
TERMINAL EXPANSION**

3909 AIRPORT ROAD
OGDEN, UT 84405

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**MAIN LEVEL FLOOR
PLAN AREA A**


Sheet Number

AE106


KEYED NOTES
 SEE KEYED NOTES - MASTER LIST ON SHEET G002 IF KEYNOTE MISSING
 3.08 CONCRETE BENCH, REFER TO DETAILS
 11.07 BAGGAGE CAROUSEL, BY OWNER, VERIFY SIZE & POWER REQUIREMENTS
 32.01 6" DIAMETER PIPE BOLLARD FILLED WITH CONCRETE, REFER TO DETAILS, TYP.

ENVELOPE GENERAL NOTES



- PRE-CONSTRUCTION CONFERENCE: PRIOR TO THE START OF SUBMITTALS, AN ENVELOPE PRE-CONSTRUCTION CONFERENCE IS TO BE CONDUCTED TO REVIEW INSTALLATION METHODS AND MATERIAL COMPATIBILITY WITH ALL ASSOCIATED ENVELOPE CONTRACTORS. WORK OF THE SPECIFICATION SECTIONS DEALING WITH THE ENVELOPE ARE TO INCLUDE, BUT NOT LIMITED TO, THE FOLLOWING: 07230 - WEATHER BARRIERS, 07210 - MALLBASE ROOF INSULATION PANELS, 07276 - FLUID-APPLIED MEMBRANE AIR BARRIERS, 07201 - CONTINUOUS THERMAL INSULATION, 075423 SF - THERMOPLASTIC POLYOLEFIN (TPO) ROOFING, 084413 FL - GLAZED ALUMINUM CURTAIN WALLS.
- PROVIDE ICC-ES EVALUATION REPORTS FOR ALL MATERIAL INSTALLATIONS.
- PROVIDE A LETTER OF MATERIAL COMPATIBILITY TO OTHER ENVELOPE SYSTEM MATERIALS.
- THE INSTALLED AIR BARRIER ON THE BUILDING IS REQUIRED TO BE CONTINUOUS, SEAL ALL PENETRATIONS, JOINTS AND FLASHING AS REQUIRED BY MATERIAL MANUFACTURERS INSTRUCTIONS.
- CONTRACTORS ARE RESPONSIBLE FOR ALL WORK REGARDLESS OF THE LOCATION OF THE INFORMATION ON THE DOCUMENTS.
- INSTALL SEALANT, GASKETS, WEATHER STRIPPING OR WRAPPING WITH PERMISSIBLE FLASHING AT EXTERIOR SIDE OF ALL JOINTS, SEAMS, CONNECTIONS OR OPENINGS WHICH WOULD ALLOW WATER OR AIR INFILTRATION EXCEPT AS NOTED OTHERWISE. COLORS TO MATCH ADJACENT SURFACE. COLOR REQUIRES ARCHITECT'S APPROVAL.
- THE CONTRACTOR IS RESPONSIBLE FOR PROVIDING A WEATHER TIGHT BUILDING, DETAILS AND OMISSIONS TO DRAWINGS NOTWITHSTANDING, ALL DRAWING CONFLICTS WHICH MAY NOT ALLOW A WEATHER TIGHT CONDITION SHALL BE BROUGHT TO THE ATTENTION OF THE ARCHITECT.
- THE DRAWINGS AND SPECIFICATIONS DO NOT NECESSARILY INDICATE OR DESCRIBE ALL WORK REQUIRED FOR THE FULL PERFORMANCE AND COMPLETION OF THE WORK. CONTRACTORS SHALL BE LET ON THE BASIS OF SUCH DOCUMENTS, WITH THE UNDERSTANDING THAT THE CONTRACTOR IS TO FURNISH ALL ITEMS REQUIRED FOR PROPER COMPLETION OF THE WORK WITH OUT ADJUSTMENT TO CONTRACT PRICE. IT IS INTENDED THAT THE WORK TO BE OF SOUND AND QUALITY CONSTRUCTION AND THE CONTRACTOR SHALL BE SOLELY RESPONSIBLE FOR THE INCLUSION OF ADEQUATE AMOUNTS TO COVER INSTALLATION OF ALL ITEMS INDICATED, DESCRIBED OR REASONABLY IMPLIED.
- EXTERIOR FENESTRATION CALCULATIONS:
 - NORTH WALL: 4881 SF FENESTRATION 1510 SF
 - EAST WALL: 4056 SF FENESTRATION 339 SF
 - SOUTH WALL: 5950 FENESTRATION 1722 SF
 - WEST WALL: 4278 SF FENESTRATION 854 SF
 - PERCENTAGE OF FENESTRATION ON EXTERIOR WALLS: 4425 2514 S 100 17.4%
- STOREFRONT GLAZING: SOLARBAN 70 SOLEXIA H/S C-2: 0.28 U-FACTOR, 0.27 SHGC
- GLAZING ASSEMBLIES:
 - STOREFRONT ASSEMBLY: KAWNEER TRIFAB 401UT: 0.37 U-FACTOR, 0.16 SHGC. PRODUCTS TO BE RATED AS REQUIRED BY NFRC.
 - STOREFRONT ASSEMBLY: KAWNEER TRIFAB 451UT: 0.34 U-FACTOR, 0.25 SHGC. PRODUCTS TO BE RATED AS REQUIRED BY NFRC.
- EXTERIOR STOREFRONT DOORS:
 - KAWNEER 500 PAIR: 0.74 U-FACTOR, 0.16 SHGC. PRODUCTS TO BE RATED AS REQUIRED BY NFRC.
 - KAWNEER 560 INSULCLAD SINGLE DOOR: 0.48 U-FACTOR, 0.18 SHGC. PRODUCTS TO BE RATED AS REQUIRED BY NFRC.
- EXTERIOR WALLS:
 - 1" EPS / WOOD STUD WALL AREA: 1" EPS INSULATION BOARD (R-4 MINIMUM VALUE AT 40 DEGREES), OVER EXTERIOR PLYWOOD SHEATHING WITH FLUID-APPLIED WRB, OVER 2X8" WOOD STUD FRAMING & R-19 BATT INSULATION.
 - 2" EPS / CMU WALL AREA: 2" EPS INSULATION BOARD (R-8 MINIMUM VALUE AT 40 DEGREES), OVER 8" CMU WITH FLUID-APPLIED WRB, OVER 2 1/2" METAL STUD FURRING.
 - 7/8" THIN BRICK VENEER ADHERED TO SPEEDY MASON PANEL OVER 1" INSULATION BOARD (R-5 MINIMUM VALUE AT 40 DEGREES), OVER 8" CMU WITH FLUID-APPLIED WRB, OVER 2 1/2" METAL STUD FURRING.
 - METAL WALL PANEL / CMU WALL AREA: COMPOSITE METAL PANEL, OVER 8" CMU WITH FLUID-APPLIED WRB, OVER 2 1/2" METAL STUD FURRING.
 - 2" EPS / METAL STUD WALL AREA: 2" EPS INSULATION BOARD (R-8 MINIMUM VALUE AT 40 DEGREES), OVER EXTERIOR GYPSUM SHEATHING WITH FLUID-APPLIED WRB, OVER 6" METAL STUD FRAMING & R-19 BATT INSULATION.
 - 7/8" THIN BRICK VENEER ADHERED TO SPEEDY MASON PANEL OVER 1" INSULATION BOARD (R-5 MINIMUM VALUE AT 40 DEGREES), OVER EXTERIOR GYPSUM SHEATHING WITH FLUID-APPLIED WRB, OVER 6" METAL STUD FRAMING & R-19 BATT INSULATION.
 - BRICK / METAL STUD WALL AREA: FULL-BED BRICK OVER 1" AIR GAP, OVER 1 1/2" INSULATION BOARD (R-7.5 MINIMUM VALUE AT 40 DEGREES), OVER EXTERIOR GYPSUM SHEATHING WITH FLUID-APPLIED WRB, OVER 6" METAL STUD FRAMING & R-19 BATT INSULATION.
 - METAL WALL PANEL / METAL STUD WALL AREA: COMPOSITE METAL PANEL, OVER 2" RIGID POLYSTYRENE INSULATION (R-9.6 VALUE AT 40 DEGREES) WITH FLUID-APPLIED WRB, OVER EXTERIOR GYPSUM SHEATHING, OVER 6" METAL STUD FRAMING & R-19 BATT INSULATION.
- ROOF INSULATION: CLOSED CELL POLYSTYRENE FOAM BOARD R-38 INSULATION WITH TAPERED EPS BOARD CRICKETS ABOVE STEEL DECK, WATER-AIR BARRIER, LOCATED ABOVE STEEL ROOF DECK, TAPED AND FLASHED TO WALL; VERSICO VAPAIR SEAL MD, 0.03 PERMS, OR APPROVED EQUAL.
- PERIMETER FOUNDATION INSULATION: (NOT REQUIRED)
- FLUID APPLIED MEMBRANE AIR BARRIER: PROVIDE SEALED FLUID APPLIED MEMBRANE AIR BARRIER THAT HAS PERMEABILITY ≤ 0.004 DPM/5F

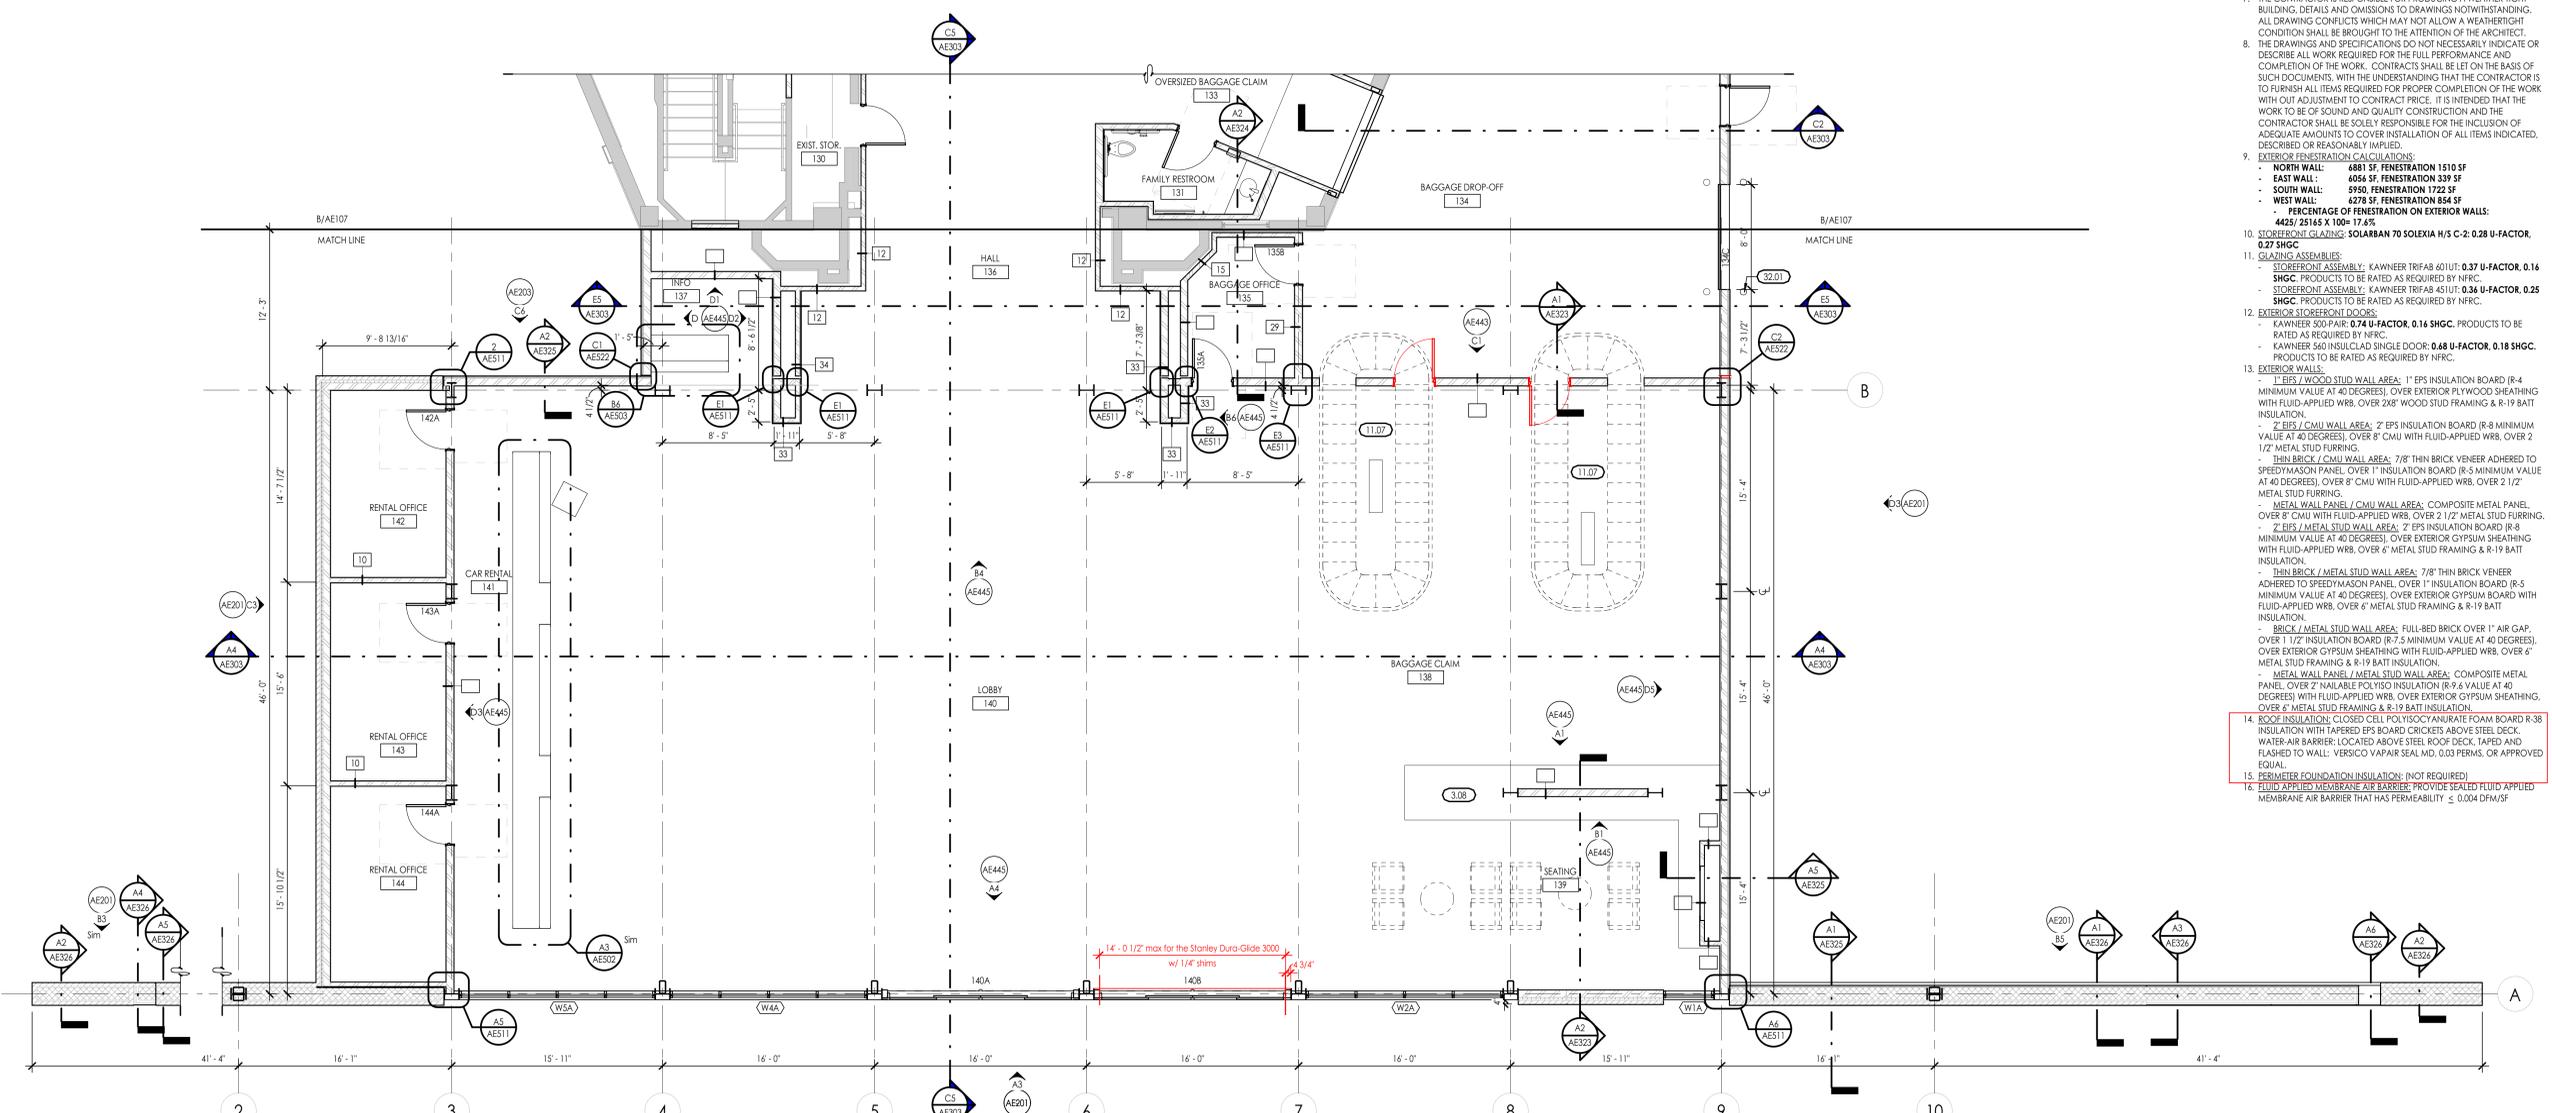

KEYED PLAN

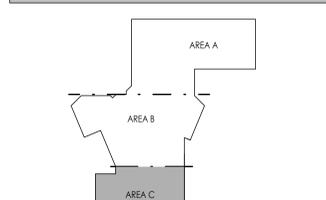

C MAIN LEVEL FLOOR PLAN AREA C
 3/16" = 1'-0"

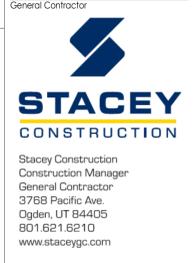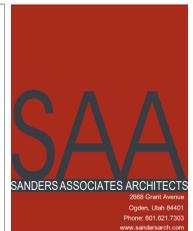

OGDEN-HINCKLEY AIRPORT
TERMINAL EXPANSION
 3909 AIRPORT ROAD
 OGDEN, UT 84405

Project Name

Issued No.	Date	Description
1	11-15-2022	BID SET

Revision


No.	Date	Description

SAA Project No. 2021-10
 Drawing Title

MAIN LEVEL FLOOR PLAN AREA C


Sheet Number

AE108

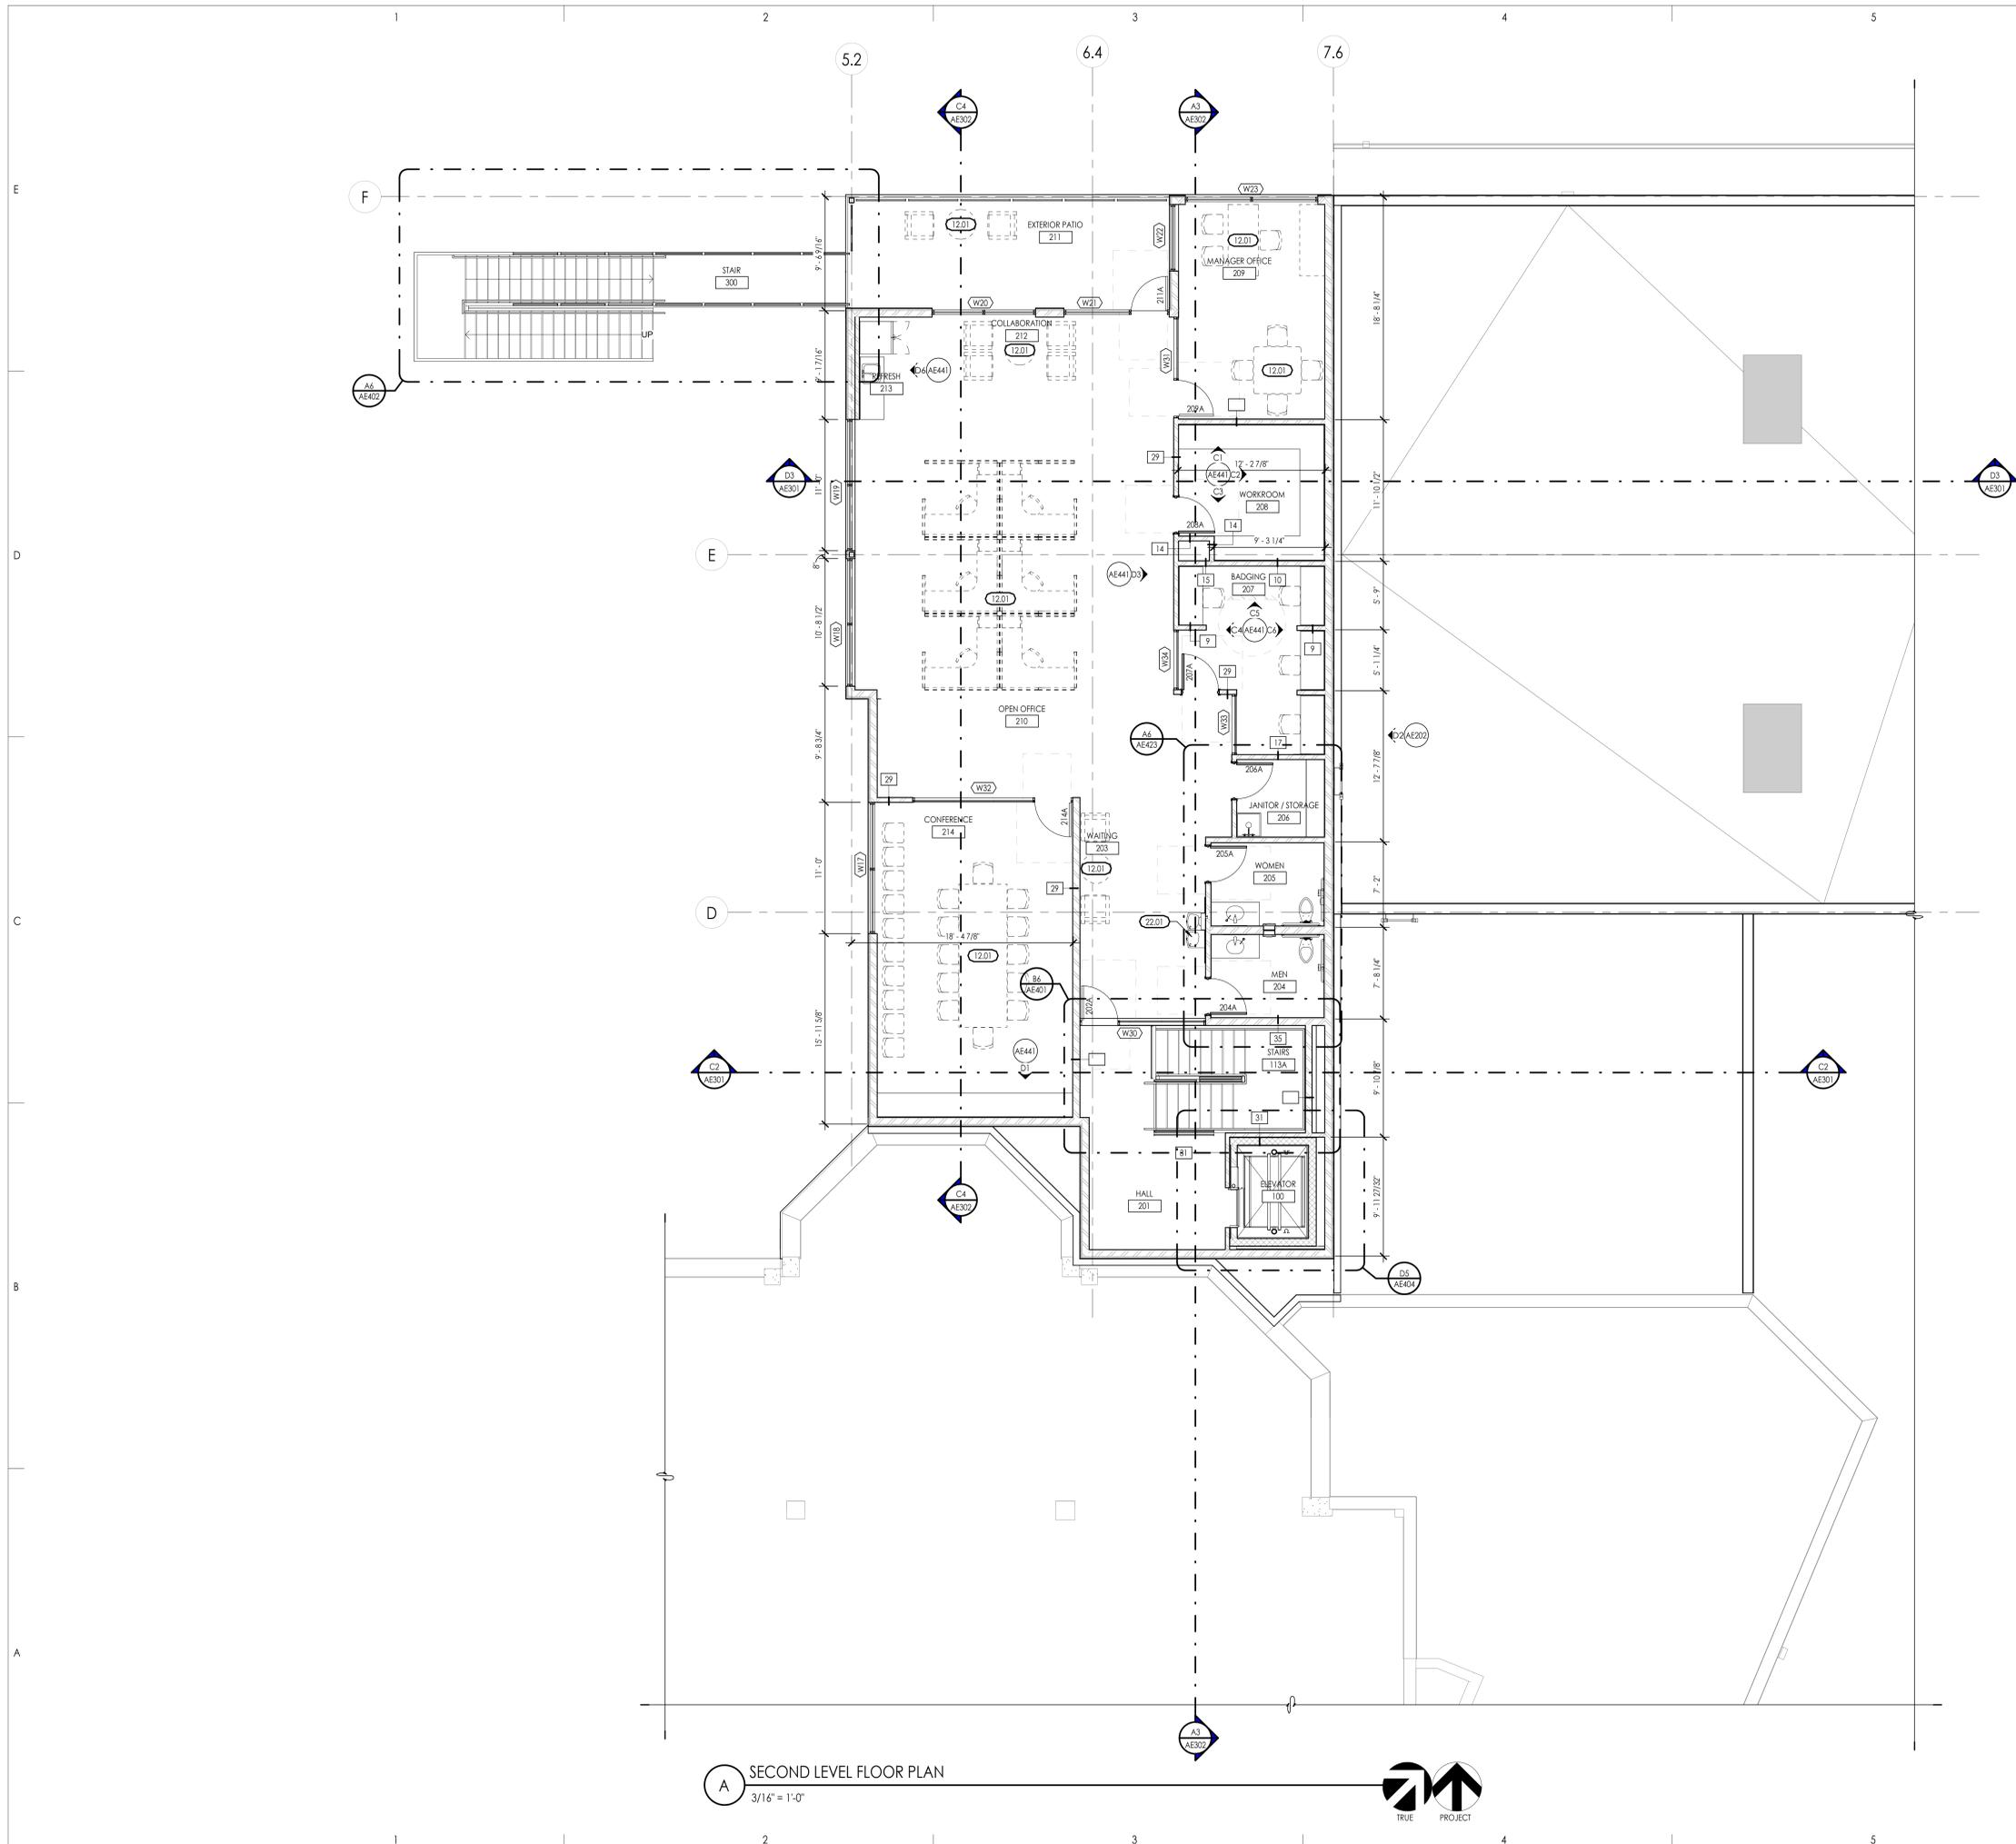


KEYED NOTES
 SEE KEYED NOTES - MASTER LIST ON SHEET G002 IF KEYNOTE MISSING
 12.01 FURNISHINGS BY OTHERS
 22.01 HIGH-LOW DRINKING FOUNTAIN WITH BOTTLE FILLER & CANE-DETECTABLE BARRIER. REFER TO PLUMBING

- ENVELOPE GENERAL NOTES**
- PRE-CONSTRUCTION CONFERENCE: PRIOR TO THE START OF SUBMITTALS, AN ENVELOPE PRE-CONSTRUCTION CONFERENCE IS TO BE CONDUCTED TO REVIEW INSTALLATION METHODS AND MATERIAL COMPATIBILITY WITH ALL ASSOCIATED ENVELOPE CONTRACTORS. WORK OF THE SPECIFICATION SECTIONS DEALING WITH THE ENVELOPE ARE TO INCLUDE, BUT NOT LIMITED TO, THE FOLLOWING: 07200 - WEATHER BARRIERS, 07220 - NAIL-BASE ROOF INSULATION PANELS, 07276 - FLUID-APPLIED MEMBRANE AIR BARRIERS, 07201 - CONTINUOUS THERMAL INSULATION, 07420 - THERMOPLASTIC POLYOLEFIN (TPO) ROOFING, 08413 FL - GLAZED ALUMINUM CURTAIN WALLS.
 - PROVIDE ICC-ES EVALUATION REPORTS FOR ALL MATERIAL INSTALLATIONS.
 - PROVIDE A LETTER OF MATERIAL COMPATIBILITY TO OTHER ENVELOPE SYSTEM MATERIALS.
 - THE INSTALLED AIR BARRIER ON THE BUILDING IS REQUIRED TO BE CONTINUOUS SEAL ALL PENETRATIONS, JOINTS AND FLASHINGS AS REQUIRED BY MATERIAL MANUFACTURERS INSTRUCTIONS.
 - CONTRACTORS ARE RESPONSIBLE FOR ALL WORK REGARDLESS OF THE LOCATION OF THE INFORMATION ON THE DOCUMENTS.
 - INSTALL SEALANT, GASKETS, WEATHER STRIPPING OR WRAPPING WITH PERMEABLE FLASHING AT EXTERIOR SIDE OF ALL JOINTS, SEAMS, CONNECTIONS OR OPENINGS WHICH WOULD ALLOW WATER OR AIR INFILTRATION EXCEPT AS NOTED OTHERWISE. COLORS TO MATCH ADJACENT SURFACE. COLOR REQUIRES ARCHITECT'S APPROVAL.
 - THE CONTRACTOR IS RESPONSIBLE FOR PRODUCING A WEATHER TIGHT BUILDING. DETAILS AND OMISSIONS TO DRAWINGS NOTWITHSTANDING, ALL DRAWING CONFLICTS WHICH MAY NOT ALLOW A WEATHER TIGHT CONDITION SHALL BE BROUGHT TO THE ATTENTION OF THE ARCHITECT.
 - THE DRAWINGS AND SPECIFICATIONS DO NOT NECESSARILY INDICATE OR DESCRIBE ALL WORK REQUIRED FOR THE FULL PERFORMANCE AND COMPLETION OF THE WORK. CONTRACTS SHALL BE LET ON THE BASIS OF SUCH DOCUMENTS, WITH THE UNDERSTANDING THAT THE CONTRACTOR IS TO FURNISH ALL ITEMS REQUIRED FOR PROPER COMPLETION OF THE WORK WITH OUT ADJUSTMENT TO CONTRACT PRICE. IT IS INTENDED THAT THE WORK TO BE OF SOUND AND QUALITY CONSTRUCTION AND THE CONTRACTOR SHALL BE SOLELY RESPONSIBLE FOR THE INCLUSION OF ADEQUATE AMOUNTS TO COVER INSTALLATION OF ALL ITEMS INDICATED, DESCRIBED OR REASONABLY IMPLIED.
 - EXTERIOR FENESTRATION CALCULATIONS:**
 - NORTH WALL:** 681 SF FENESTRATION 1510 SF
 - EAST WALL:** 605 SF FENESTRATION 339 SF
 - SOUTH WALL:** 990 SF FENESTRATION 1722 SF
 - WEST WALL:** 427 SF FENESTRATION 854 SF
 - PERCENTAGE OF FENESTRATION ON EXTERIOR WALLS:** 4425 / 25165 X 100 = 17.6%
 - STOREFRONT GLAZINGS:** SOLARBAN 70 SOLEXIA W/S C-2: 0.28 U-FACTOR, 0.27 SHGC.
 - GLAZING ASSEMBLIES:**
 - STOREFRONT ASSEMBLY:** KAWNEER TRIFAB 401UT: 0.37 U-FACTOR, 0.16 SHGC. PRODUCTS TO BE RATED AS REQUIRED BY NFRC.
 - STOREFRONT ASSEMBLY:** KAWNEER TRIFAB 451UT: 0.34 U-FACTOR, 0.25 SHGC. PRODUCTS TO BE RATED AS REQUIRED BY NFRC.
 - EXTERIOR STOREFRONT DOORS:**
 - KAWNEER 500-PAIR: 0.74 U-FACTOR, 0.16 SHGC. PRODUCTS TO BE RATED AS REQUIRED BY NFRC.
 - KAWNEER 500 INSULATED SINGLE DOOR: 0.68 U-FACTOR, 0.18 SHGC. PRODUCTS TO BE RATED AS REQUIRED BY NFRC.
 - EXTERIOR WALLS:**
 - 1" EPS / WOOD STUD WALL AREA:** 1" EPS INSULATION BOARD (R-4 MINIMUM VALUE AT 40 DEGREES), OVER EXTERIOR PLYWOOD SHEATHING WITH FLUID-APPLIED WRB, OVER 2x8" WOOD STUD FRAMING & R-19 BATT INSULATION.
 - 2" EPS / CMU WALL AREA:** 2" EPS INSULATION BOARD (R-8 MINIMUM VALUE AT 40 DEGREES), OVER 8" CMU WITH FLUID-APPLIED WRB, OVER 2 1/2" METAL STUD FURRING.
 - THIN BRICK / CMU WALL AREA:** 7/8" THIN BRICK VENER ADHERED TO SPEEDY MASON PANEL OVER 1" INSULATION BOARD (R-5 MINIMUM VALUE AT 40 DEGREES), OVER EXTERIOR GYPSUM SHEATHING WITH FLUID-APPLIED WRB, OVER 8" METAL STUD FRAMING & R-19 BATT INSULATION.
 - METAL WALL PANEL / CMU WALL AREA:** COMPOSITE METAL PANEL, OVER 8" CMU WITH FLUID-APPLIED WRB, OVER 2 1/2" METAL STUD FURRING.
 - 2" EPS / METAL STUD WALL AREA:** 2" EPS INSULATION BOARD (R-8 MINIMUM VALUE AT 40 DEGREES), OVER EXTERIOR GYPSUM SHEATHING WITH FLUID-APPLIED WRB, OVER 8" METAL STUD FRAMING & R-19 BATT INSULATION.
 - THIN BRICK / METAL STUD WALL AREA:** 7/8" THIN BRICK VENER ADHERED TO SPEEDY MASON PANEL, OVER 1" INSULATION BOARD (R-5 MINIMUM VALUE AT 40 DEGREES), OVER EXTERIOR GYPSUM SHEATHING WITH FLUID-APPLIED WRB, OVER 8" METAL STUD FRAMING & R-19 BATT INSULATION.
 - BRICK / METAL STUD WALL AREA:** FULL-RED BRICK OVER 1" AIR GAP, OVER 1 1/2" INSULATION BOARD (R-7.5 MINIMUM VALUE AT 40 DEGREES), OVER EXTERIOR GYPSUM SHEATHING WITH FLUID-APPLIED WRB, OVER 6" METAL STUD FRAMING & R-19 BATT INSULATION.
 - METAL WALL PANEL / METAL STUD WALL AREA:** COMPOSITE METAL PANEL, OVER 2" NAILED POLYISO INSULATION (R-9.6 VALUE AT 40 DEGREES) WITH FLUID-APPLIED WRB, OVER EXTERIOR GYPSUM SHEATHING, OVER 6" METAL STUD FRAMING & R-19 BATT INSULATION.
 - ROOF INSULATION:** CLOSED CELL POLYISOCYANURATE FOAM BOARD R-38 INSULATION WITH TAPERED EPS BOARD CRICKETS ABOVE STEEL DECK, WATER-AIR BARRIER (LOCATED ABOVE STEEL ROOF DECK, TAPED AND FLASHED TO WALL: VERSICO VAPAR SEAL MD, 0.03 PERMS, OR APPROVED EQUAL.
 - PERIMETER FOUNDATION INSULATION: (NOT REQUIRED)
 - FLUID APPLIED MEMBRANE AIR BARRIER: PROVIDE SEALED FLUID APPLIED MEMBRANE AIR BARRIER THAT HAS PERMEABILITY ≤ 0.004 DFM/SF

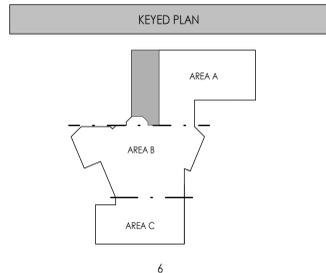

SECOND LEVEL FLOOR PLAN
 3/16" = 1'-0"

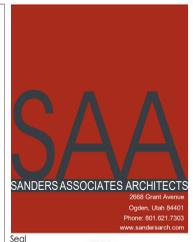


Project Name
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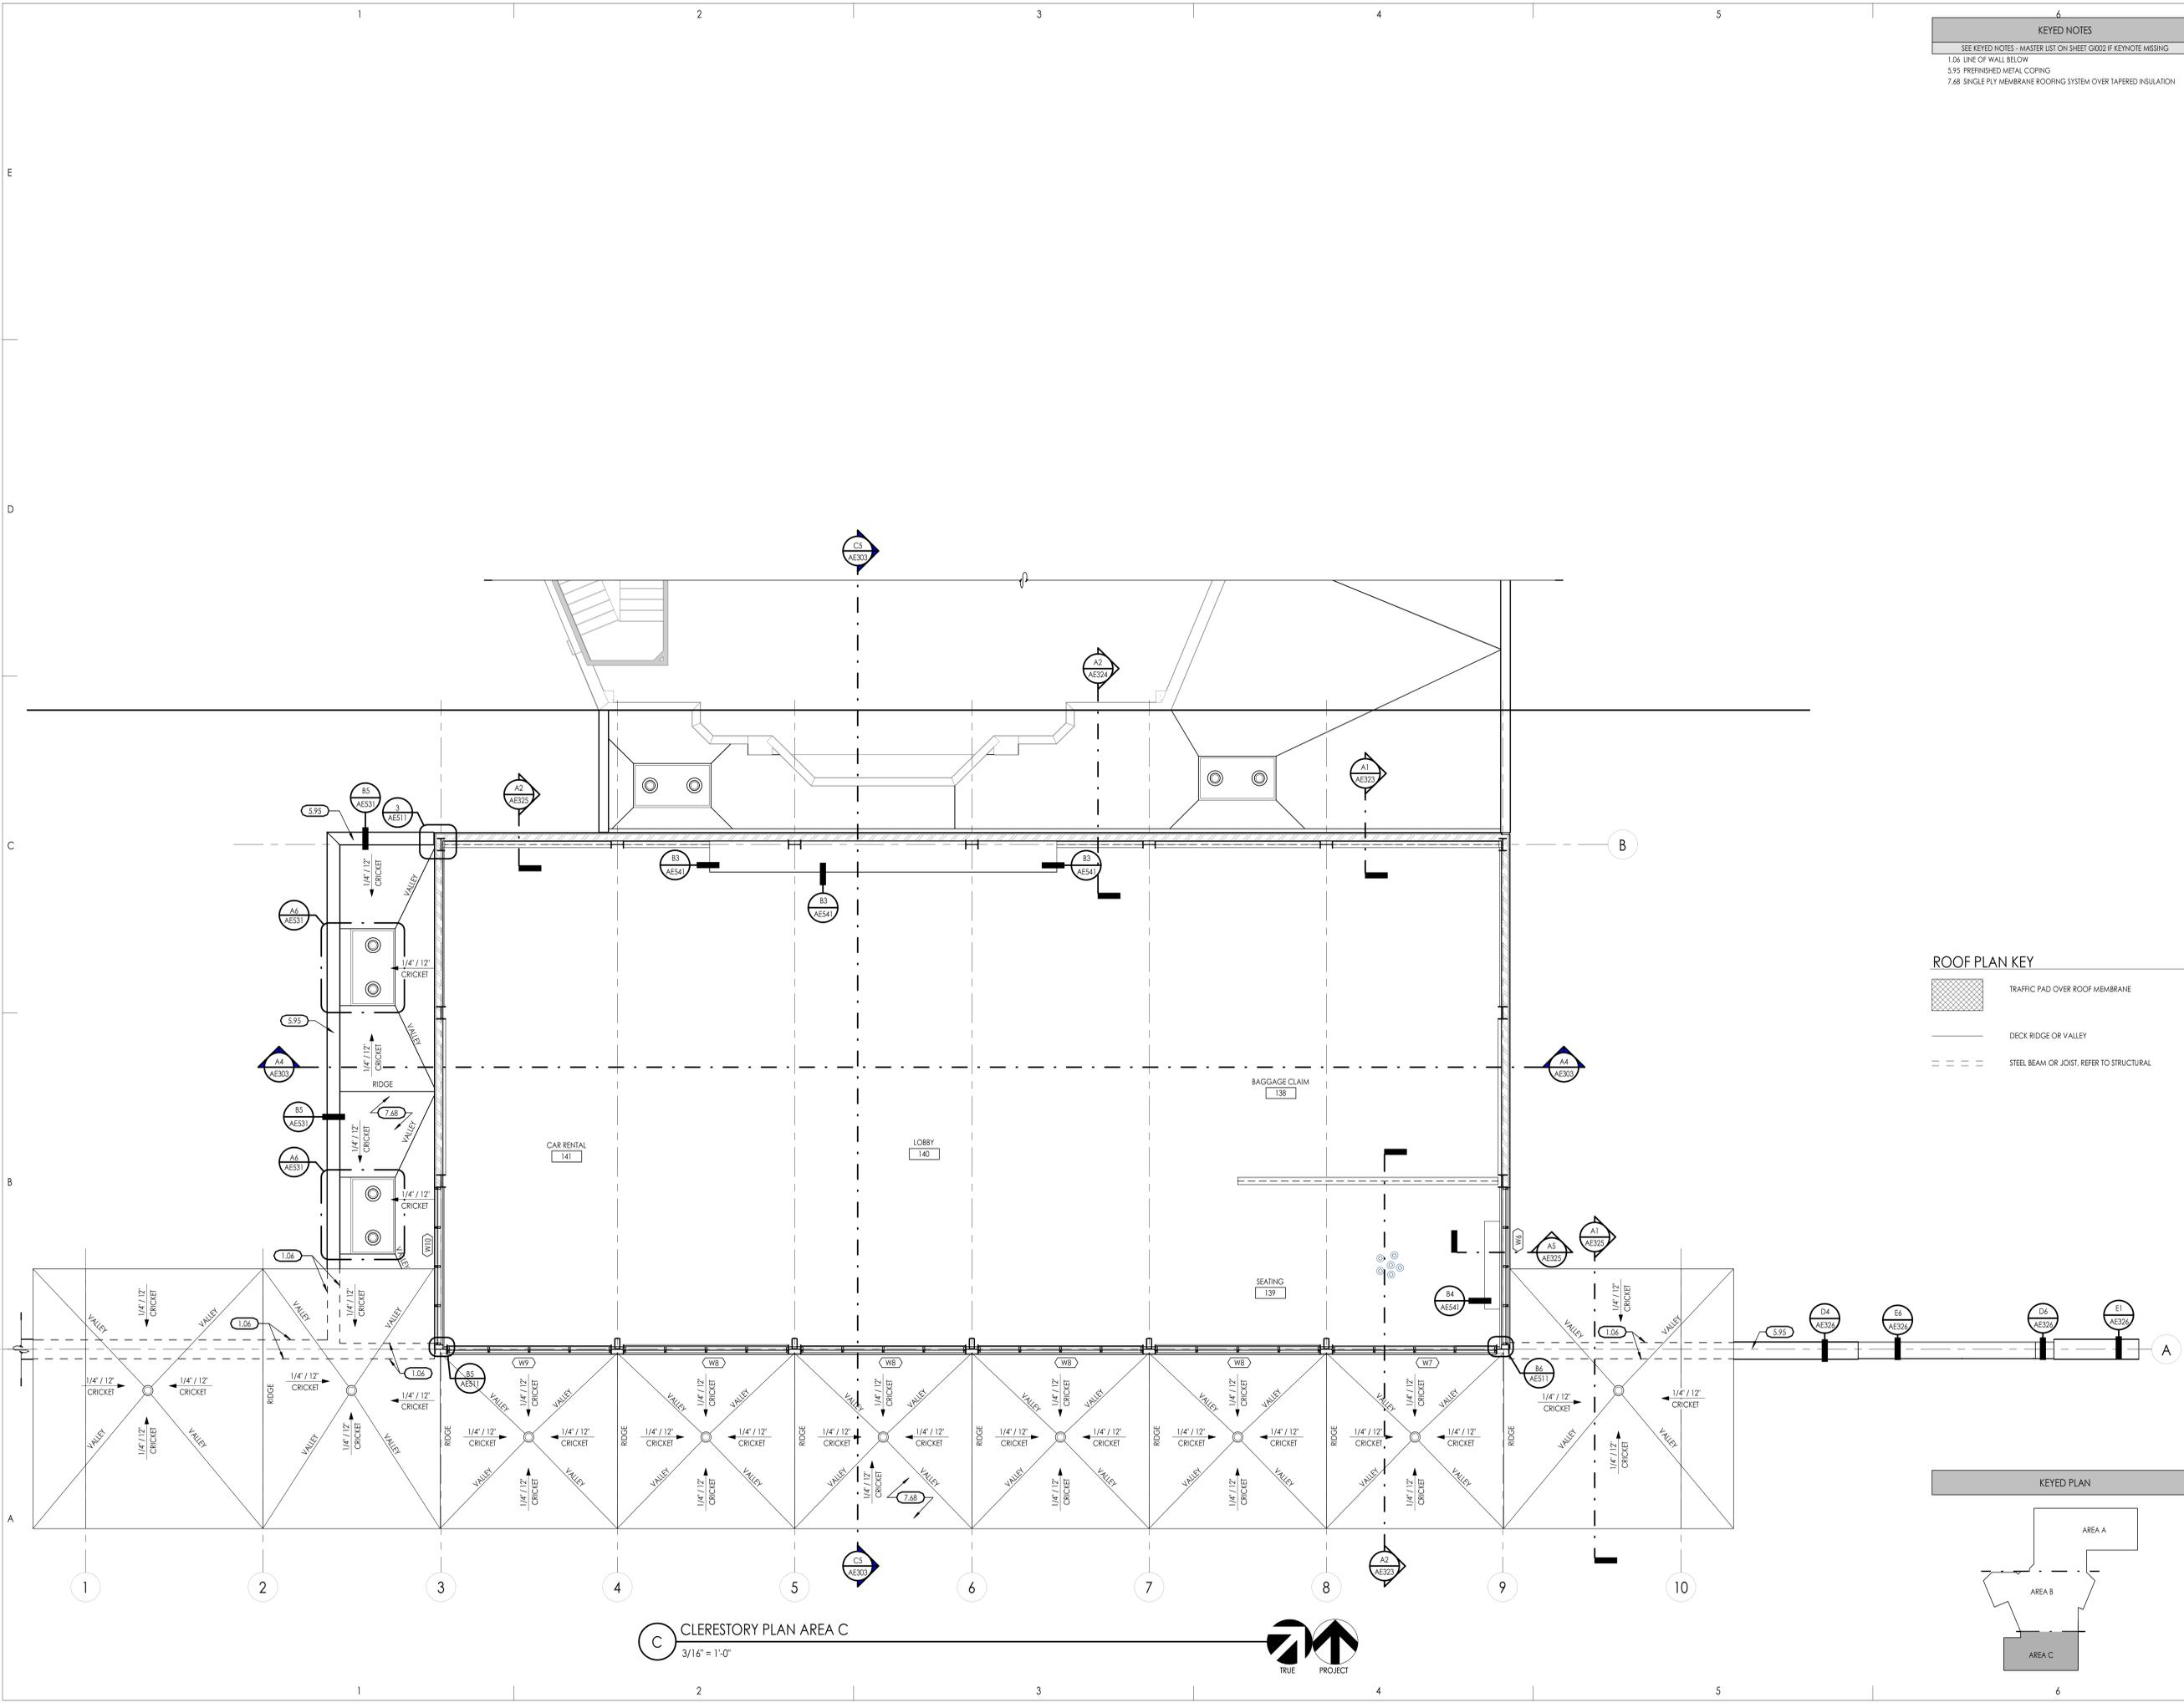
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No.	Date	Description
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No.	Date	Description

SAA Project No. 2021-10
 Drawing Title
SECOND LEVEL FLOOR PLAN
 Sheet Number
AE109

KEYED NOTES
 SEE KEYED NOTES - MASTER LIST ON SHEET G002 IF KEYNOTE MISSING
 1.06 LINE OF WALL BELOW
 5.95 PREFINISHED METAL COPING
 7.68 SINGLE PLY MEMBRANE ROOFING SYSTEM OVER TAPERED INSULATION

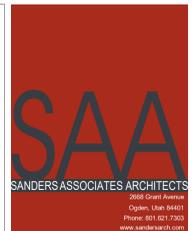


General Contractor
STACEY CONSTRUCTION
 Stacey Construction
 Construction Manager
 General Contractor
 3768 Pacific Ave.
 Ogden, UT 84405
 801.621.6210
 www.staceygc.com
 Consultant



ROOF PLAN KEY

- TRAFFIC PAD OVER ROOF MEMBRANE
- DECK RIDGE OR VALLEY
- STEEL BEAM OR JOIST, REFER TO STRUCTURAL

(C) CLERESTORY PLAN AREA C
 3/16" = 1'-0"

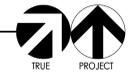

OGDEN-HINCKLEY AIRPORT
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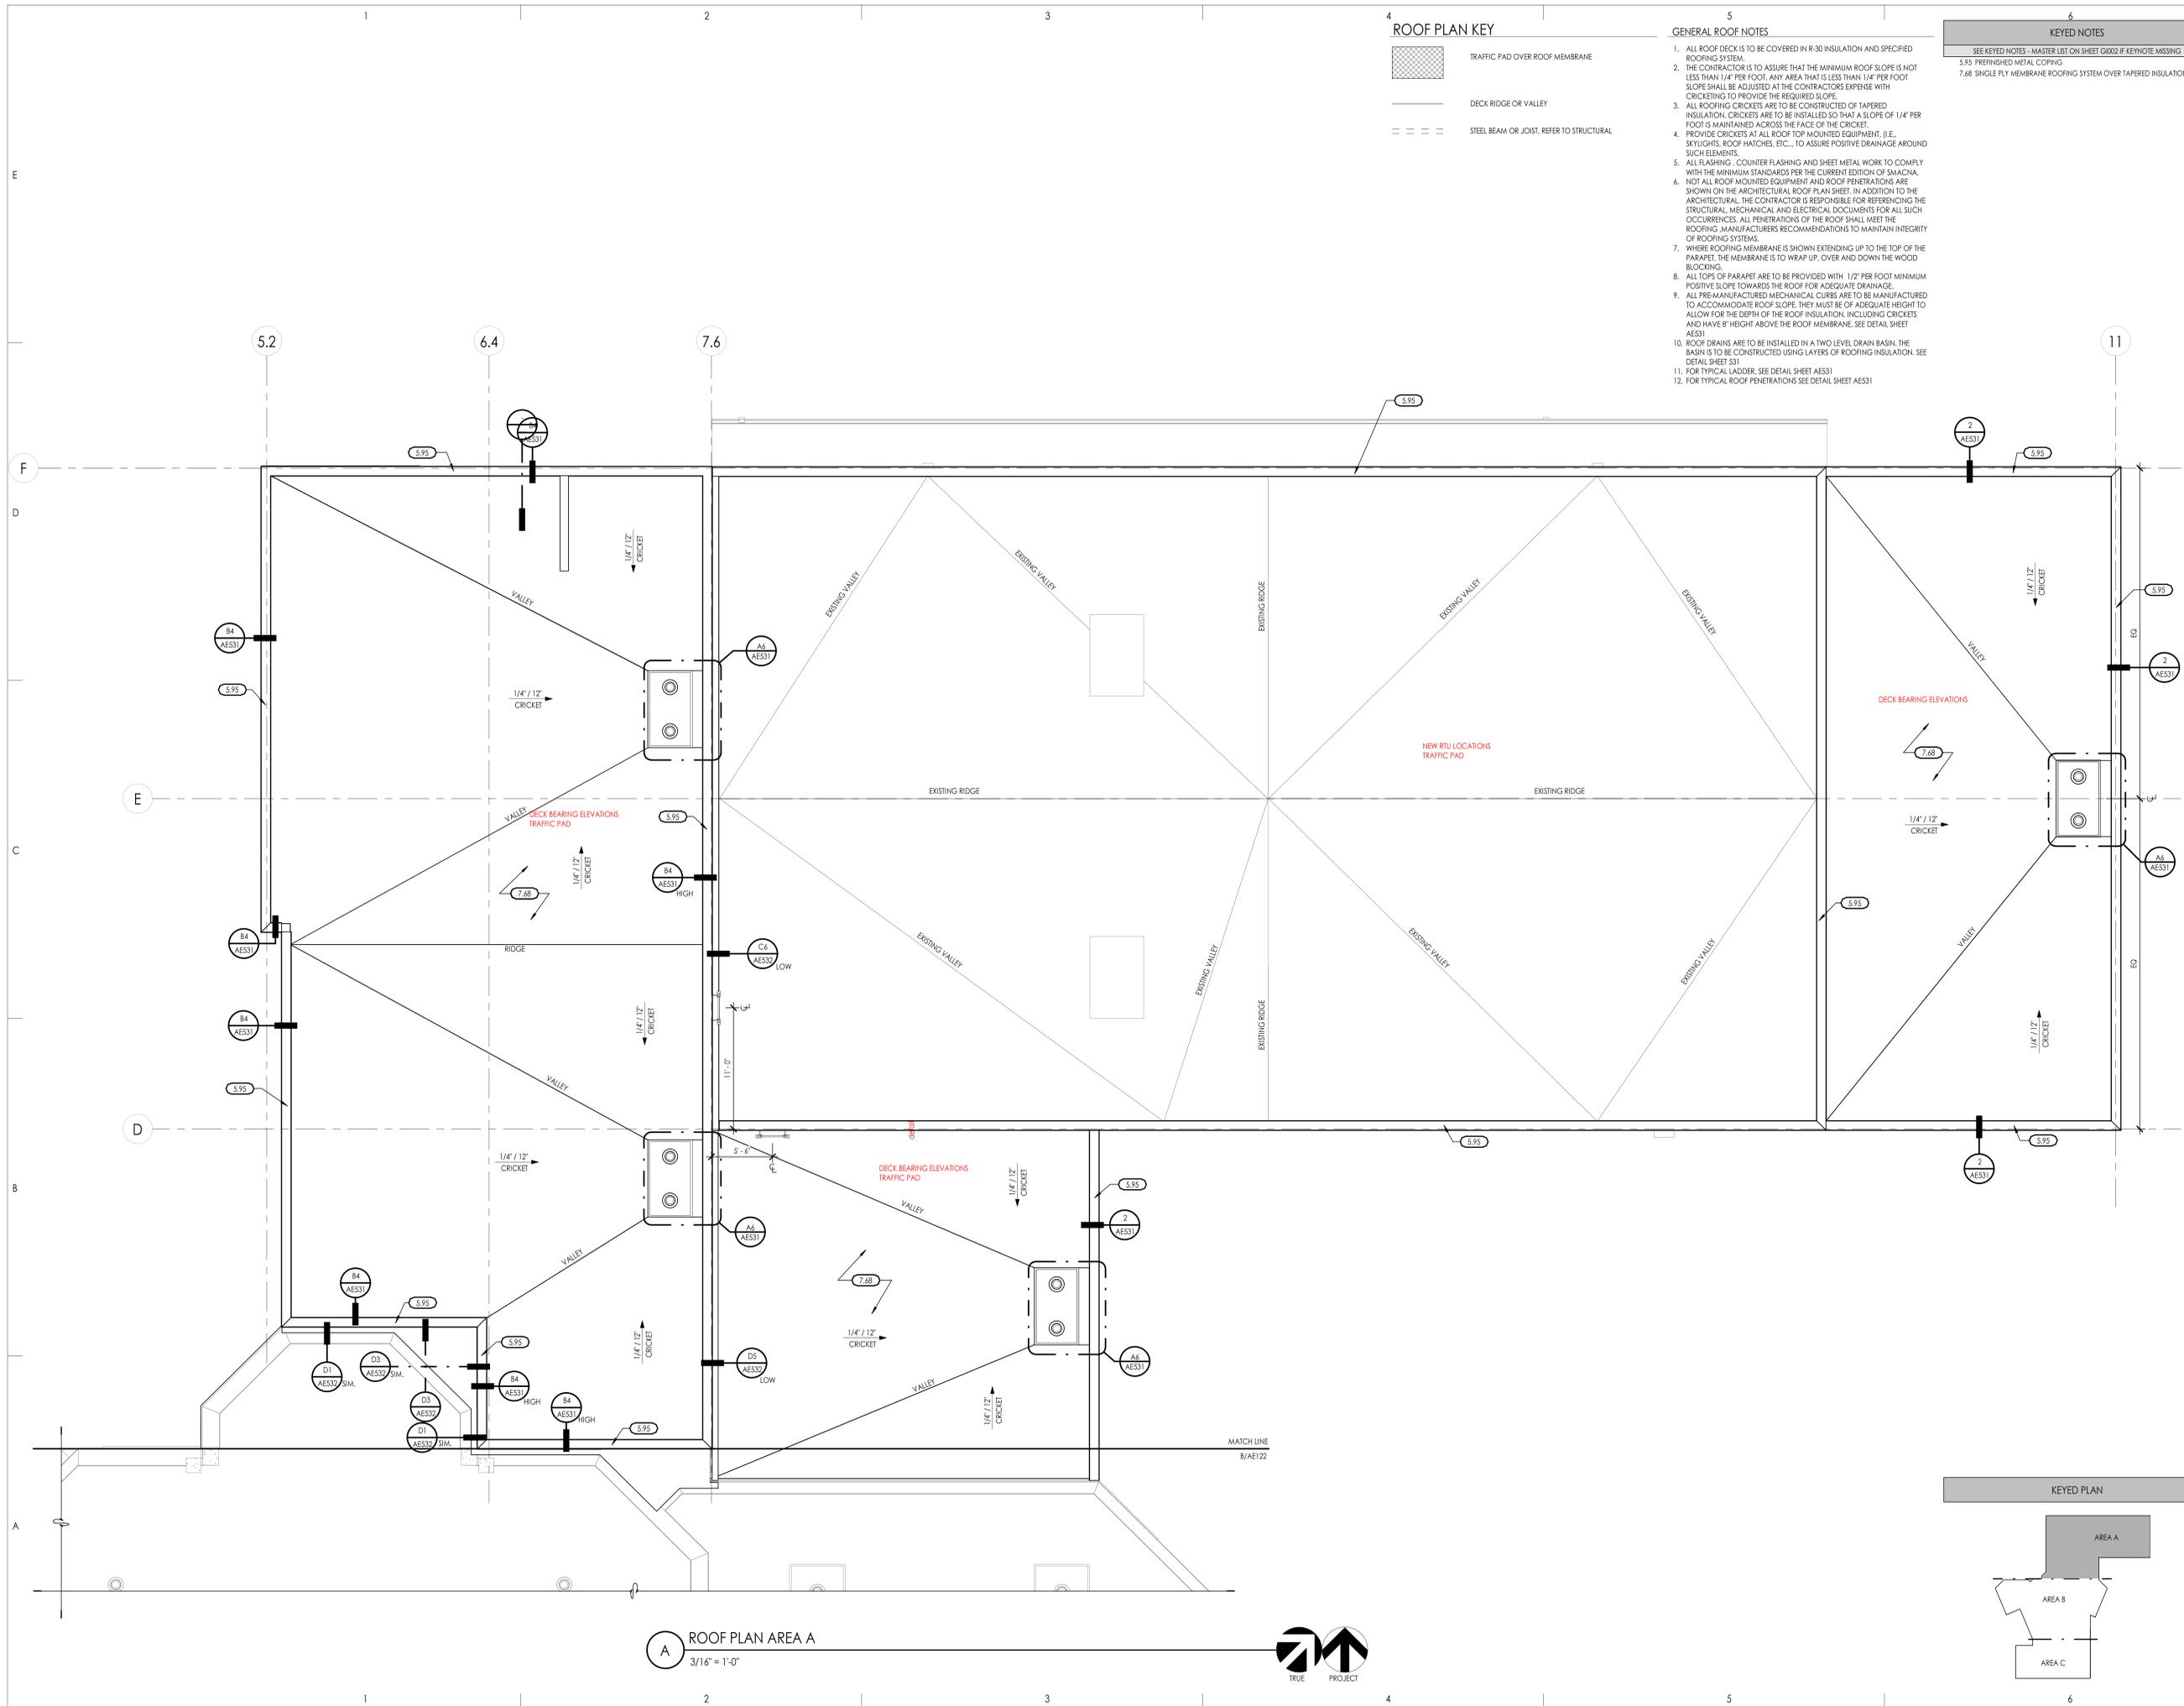
Revision

No.	Date	Description

SAA Project No. 2021-10
 Drawing Title

CLERESTORY PLAN AREA C

Sheet Number
AE110



ROOF PLAN KEY

- TRAFFIC PAD OVER ROOF MEMBRANE
- DECK RIDGE OR VALLEY
- STEEL BEAM OR JOIST. REFER TO STRUCTURAL



GENERAL ROOF NOTES

1. ALL ROOF DECK IS TO BE COVERED IN R-30 INSULATION AND SPECIFIED ROOFING SYSTEM.
2. THE CONTRACTOR IS TO ASSURE THAT THE MINIMUM ROOF SLOPE IS NOT LESS THAN 1/4" PER FOOT. ANY AREA THAT IS LESS THAN 1/4" PER FOOT SLOPE SHALL BE ADJUSTED AT THE CONTRACTORS EXPENSE WITH CRICKETS TO PROVIDE THE REQUIRED SLOPE.
3. ALL ROOFING CRICKETS ARE TO BE CONSTRUCTED OF TAPERED INSULATION. CRICKETS ARE TO BE INSTALLED SO THAT A SLOPE OF 1/4" PER FOOT IS MAINTAINED ACROSS THE FACE OF THE CRICKET.
4. PROVIDE CRICKETS AT ALL ROOF TOP MOUNTED EQUIPMENT, (I.E. SKYLIGHTS, ROOF HATCHES, ETC.), TO ASSURE POSITIVE DRAINAGE AROUND SUCH ELEMENTS.
5. ALL FLASHINGS, COUNTER FLASHING AND SHEET METAL WORK TO COMPLY WITH THE MINIMUM STANDARDS PER THE CURRENT EDITION OF SMACNA.
6. NOT ALL ROOF MOUNTED EQUIPMENT AND ROOF PENETRATIONS ARE SHOWN ON THE ARCHITECTURAL ROOF PLAN SHEET. IN ADDITION TO THE ARCHITECTURAL, THE CONTRACTOR IS RESPONSIBLE FOR REFERENCING THE STRUCTURAL, MECHANICAL AND ELECTRICAL DOCUMENTS FOR ALL SUCH OCCURRENCES. ALL PENETRATIONS OF THE ROOF SHALL MEET THE ROOFING MANUFACTURERS RECOMMENDATIONS TO MAINTAIN INTEGRITY OF ROOFING SYSTEMS.
7. WHERE ROOFING MEMBRANE IS SHOWN EXTENDING UP TO THE TOP OF THE PARAPET, THE MEMBRANE IS TO WRAP UP, OVER AND DOWN THE WOOD BLOCKING.
8. ALL TOPS OF PARAPET ARE TO BE PROVIDED WITH 1/2" PER FOOT MINIMUM POSITIVE SLOPE TOWARDS THE ROOF FOR ADEQUATE DRAINAGE.
9. ALL PRE-MANUFACTURED MECHANICAL CURBS ARE TO BE MANUFACTURED TO ACCOMMODATE ROOF SLOPE. THEY MUST BE OF ADEQUATE HEIGHT TO ALLOW FOR THE DEPTH OF THE ROOF INSULATION, INCLUDING CRICKETS AND HAVE 8" HEIGHT ABOVE THE ROOF MEMBRANE. SEE DETAIL SHEET AE331
10. ROOF DRAINS ARE TO BE INSTALLED IN A TWO LEVEL DRAIN BASIN. THE BASIN IS TO BE CONSTRUCTED USING LAYERS OF ROOFING INSULATION. SEE DETAIL SHEET S31
11. FOR TYPICAL LADDER, SEE DETAIL SHEET AE331
12. FOR TYPICAL ROOF PENETRATIONS SEE DETAIL SHEET AE331

KEYED NOTES

- 5.95 PREFINISHED METAL COPING
- 7.68 SINGLE PLY MEMBRANE ROOFING SYSTEM OVER TAPERED INSULATION

A ROOF PLAN AREA A
3/16" = 1'-0"

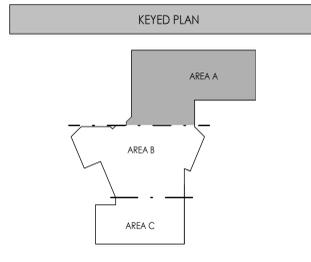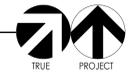

General Contractor

STACEY CONSTRUCTION
Stacey Construction
Construction Manager
General Contractor
3768 Pacific Ave.
Ogden, UT 84405
801.621.6210
www.staceycg.com

Consultant

OGDEN-HINCKLEY AIRPORT
TERMINAL EXPANSION
3909 AIRPORT ROAD
OGDEN, UT 84405

Project Name

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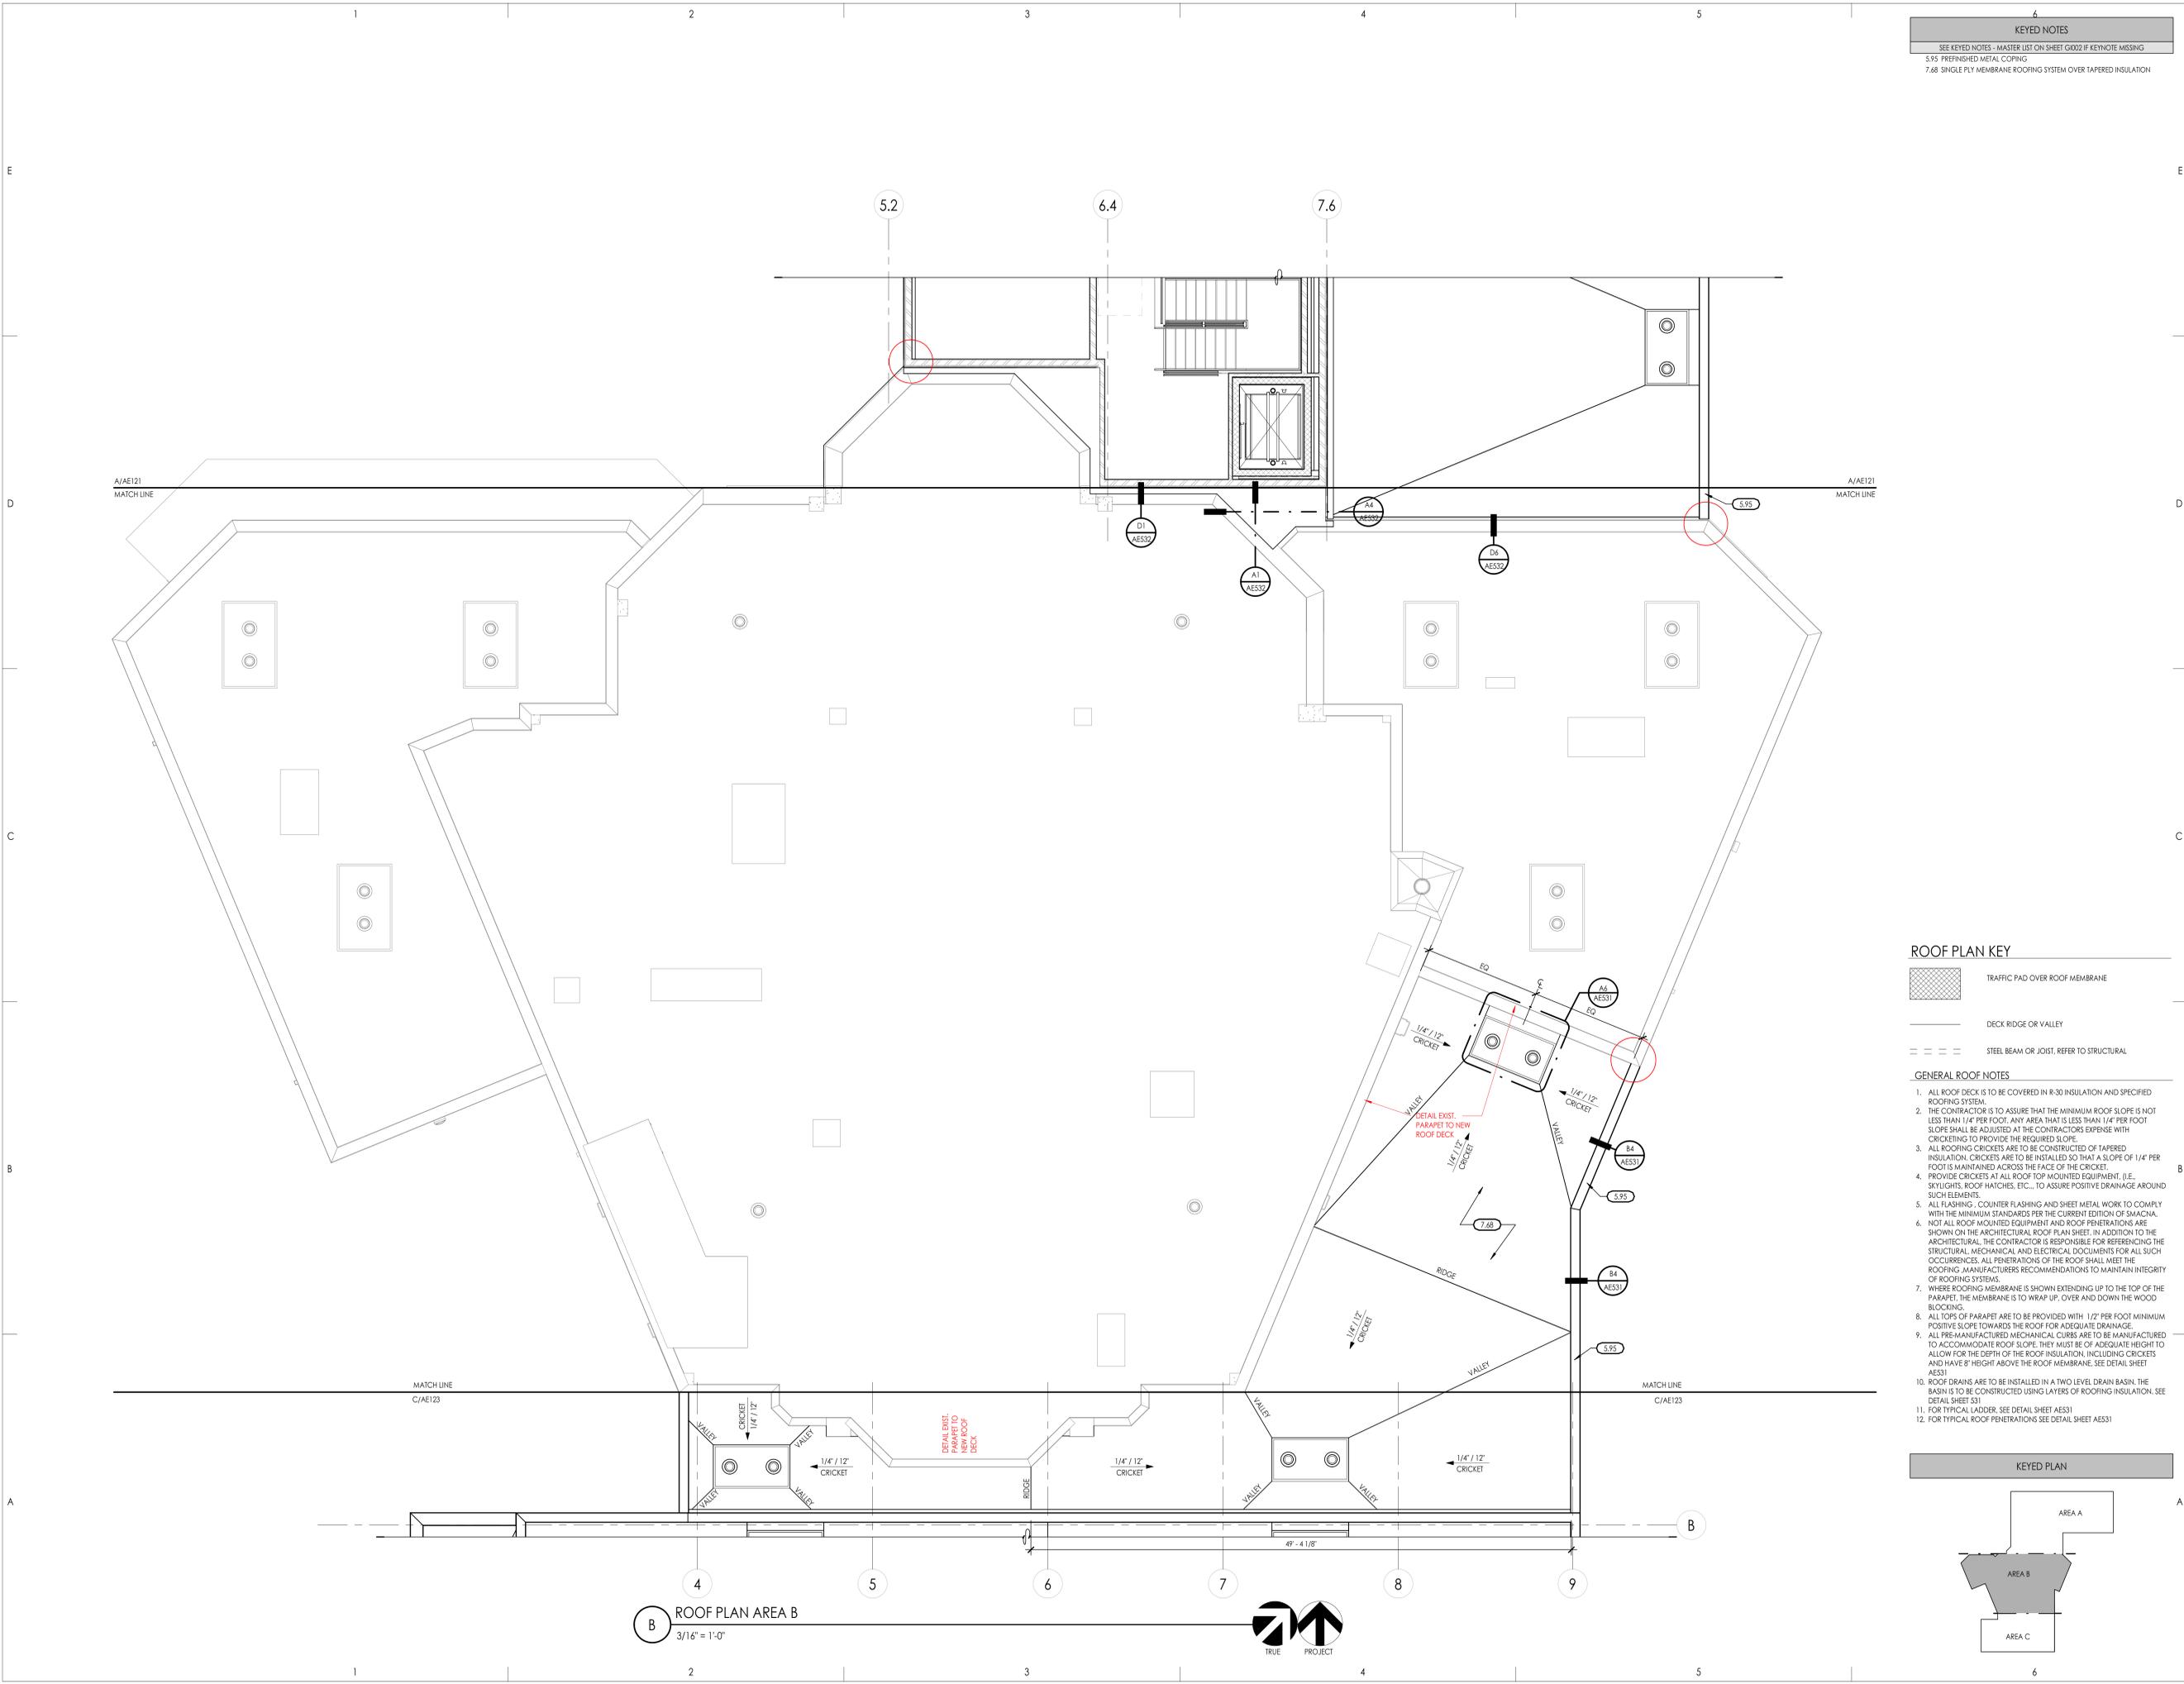
Revision

No.	Date	Description

SAA Project No. 2021-10
Drawing Title

ROOF PLAN AREA A


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AE121






KEYED NOTES	
5.95	PREFINISHED METAL COPING
7.68	SINGLE PLY MEMBRANE ROOFING SYSTEM OVER TAPERED INSULATION

ROOF PLAN KEY	
	TRAFFIC PAD OVER ROOF MEMBRANE
	DECK RIDGE OR VALLEY
	STEEL BEAM OR JOIST. REFER TO STRUCTURAL

- GENERAL ROOF NOTES**
- ALL ROOF DECK IS TO BE COVERED IN R-30 INSULATION AND SPECIFIED ROOFING SYSTEM.
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 - ALL ROOFING CRICKETS ARE TO BE CONSTRUCTED OF TAPERED INSULATION. CRICKETS ARE TO BE INSTALLED SO THAT A SLOPE OF 1/4" PER FOOT IS MAINTAINED ACROSS THE FACE OF THE CRICKET.
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 - ROOF DRAINS ARE TO BE INSTALLED IN A TWO LEVEL DRAIN BASIN. THE BASIN IS TO BE CONSTRUCTED USING LAYERS OF ROOFING INSULATION. SEE DETAIL SHEET S31.
 - FOR TYPICAL LADDER. SEE DETAIL SHEET AE531.
 - FOR TYPICAL ROOF PENETRATIONS SEE DETAIL SHEET AE531.

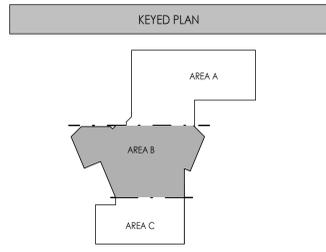

B ROOF PLAN AREA B
3/16" = 1'-0"

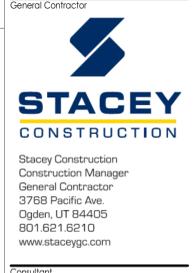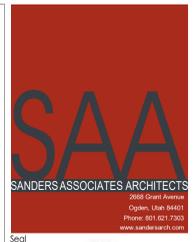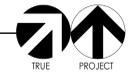

General Contractor
Stacey Construction
Construction Manager
General Contractor
3768 Pacific Ave.
Ogden, UT 84405
801.621.6210
www.staceycg.com

Consultant

OGDEN-HINCKLEY AIRPORT
TERMINAL EXPANSION
3909 AIRPORT ROAD
OGDEN, UT 84405

Project Name

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Revision


No.	Date	Description

SAA Project No. 2021-10
Drawing Title

ROOF PLAN AREA B

Sheet Number


AE122

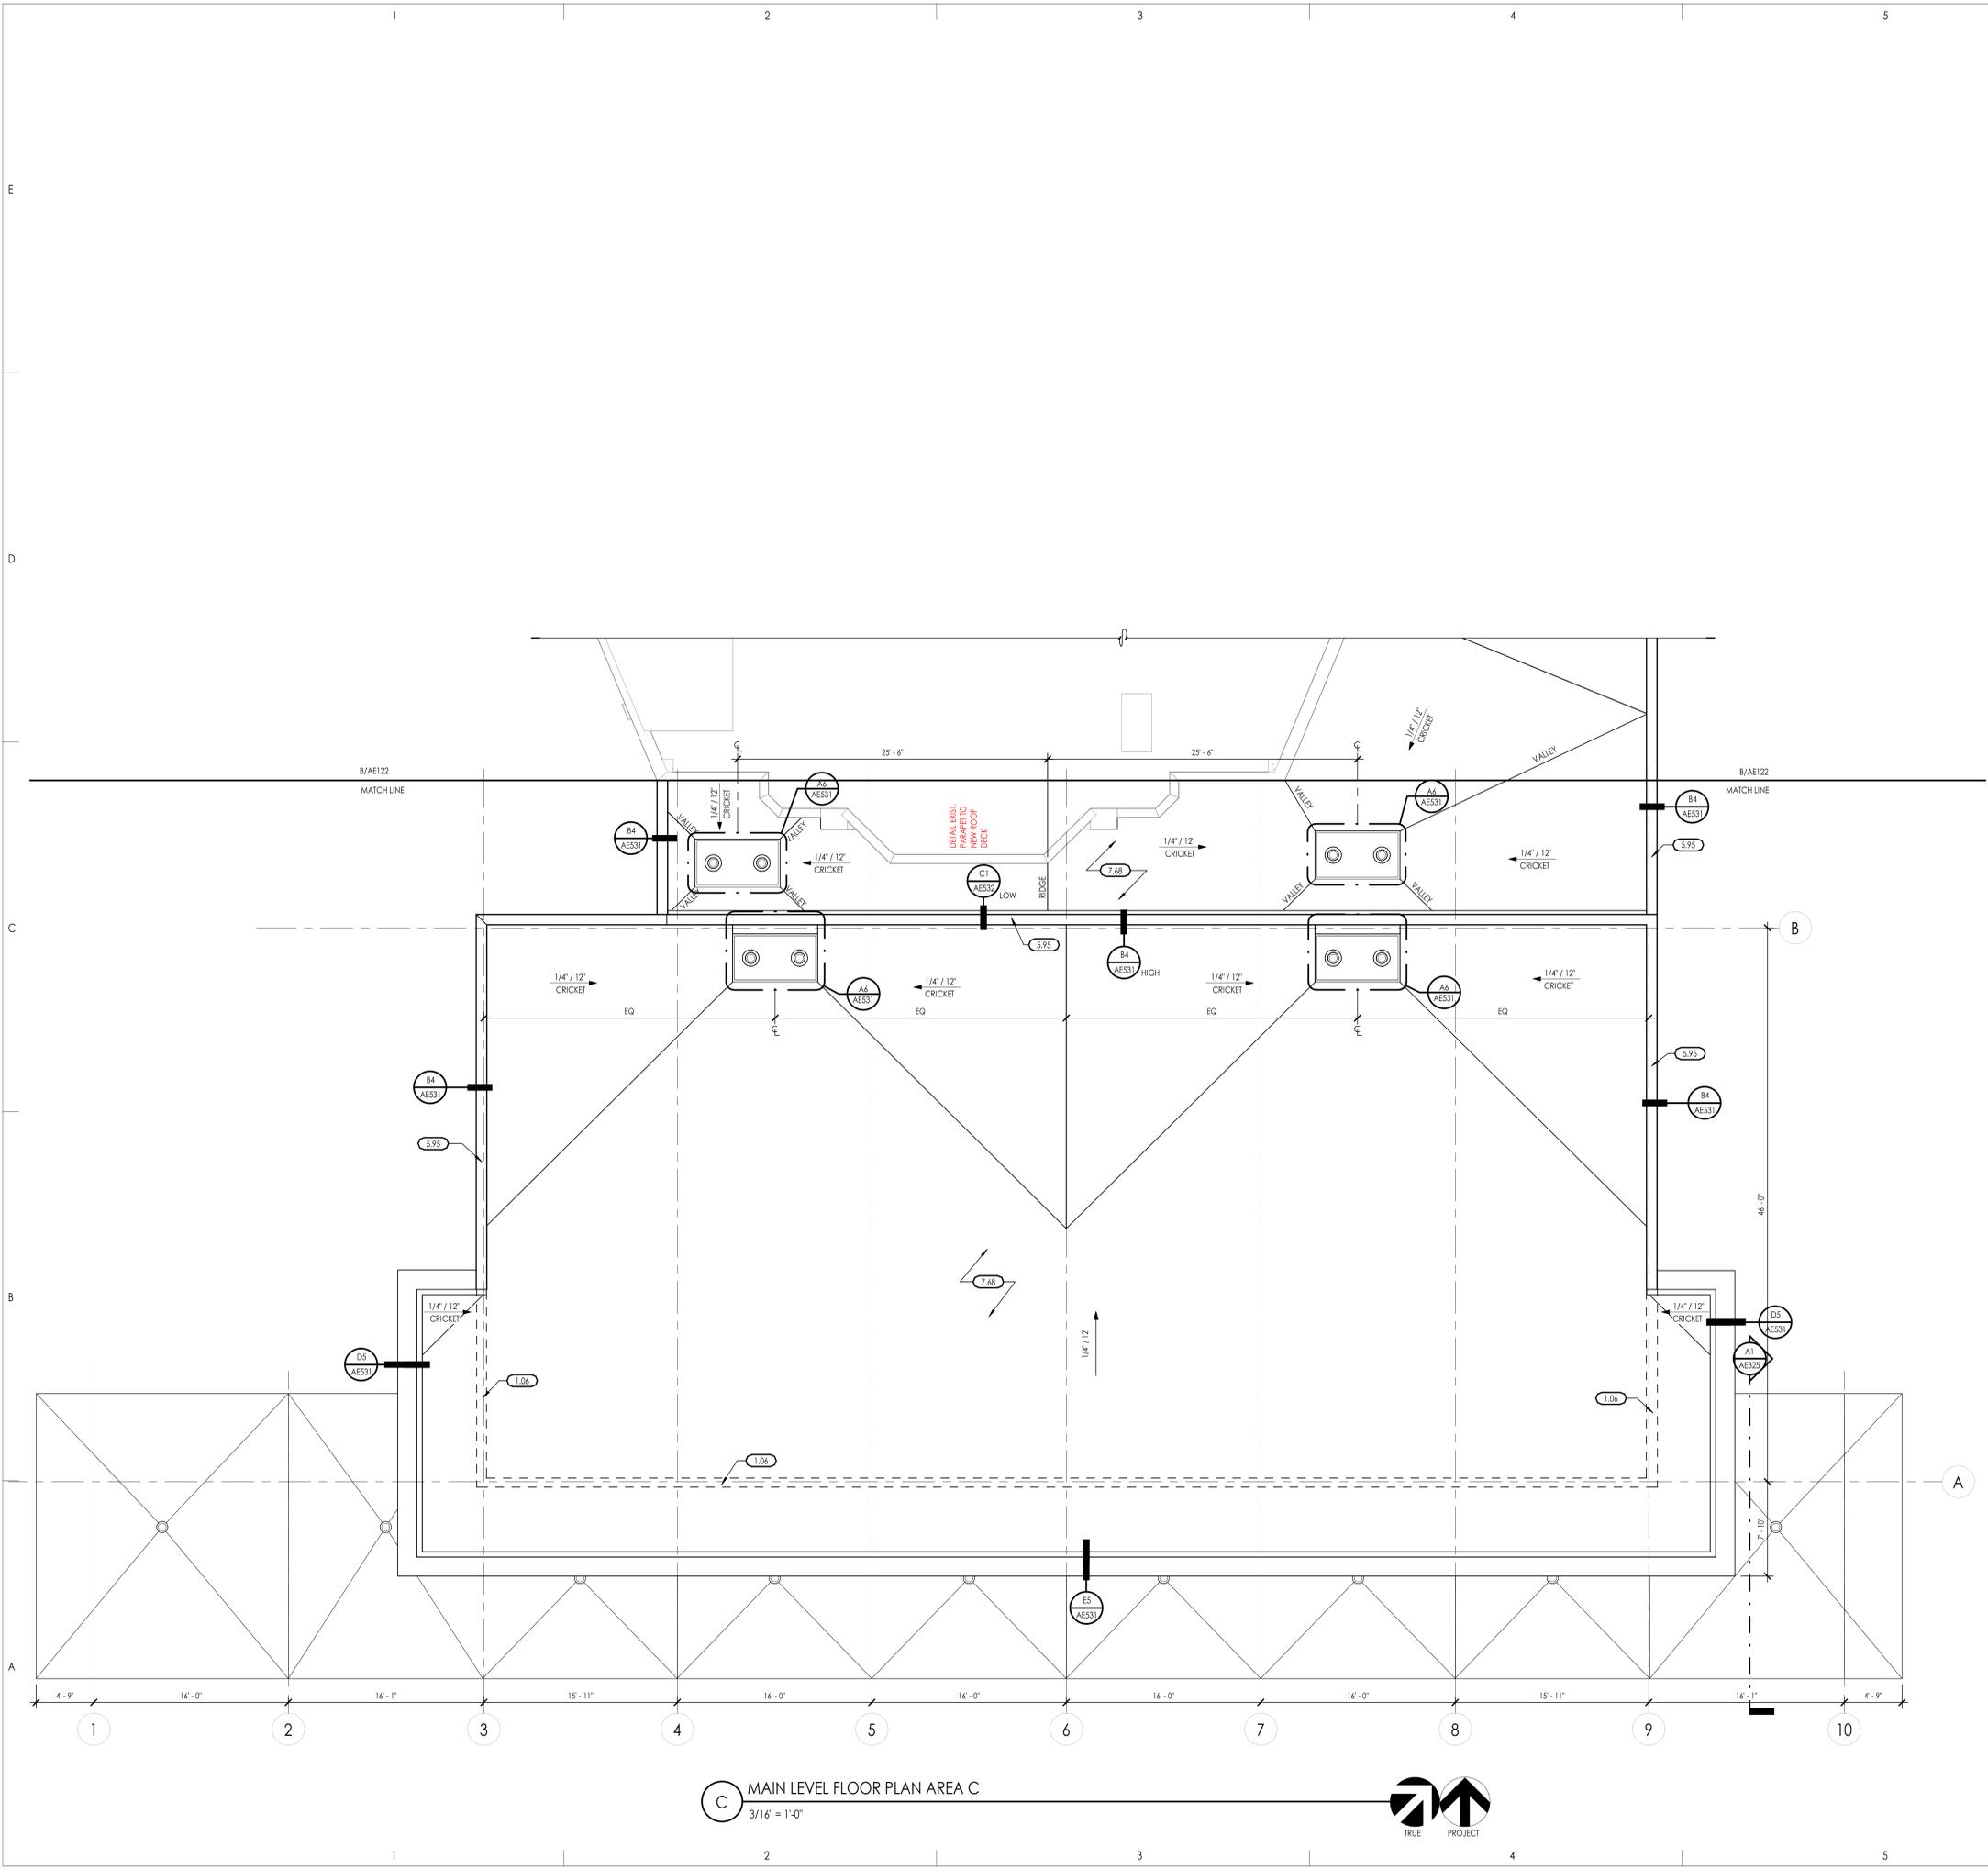


KEYED NOTES	
SEE KEYED NOTES - MASTER LIST ON SHEET G002 IF KEYNOTE MISSING	
1.06 LINE OF WALL BELOW	
5.95 PREFINISHED METAL COPING	
7.68 SINGLE PLY MEMBRANE ROOFING SYSTEM OVER TAPERED INSULATION	

ROOF PLAN KEY	
	TRAFFIC PAD OVER ROOF MEMBRANE
	DECK RIDGE OR VALLEY
	STEEL BEAM OR JOIST, REFER TO STRUCTURAL

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 - FOR TYPICAL LADDER. SEE DETAIL SHEET AES31.
 - FOR TYPICAL ROOF PENETRATIONS SEE DETAIL SHEET AES31.

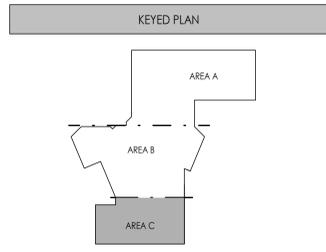

C MAIN LEVEL FLOOR PLAN AREA C
3/16" = 1'-0"

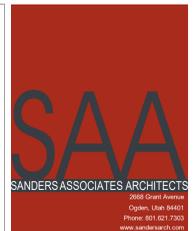

STACEY CONSTRUCTION
 Stacey Construction
 Construction Manager
 General Contractor
 3788 Pacific Ave.
 Ogden, UT 84405
 801.621.6210
 www.staceygc.com
 Consultant

OGDEN-HINCKLEY AIRPORT
TERMINAL EXPANSION
 3909 AIRPORT ROAD
 OGDEN, UT 84405


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No.	Date	Description
1	11-15-2022	BID SET
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 Drawing Title


ROOF PLAN AREA C

Sheet Number

AE123

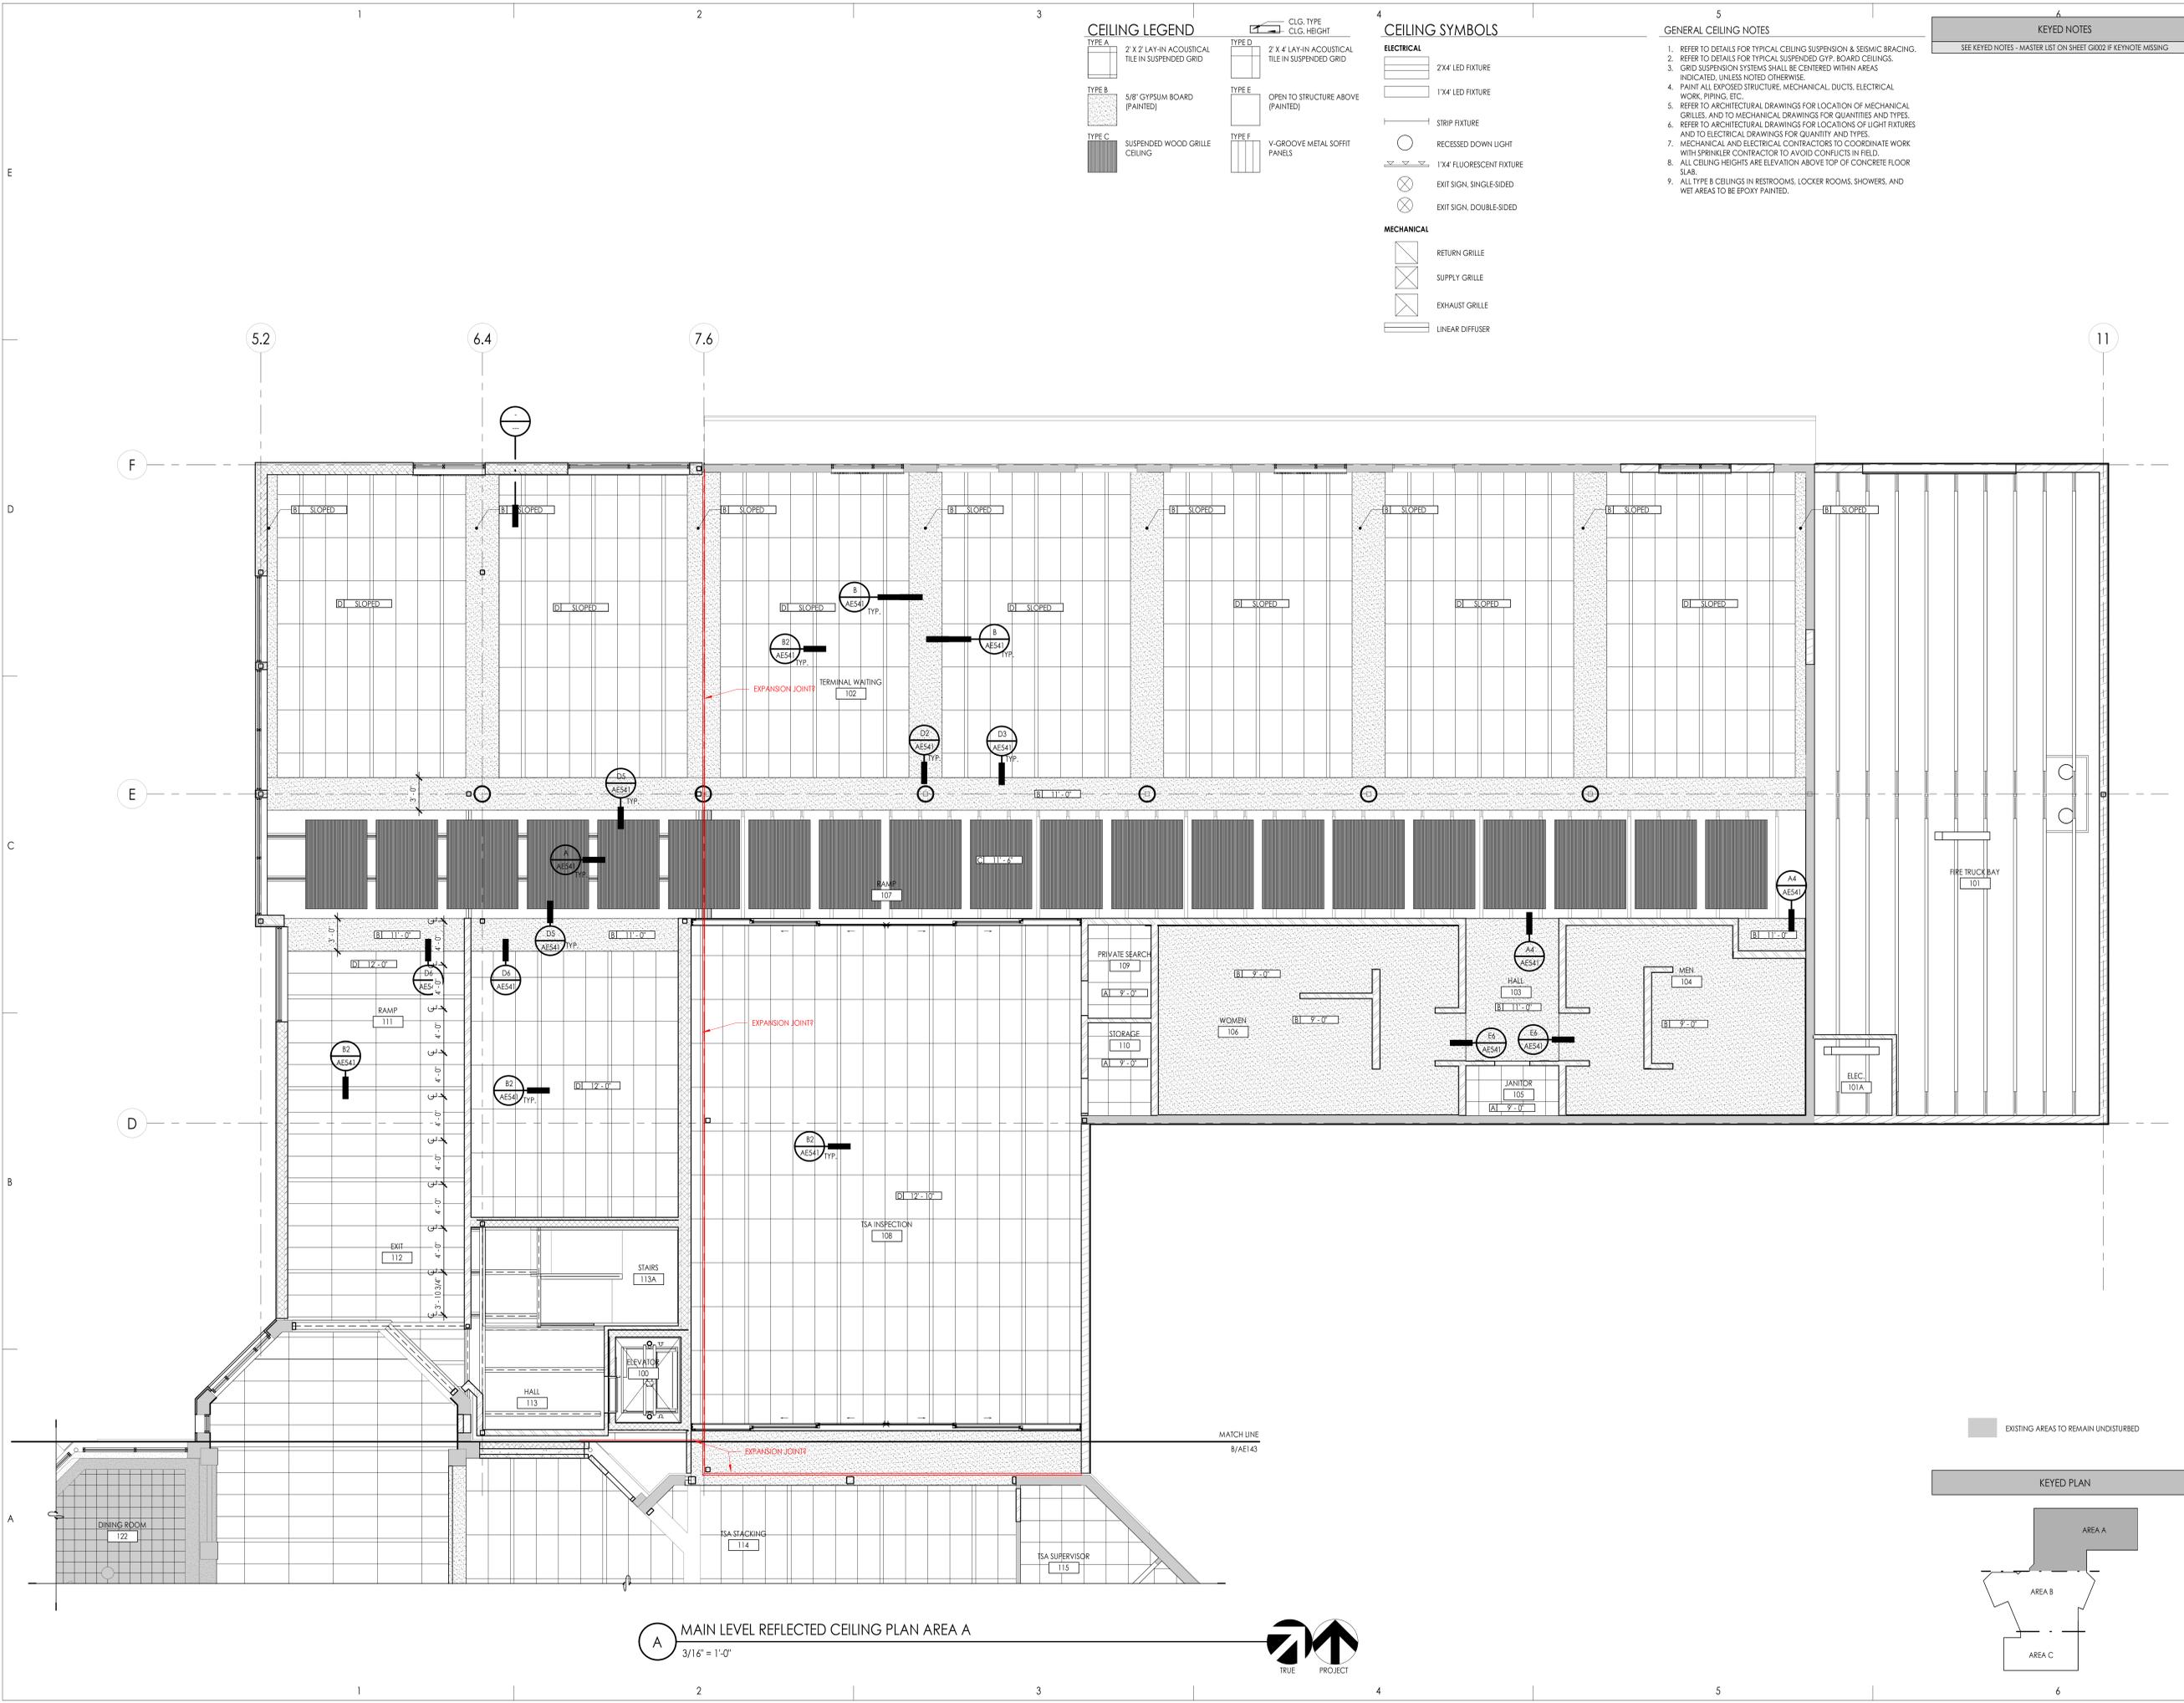

A MAIN LEVEL REFLECTED CEILING PLAN AREA A
3/16" = 1'-0"

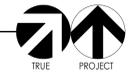

CEILING LEGEND

TYPE A 2' X 2' LAY-IN ACOUSTICAL TILE IN SUSPENDED GRID	TYPE D 2' X 4' LAY-IN ACOUSTICAL TILE IN SUSPENDED GRID
TYPE B 5/8" GYPSUM BOARD (PAINTED)	TYPE E OPEN TO STRUCTURE ABOVE (PAINTED)
TYPE C SUSPENDED WOOD GRILLE CEILING	TYPE F V-GROOVE METAL SOFFIT PANELS


CEILING SYMBOLS

	2'x4' LED FIXTURE
	1'x4' LED FIXTURE
	STRIP FIXTURE
	RECESSED DOWN LIGHT
	1'x4' FLUORESCENT FIXTURE
	EXIT SIGN, SINGLE-SIDED
	EXIT SIGN, DOUBLE-SIDED
MECHANICAL	
	RETURN GRILLE
	SUPPLY GRILLE
	EXHAUST GRILLE
	LINEAR DIFFUSER

- GENERAL CEILING NOTES**
- REFER TO DETAILS FOR TYPICAL CEILING SUSPENSION & SEISMIC BRACING.
 - REFER TO DETAILS FOR TYPICAL SUSPENDED GYP. BOARD CEILINGS.
 - GRID SUSPENSION SYSTEMS SHALL BE CENTERED WITHIN AREAS INDICATED, UNLESS NOTED OTHERWISE.
 - PAINT ALL EXPOSED STRUCTURE, MECHANICAL, DUCTS, ELECTRICAL WORK, PIPING, ETC.
 - REFER TO ARCHITECTURAL DRAWINGS FOR LOCATION OF MECHANICAL GRILLES, AND TO MECHANICAL DRAWINGS FOR QUANTITIES AND TYPES.
 - REFER TO ARCHITECTURAL DRAWINGS FOR LOCATIONS OF LIGHT FIXTURES AND TO ELECTRICAL DRAWINGS FOR QUANTITY AND TYPES.
 - MECHANICAL AND ELECTRICAL CONTRACTORS TO COORDINATE WORK WITH SPRINKLER CONTRACTOR TO AVOID CONFLICTS IN FIELD.
 - ALL CEILING HEIGHTS ARE ELEVATION ABOVE TOP OF CONCRETE FLOOR SLAB.
 - ALL TYPE B CEILINGS IN RESTROOMS, LOCKER ROOMS, SHOWERS, AND WET AREAS TO BE EPOXY PAINTED.

KEYED NOTES

SEE KEYED NOTES - MASTER LIST ON SHEET G1002 IF KEYNOTE MISSING

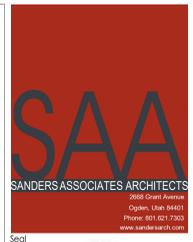

General Contractor

Stacey Construction
Construction Manager
General Contractor
3768 Pacific Ave.
Ogden, UT 84405
801.621.6210
www.staceygc.com

Consultant

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**OGDEN-HINCKLEY AIRPORT
TERMINAL EXPANSION**
3909 AIRPORT ROAD
OGDEN, UT 84405

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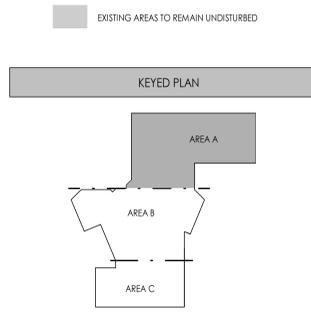
No.	Date	Description
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SAA Project No. 2021-10
Drawing Title

MAIN LEVEL REFLECTED CEILING PLAN AREA A


Sheet Number

AE142





B MAIN LEVEL REFLECTED CEILING PLAN AREA B
3/16" = 1'-0"

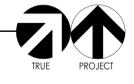

KEYED NOTES

SEE KEYED NOTES - MASTER LIST ON SHEET G102 IF KEYNOTE MISSING

CEILING LEGEND

CLG. TYPE
CLG. HEIGHT

CEILING SYMBOLS

ELECTRICAL

- 2' x 4' LED FIXTURE
- 1' x 4' LED FIXTURE
- STRIP FIXTURE
- RECESSED DOWN LIGHT
- 1' x 4' FLUORESCENT FIXTURE
- EXIT SIGN, SINGLE-SIDED
- EXIT SIGN, DOUBLE-SIDED



MECHANICAL

- RETURN GRILLE
- SUPPLY GRILLE
- EXHAUST GRILLE
- LINEAR DIFFUSER

EXISTING AREAS TO REMAIN UNDISTURBED

- GENERAL CEILING NOTES**
- REFER TO DETAILS FOR TYPICAL CEILING SUSPENSION & SEISMIC BRACING.
 - REFER TO DETAILS FOR TYPICAL SUSPENDED GYP. BOARD CEILINGS.
 - GRID SUSPENSION SYSTEMS SHALL BE CENTERED WITHIN AREAS INDICATED, UNLESS NOTED OTHERWISE.
 - PAINT ALL EXPOSED STRUCTURE, MECHANICAL DUCTS, ELECTRICAL WORK, PIPING, ETC.
 - REFER TO ARCHITECTURAL DRAWINGS FOR LOCATION OF MECHANICAL GRILLES, AND TO MECHANICAL DRAWINGS FOR QUANTITIES AND TYPES.
 - REFER TO ARCHITECTURAL DRAWINGS FOR LOCATIONS OF LIGHT FIXTURES AND TO ELECTRICAL DRAWINGS FOR QUANTITIES AND TYPES.
 - MECHANICAL AND ELECTRICAL CONTRACTORS TO COORDINATE WORK WITH SPRINKLER CONTRACTOR TO AVOID CONFLICTS IN FIELD.
 - ALL CEILING HEIGHTS ARE ELEVATION ABOVE TOP OF CONCRETE FLOOR SLAB.
 - ALL TYPE B CEILINGS IN RESTROOMS, LOCKER ROOMS, SHOWERS, AND WET AREAS TO BE EPOXY PAINTED.

KEYED PLAN

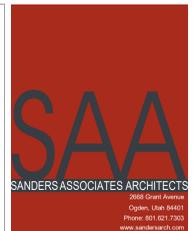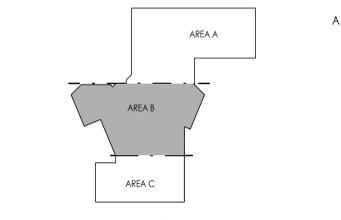

STACEY CONSTRUCTION
Stacey Construction
Construction Manager
General Contractor
3768 Pacific Ave.
Ogden, UT 84405
801.621.6210
www.staceycg.com

OGDEN-HINCKLEY AIRPORT
TERMINAL EXPANSION
3909 AIRPORT ROAD
OGDEN, UT 84405

Project Name

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SAA Project No. 2021-10
Drawing Title

MAIN LEVEL REFLECTED CEILING PLAN AREA B


Sheet Number
AE143

GENERAL CEILING NOTES

- REFER TO DETAILS FOR TYPICAL CEILING SUSPENSION & SEISMIC BRACING.
- REFER TO DETAILS FOR TYPICAL SUSPENDED GYP. BOARD CEILINGS.
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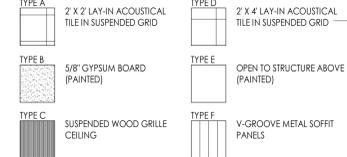
KEYED NOTES

SEE KEYED NOTES - MASTER LIST ON SHEET G002 IF KEYNOTE MISSING



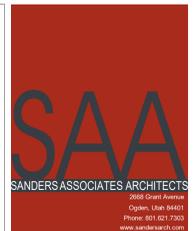


General Contractor
STACEY CONSTRUCTION
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 Construction Manager
 General Contractor
 3788 Pacific Ave.
 Ogden, UT 84405
 801.621.6210
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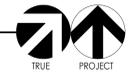
CEILING LEGEND



CEILING SYMBOLS

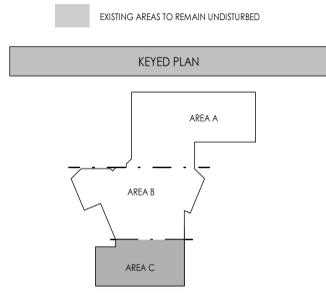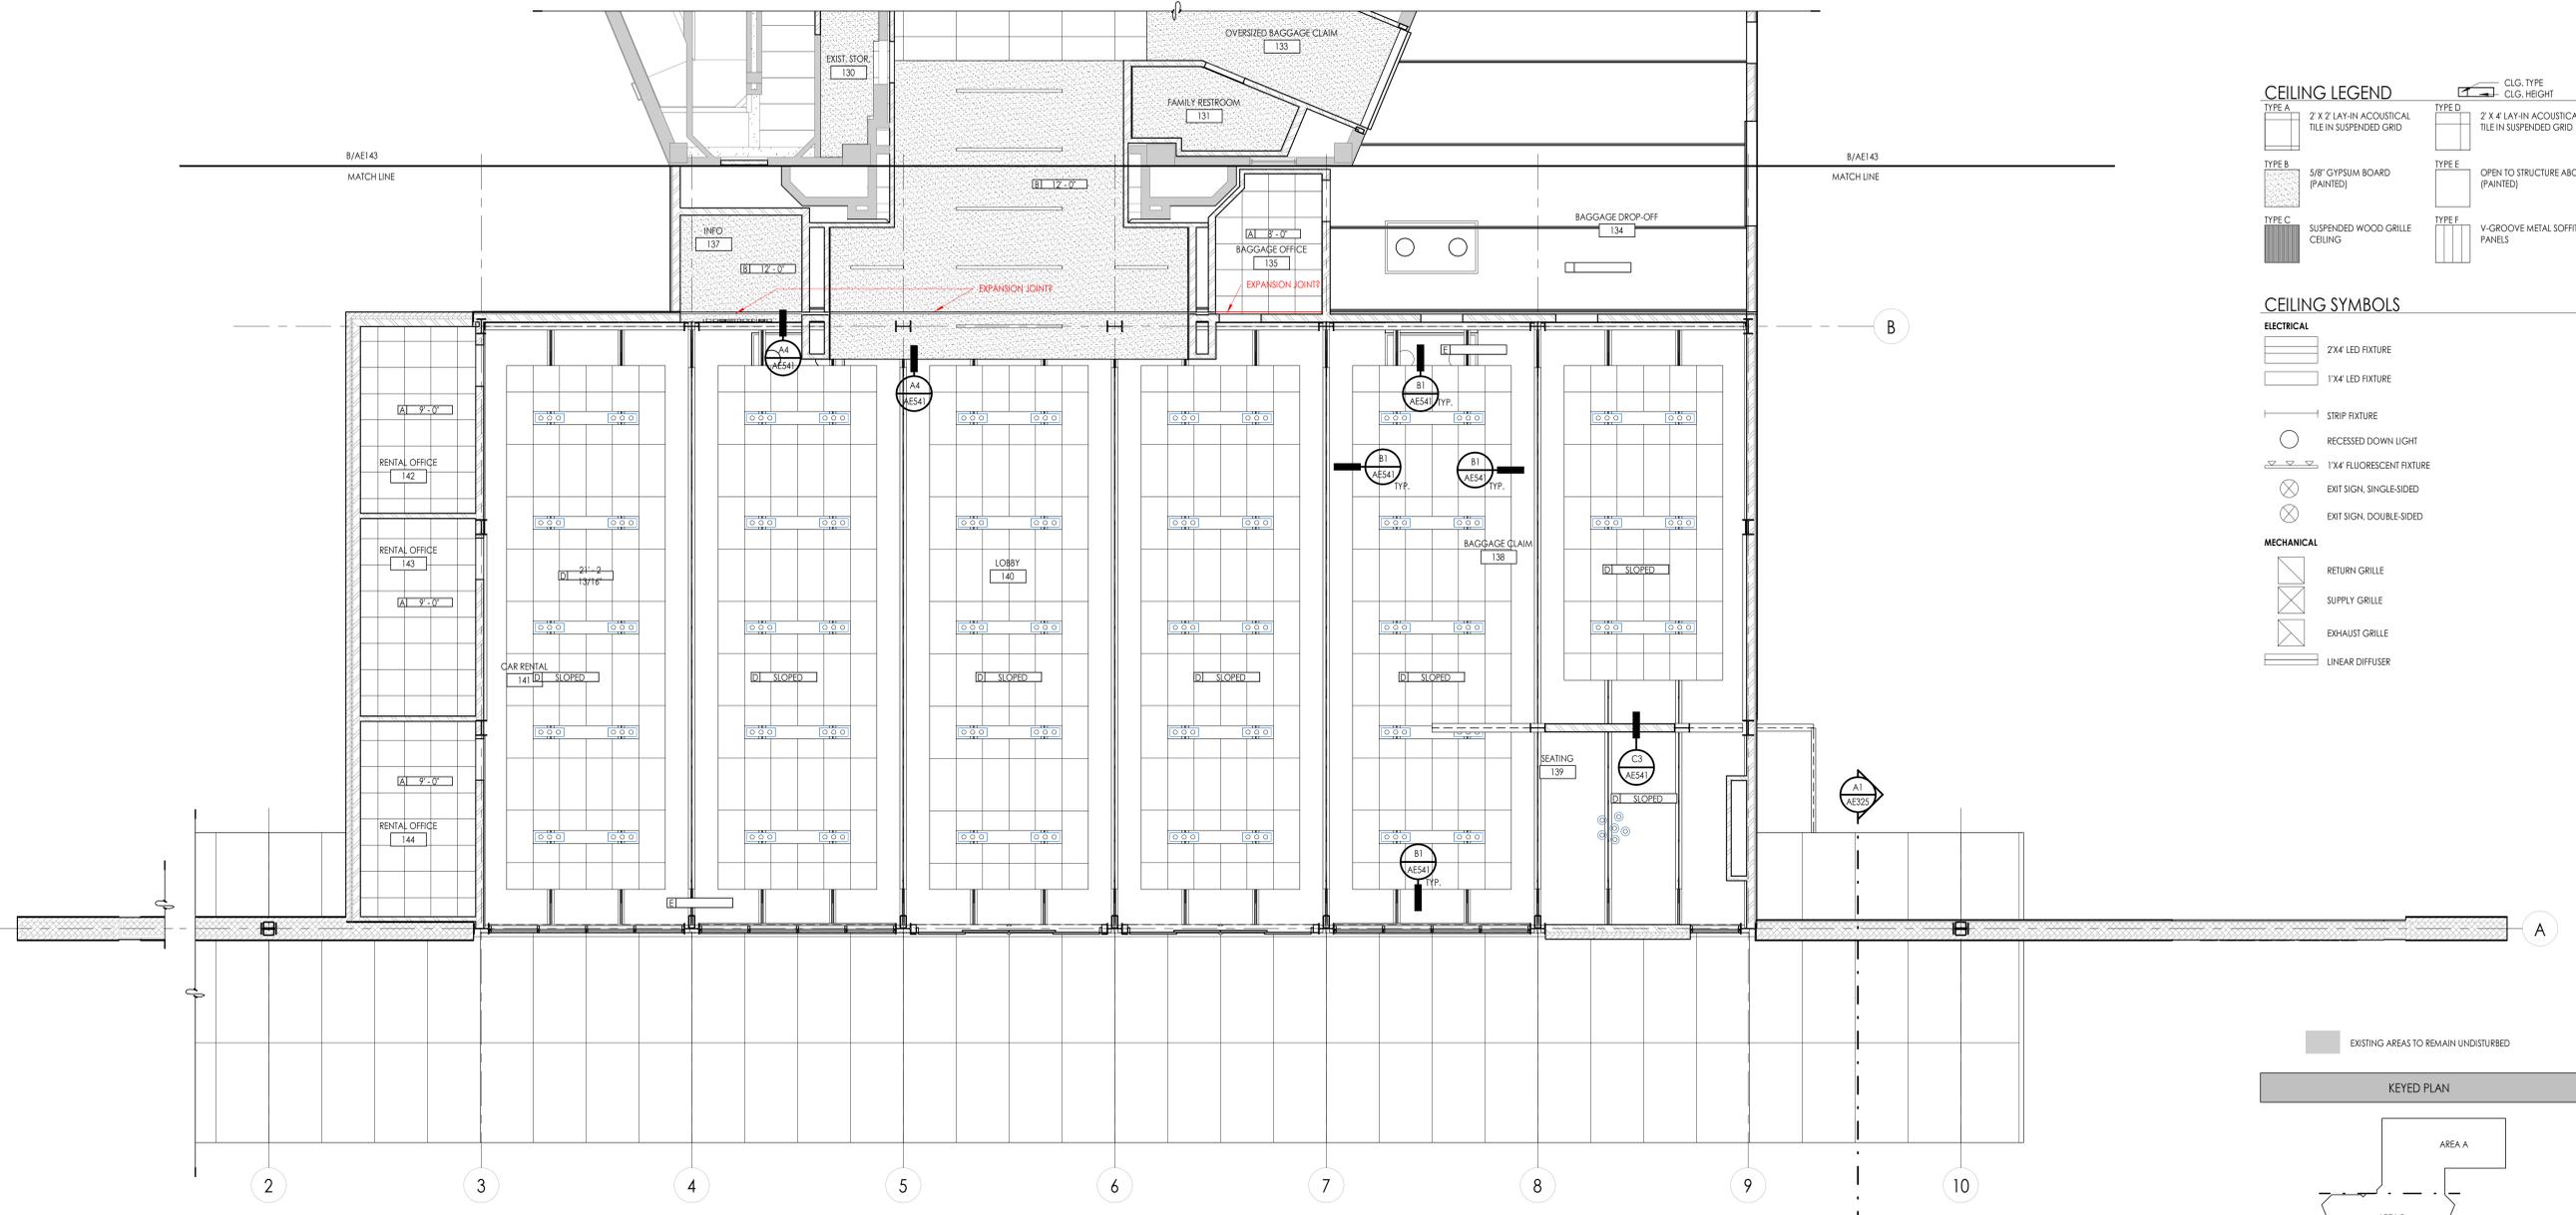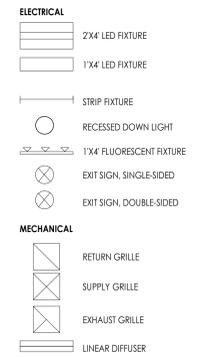

C MAIN LEVEL REFLECTED CEILING PLAN AREA B
 3/16" = 1'-0"



Project Name
OGDEN-HINCKLEY AIRPORT
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 3909 AIRPORT ROAD
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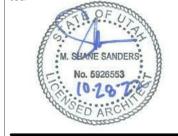
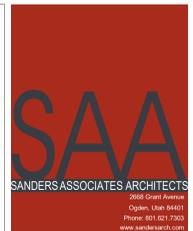
SAA Project No. 2021-10
 Drawing Title

MAIN LEVEL REFLECTED CEILING PLAN AREA C

Sheet Number

AE144

KEYED NOTES
 SEE KEYED NOTES - MASTER LIST ON SHEET G1002 IF KEYNOTE MISSING
 12.01 FURNISHINGS BY OTHERS



General Contractor

STACEY CONSTRUCTION
 Stacey Construction
 Construction Manager
 General Contractor
 3768 Pacific Ave.
 Ogden, UT 84405
 801.821.6210
 www.staceycg.com

Consultant

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Revisions


No.	Date	Description

SAA Project No. 2021-10
 Drawing Title

BASEMENT FINISH FLOOR PLAN

Sheet Number


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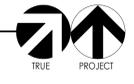
- FINISH LEGEND**
- CP1-1
 - CP1-2
 - CP1-3
 - T-1
 - T-2
 - T-3
 - T-4
 - RUBBER STAIR AND LANDING SYSTEM (RF-1 / RF-2)
 - RF-3
 - RF-4
 - RF-5
 - EF-1
 - EF-2
 - EF-3

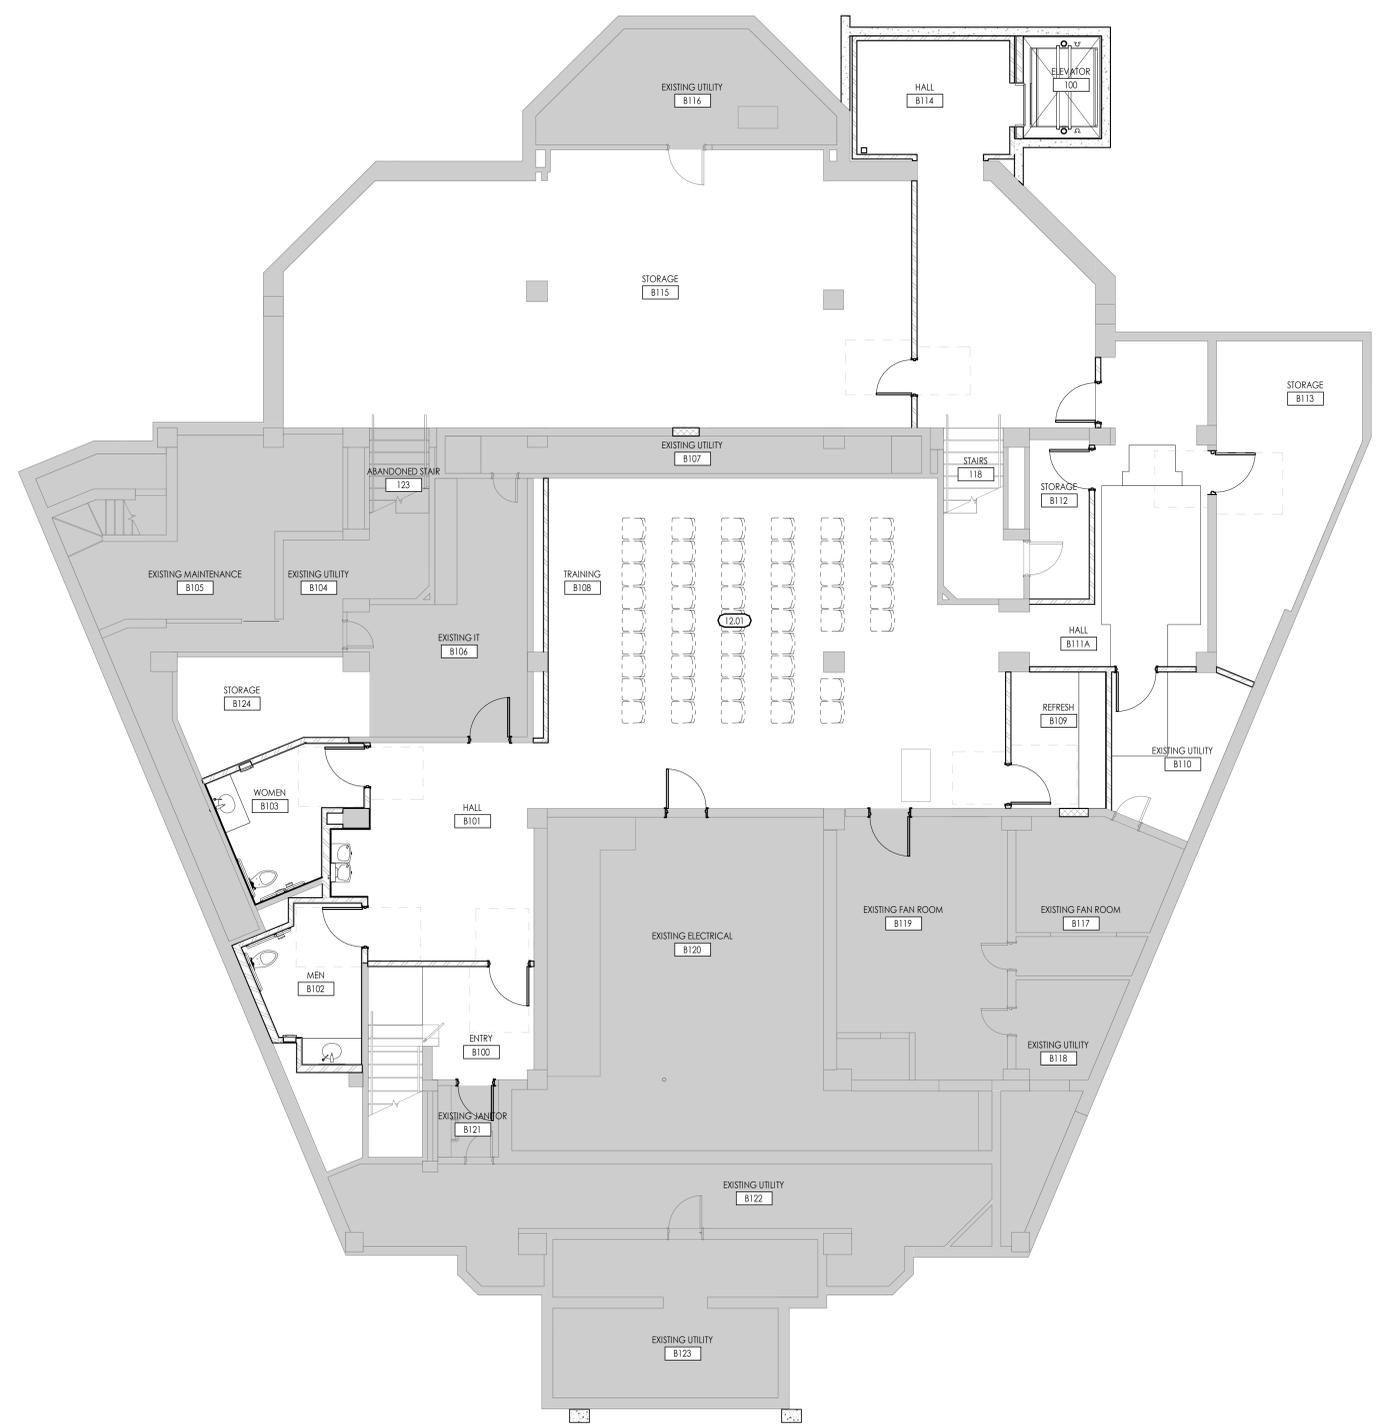- GENERAL FINISH NOTES**
- ALL FLOOR TRANSITIONS LOCATED AT CENTER OF DOOR
 - SEE ELEVATION SHEETS FOR ALL WALL TILE PATTERNS.
 - FIELD VERIFY ALL DIMENSIONS BEFORE FABRICATION OF MILLWORK.
 - COORDINATE ALL MILLWORK WITH APPLIANCES BEFORE FABRICATION.
 - ALL WINDOW SILLS TO BE SOLID SURFACE UNLESS OTHERWISE NOTED.
 - FLOOR TILE PATTERNS TO BE INSTALLED AS INDICATED ON FINISH PLAN.
 - TYPICAL TILE DIRECTION PATTERNS TO BE MAINTAINED AND CONSISTENT THROUGHOUT INDICATED SPACE.
 - FLOAT FLOOR AT CARPET EDGE TRANSITIONS USING RUBBER SUBFLOOR LEVELER: 1/8" / 12" MAX SLOPE (ROPPE #304 OR EQ.) TYPICAL.
 - ALL TYPE B CEILINGS IN RESTROOMS, LOCKER ROOMS, SHOWERS, AND WET AREAS TO BE EPOXY PAINTED.

KEYED PLAN



BASEMENT FINISH FLOOR PLAN
 3/16" = 1'-0"

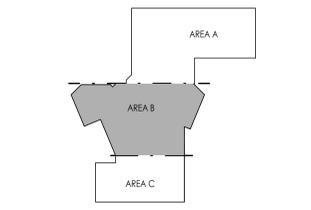

GENERAL FINISH NOTES

1. ALL FLOOR TRANSITIONS LOCATED AT CENTER OF DOOR
2. SEE ELEVATION SHEETS FOR ALL WALL TILE PATTERNS.
3. FIELD VERIFY ALL DIMENSIONS BEFORE FABRICATION OF MILLWORK.
4. COORDINATE ALL MILLWORK WITH APPLIANCES BEFORE FABRICATION.
5. ALL WINDOW SILLS TO BE SOLID SURFACE UNLESS OTHERWISE NOTED.
6. FLOOR TILE PATTERNS TO BE INSTALLED AS INDICATED ON FINISH PLAN.
7. TYPICAL TILE DIRECTION PATTERNS TO BE MAINTAINED AND CONSISTENT THROUGHOUT INDICATED SPACE.
8. FLOAT FLOOR AT CARPET EDGE TRANSITIONS USING RUBBER SUBFLOOR LEVELER, 1/8" / 12" MAX SLOPE, (ROPPE #304 OR EQ.) TYPICAL.
9. ALL TYPE B CEILING IN RESTROOMS, LOCKER ROOMS, SHOWERS, AND WET AREAS TO BE EPOXY PAINTED.

FINISH LEGEND

- CPT-1
- CPT-2
- CPT-3
- T-1
- T-2
- T-3
- T-4
- RUBBER STAIR AND LANDING SYSTEM (RF-1 / RF-2)
- RF-3
- RF-4
- RF-5
- EF-1
- EF-2
- EF-3

KEYED NOTES

SEE KEYED NOTES - MASTER LIST ON SHEET G002 IF KEYNOTE MISSING




General Contractor



Stacey Construction
Construction Manager
General Contractor
3788 Pacific Ave.
Ogden, UT 84405
801.621.6210
www.staceycg.com


Consultant

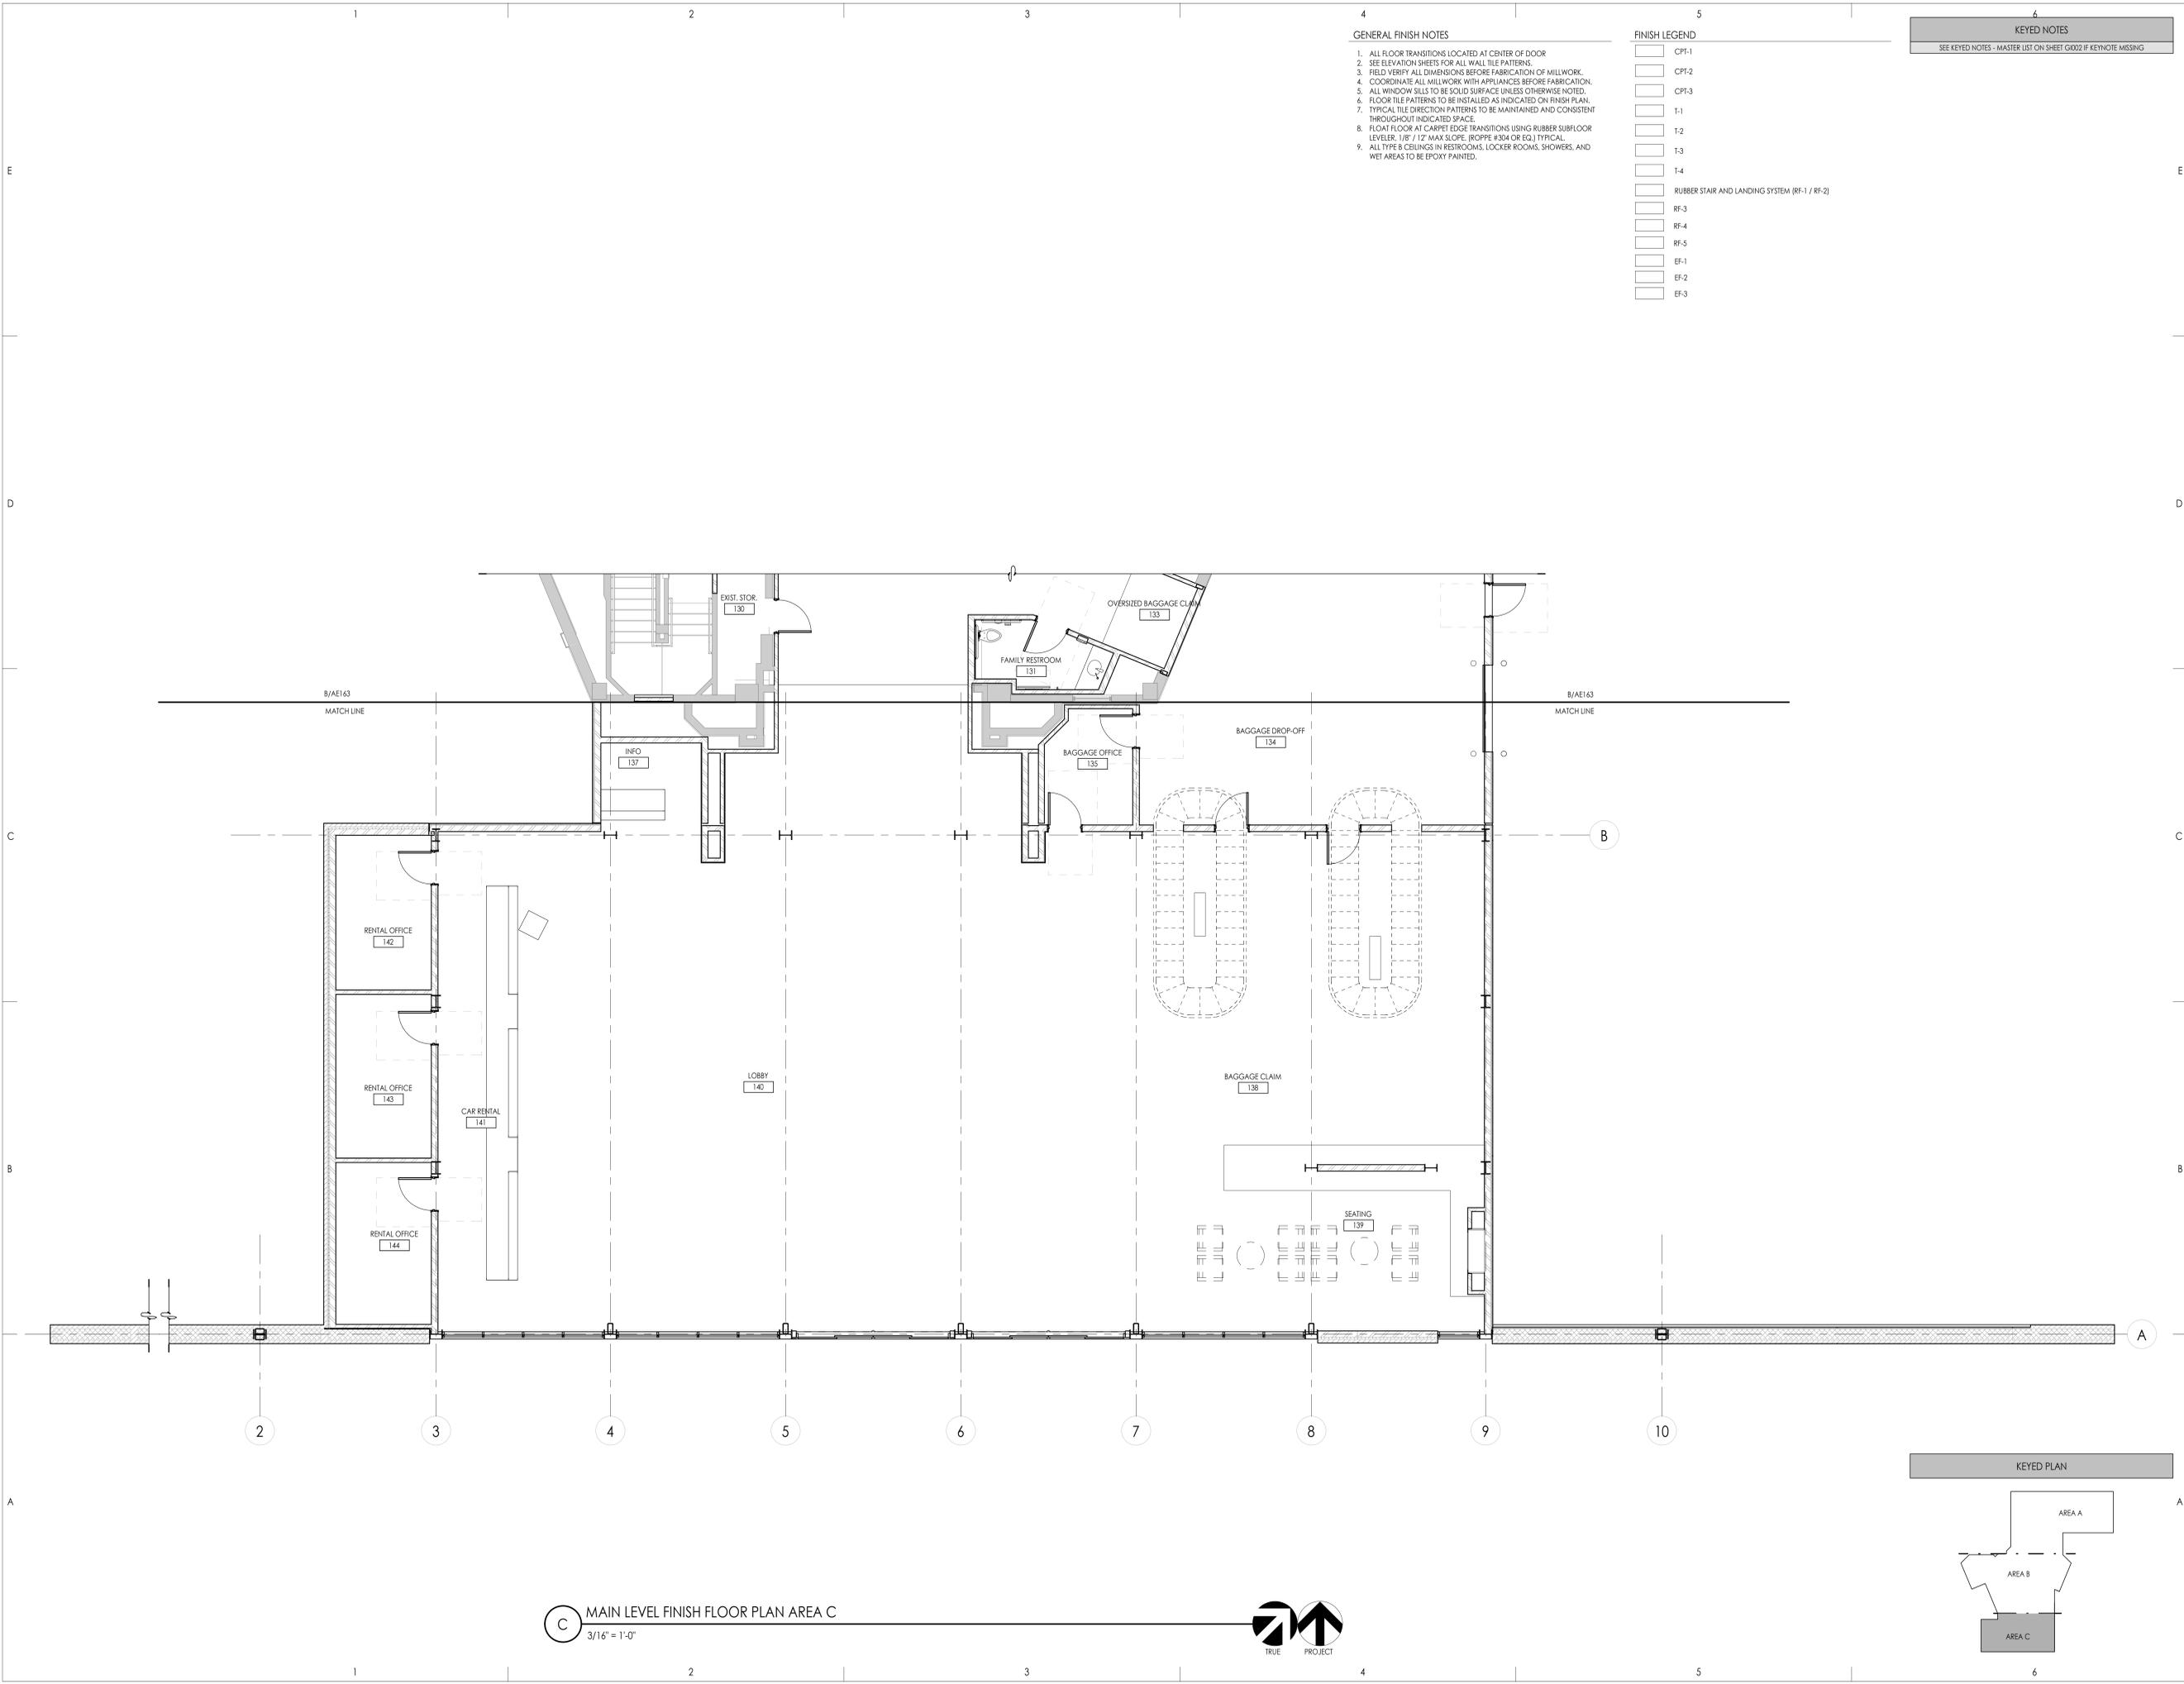

C MAIN LEVEL FINISH FLOOR PLAN AREA C
3/16" = 1'-0"



KEYED PLAN

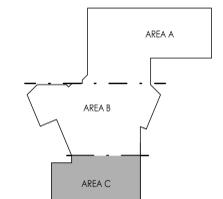

OGDEN-HINCKLEY AIRPORT
TERMINAL EXPANSION
3909 AIRPORT ROAD
OGDEN, UT 84405

Project Name

Issued		
No.	Date	Description
1	11-15-2022	BID SET

Revision

Revision		
No.	Date	Description

SAA Project No. 2021-10
Drawing Title

MAIN LEVEL FINISH FLOOR PLAN AREA C

Sheet Number

AE164




KEYED NOTES
 SEE KEYED NOTES - MASTER LIST ON SHEET G002 IF KEYNOTE MISSING
 12.01 FURNISHINGS BY OTHERS


FINISH LEGEND

[Pattern]	CPT-1
[Pattern]	CPT-2
[Pattern]	CPT-3
[Pattern]	T-1
[Pattern]	T-2
[Pattern]	T-3
[Pattern]	T-4
[Pattern]	RUBBER STAIR AND LANDING SYSTEM (RF-1 / RF-2)
[Pattern]	RF-3
[Pattern]	RF-4
[Pattern]	RF-5
[Pattern]	EF-1
[Pattern]	EF-2
[Pattern]	EF-3

- GENERAL FINISH NOTES**
1. ALL FLOOR TRANSITIONS LOCATED AT CENTER OF DOOR
 2. SEE ELEVATION SHEETS FOR ALL WALL TILE PATTERNS.
 3. FIELD VERIFY ALL DIMENSIONS BEFORE FABRICATION OF MILLWORK.
 4. COORDINATE ALL MILLWORK WITH APPLIANCES BEFORE FABRICATION.
 5. ALL WINDOW SILLS TO BE SOLID SURFACE UNLESS OTHERWISE NOTED.
 6. FLOOR TILE PATTERNS TO BE INSTALLED AS INDICATED ON FINISH PLAN.
 7. TYPICAL TILE DIRECTION PATTERNS TO BE MAINTAINED AND CONSISTENT THROUGHOUT INDICATED SPACE.
 8. FLOAT FLOOR AT CARPET EDGE TRANSITIONS USING RUBBER SUBFLOOR LEVELER: 1/8" / 1/2" MAX SLOPE (ROPPE #304 OR EQ.) TYPICAL.
 9. ALL TYPE B CEILINGS IN RESTROOMS, LOCKER ROOMS, SHOWERS, AND WET AREAS TO BE EPOXY PAINTED.

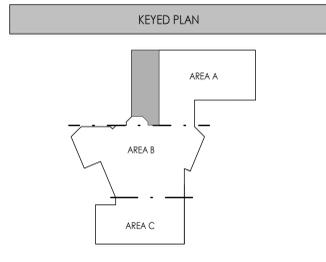

A SECOND LEVEL FINISH FLOOR PLAN
 3/16" = 1'-0"

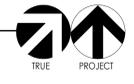

SAA
 SANDERS ASSOCIATES ARCHITECTS
 2088 Grant Avenue
 Ogden, Utah 84405
 Phone: 801.831.7300
 www.sandersaia.com



General Contractor

STACEY
 CONSTRUCTION

Stacey Construction
 Construction Manager
 General Contractor
 3788 Pacific Ave.
 Ogden, UT 84405
 801.821.6210
 www.staceycg.com

Consultant

OGDEN-HINCKLEY AIRPORT
TERMINAL EXPANSION
 3909 AIRPORT ROAD
 OGDEN, UT 84405

Project Name

Issued		
No.	Date	Description
1	11-15-2022	BID SET

Revision


Revision		
No.	Date	Description

SAA Project No. 2021-10
 Drawing Title


SECOND LEVEL FINISH FLOOR PLAN

Sheet Number

AE165

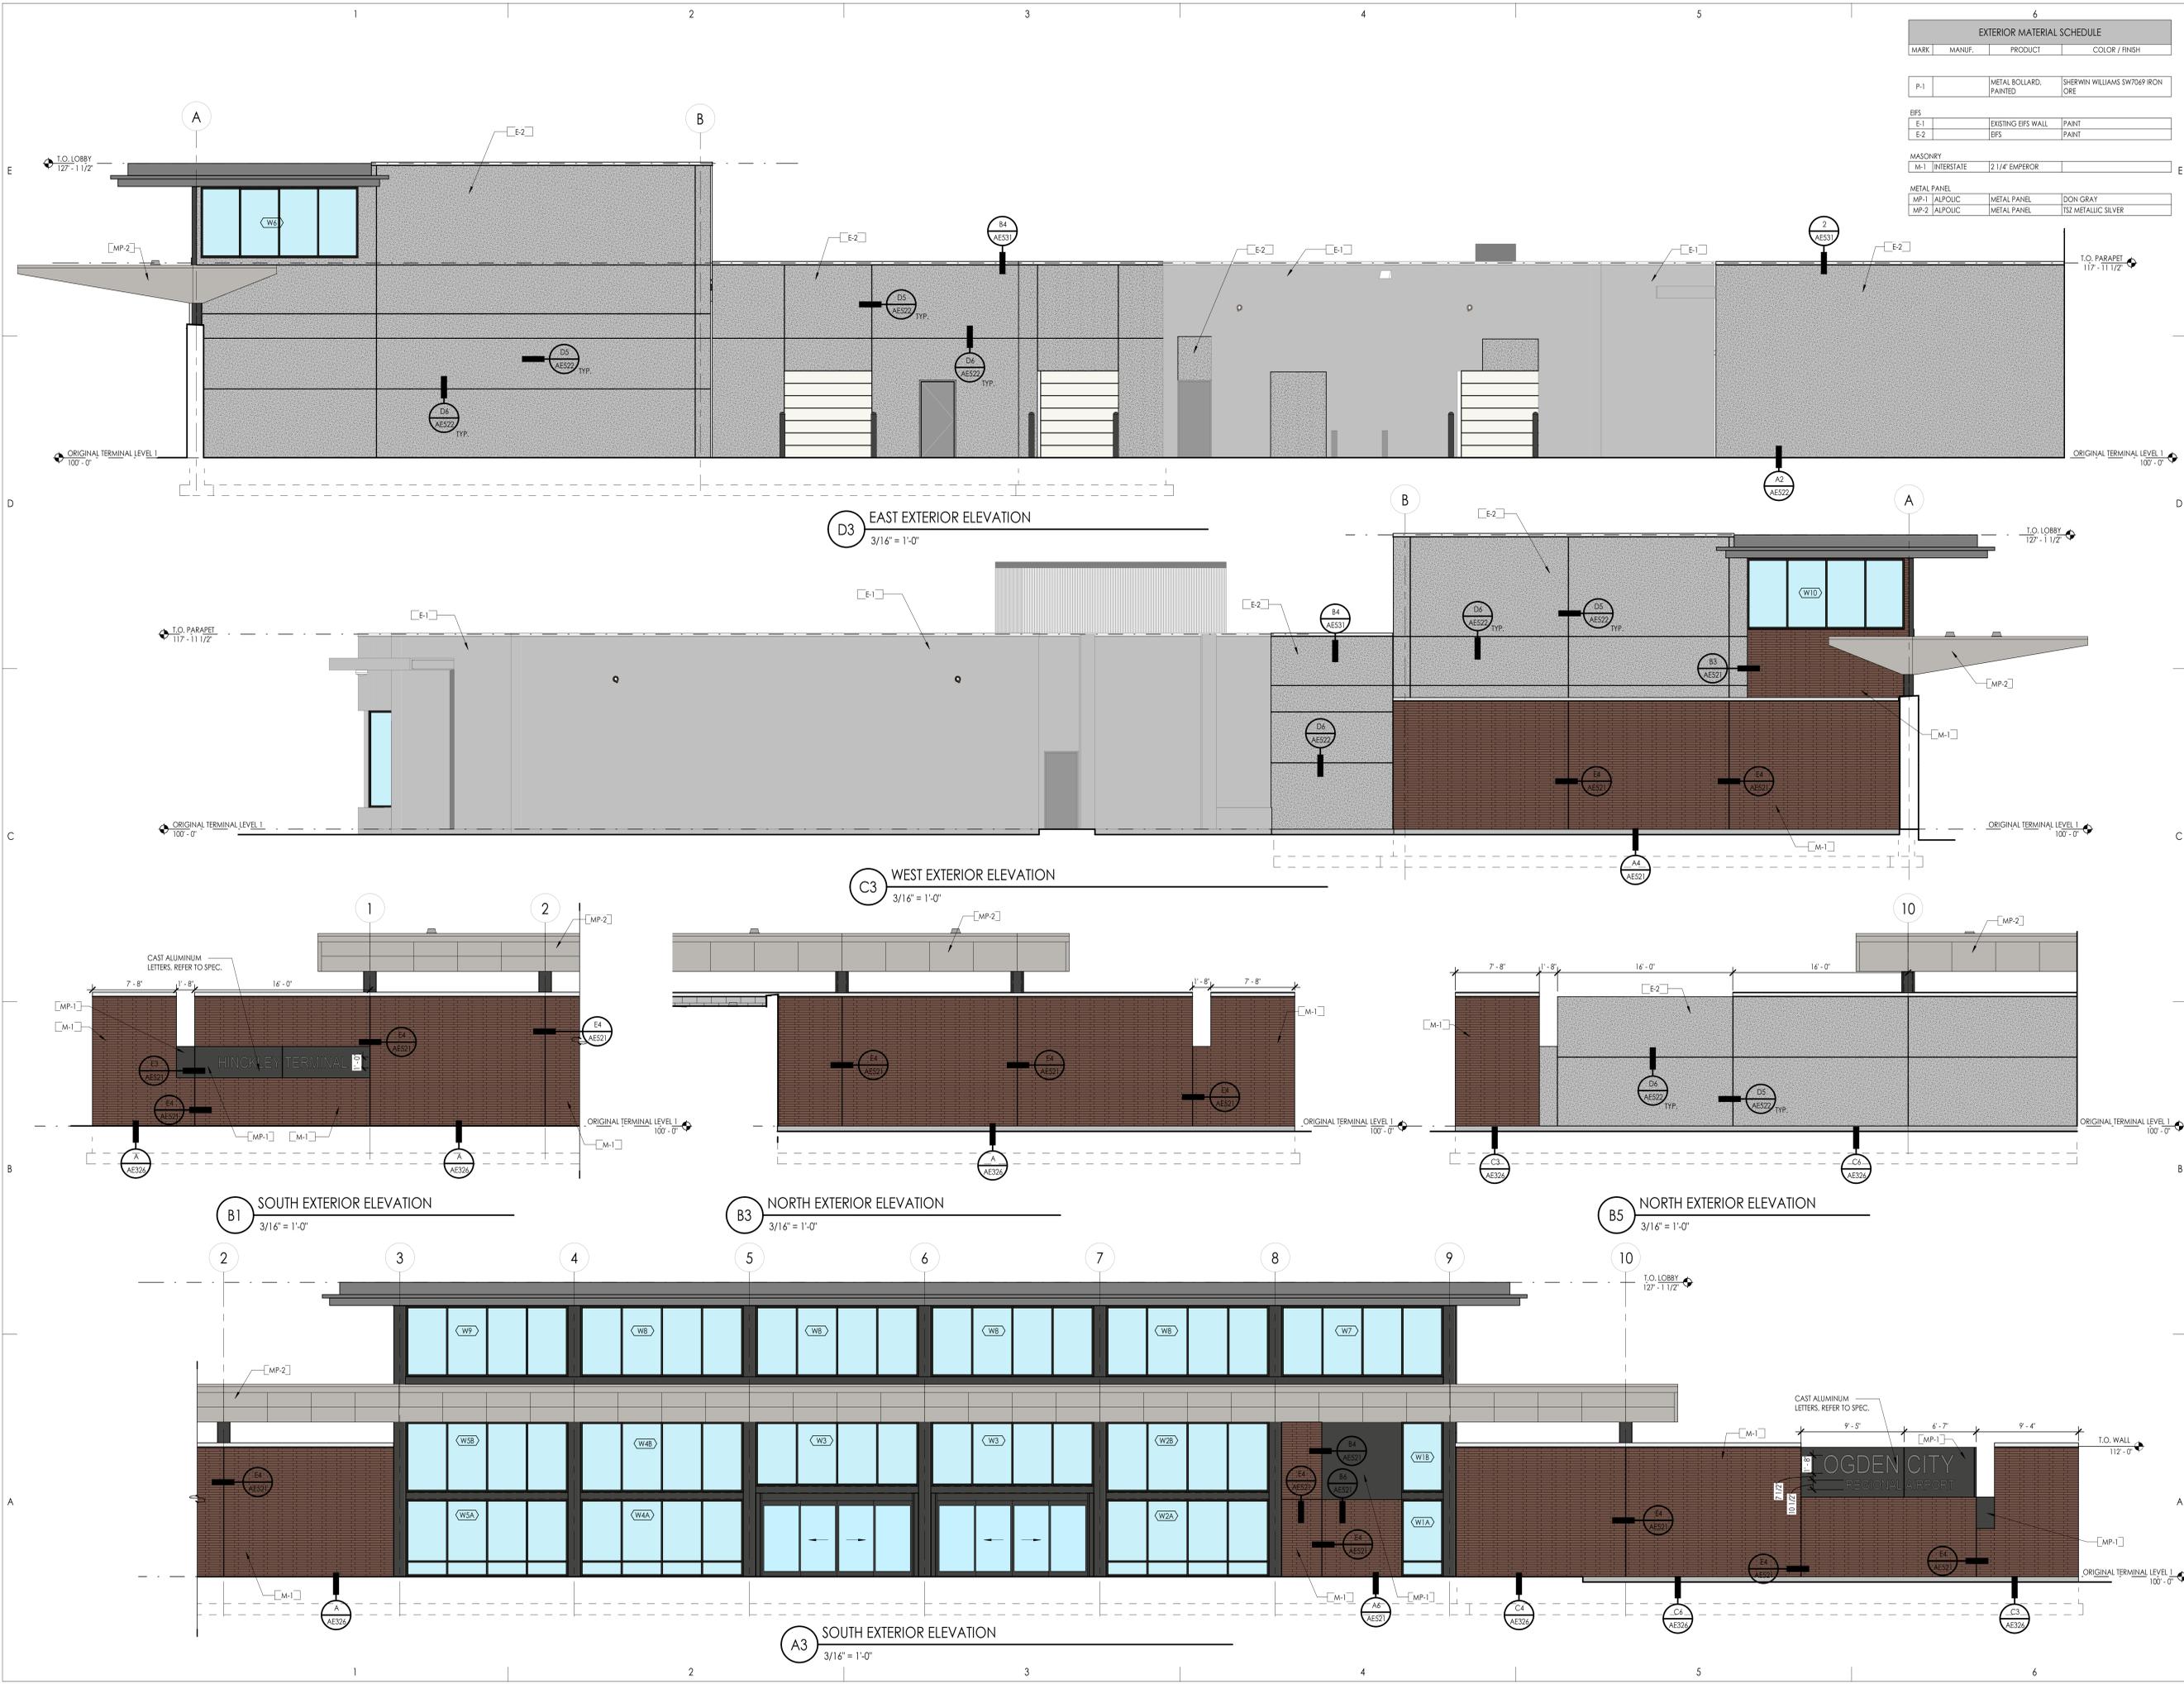

EXTERIOR MATERIAL SCHEDULE		
MARK	MANUF.	COLOR / FINISH
P-1	METAL BOLLARD, PAINTED	SHERWIN WILLIAMS SW7069 IRON GRE
EFS		
E-1	EXISTING EFS WALL	PAINT
E-2	EFS	PAINT
MASONRY		
M-1	INTERSTATE 2 1/4" EMPEROR	
METAL PANEL		
MP-1	ALPOLIC	DON GRAY
MP-2	ALPOLIC	152 METALLIC SILVER

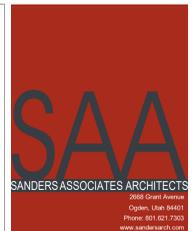

General Contractor
STACEY CONSTRUCTION
 Stacey Construction
 Construction Manager
 General Contractor
 3788 Pacific Ave.
 Ogden, UT 84405
 801.621.6210
 www.staceycg.com
 Consultant


OGDEN-HINCKLEY AIRPORT
TERMINAL EXPANSION
 3909 AIRPORT ROAD
 OGDEN, UT 84405

Project Name		
OGDEN-HINCKLEY AIRPORT TERMINAL EXPANSION		
Issued		
No.	Date	Description
1	11-15-2022	BID SET
Revision		
No.	Date	Description
SAA Project No. 2021-10		
Drawing Title		

EXTERIOR ELEVATIONS
 Sheet Number
AE201



EXTERIOR MATERIAL SCHEDULE			
MARK	MANUF.	PRODUCT	COLOR / FINISH
P-1	METAL BOLLARD, PAINTED	SHERWIN WILLIAMS SW7069 IRON GRE	
EFS			
E-1	EXISTING EFS WALL	PAINT	
E-2	EFS	PAINT	
MASONRY			
M-1	INTERSTATE	2 1/4" EMPEROR	
METAL PANEL			
MP-1	ALPOUC	METAL PANEL	DON GRAY
MP-2	ALPOUC	METAL PANEL	152 METALLIC SILVER

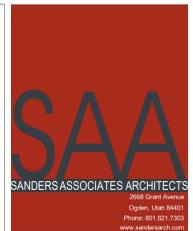

General Contractor
STACEY CONSTRUCTION
 Stacey Construction
 Construction Manager
 General Contractor
 3788 Pacific Ave.
 Ogden, UT 84405
 801.821.6210
 www.staceycgo.com
 Consultant

Project Name
OGDEN-HINCKLEY AIRPORT
TERMINAL EXPANSION
 3909 AIRPORT ROAD
 OGDEN, UT 84405

Issued		
No.	Date	Description
1	11-15-2022	BID SET
Revision		
No.	Date	Description



SAA Project No. 2021-10
 Drawing Title

EXTERIOR ELEVATIONS

Sheet Number

AE202

EXTERIOR MATERIAL SCHEDULE			
MARK	MANUF.	PRODUCT	COLOR / FINISH
P-1		METAL BOLLARD, PAINTED	SHERWIN WILLIAMS SW7069 IRON GRE
EFS			
E-1		EXISTING EFS WALL	PAINT
E-2		EFS	PAINT
MASONRY			
M-1	INTERSTATE	2 1/4" EMPEROR	
METAL PANEL			
MP-1	ALPOLIC	METAL PANEL	DON GRAY
MP-2	ALPOLIC	METAL PANEL	152 METALLIC SILVER

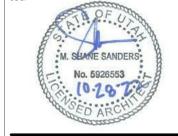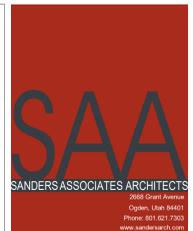


General Contractor

STACEY CONSTRUCTION

Stacey Construction
Construction Manager
General Contractor
3788 Pacific Ave.
Ogden, UT 84405
801.621.6210
www.staceycg.com

Consultant

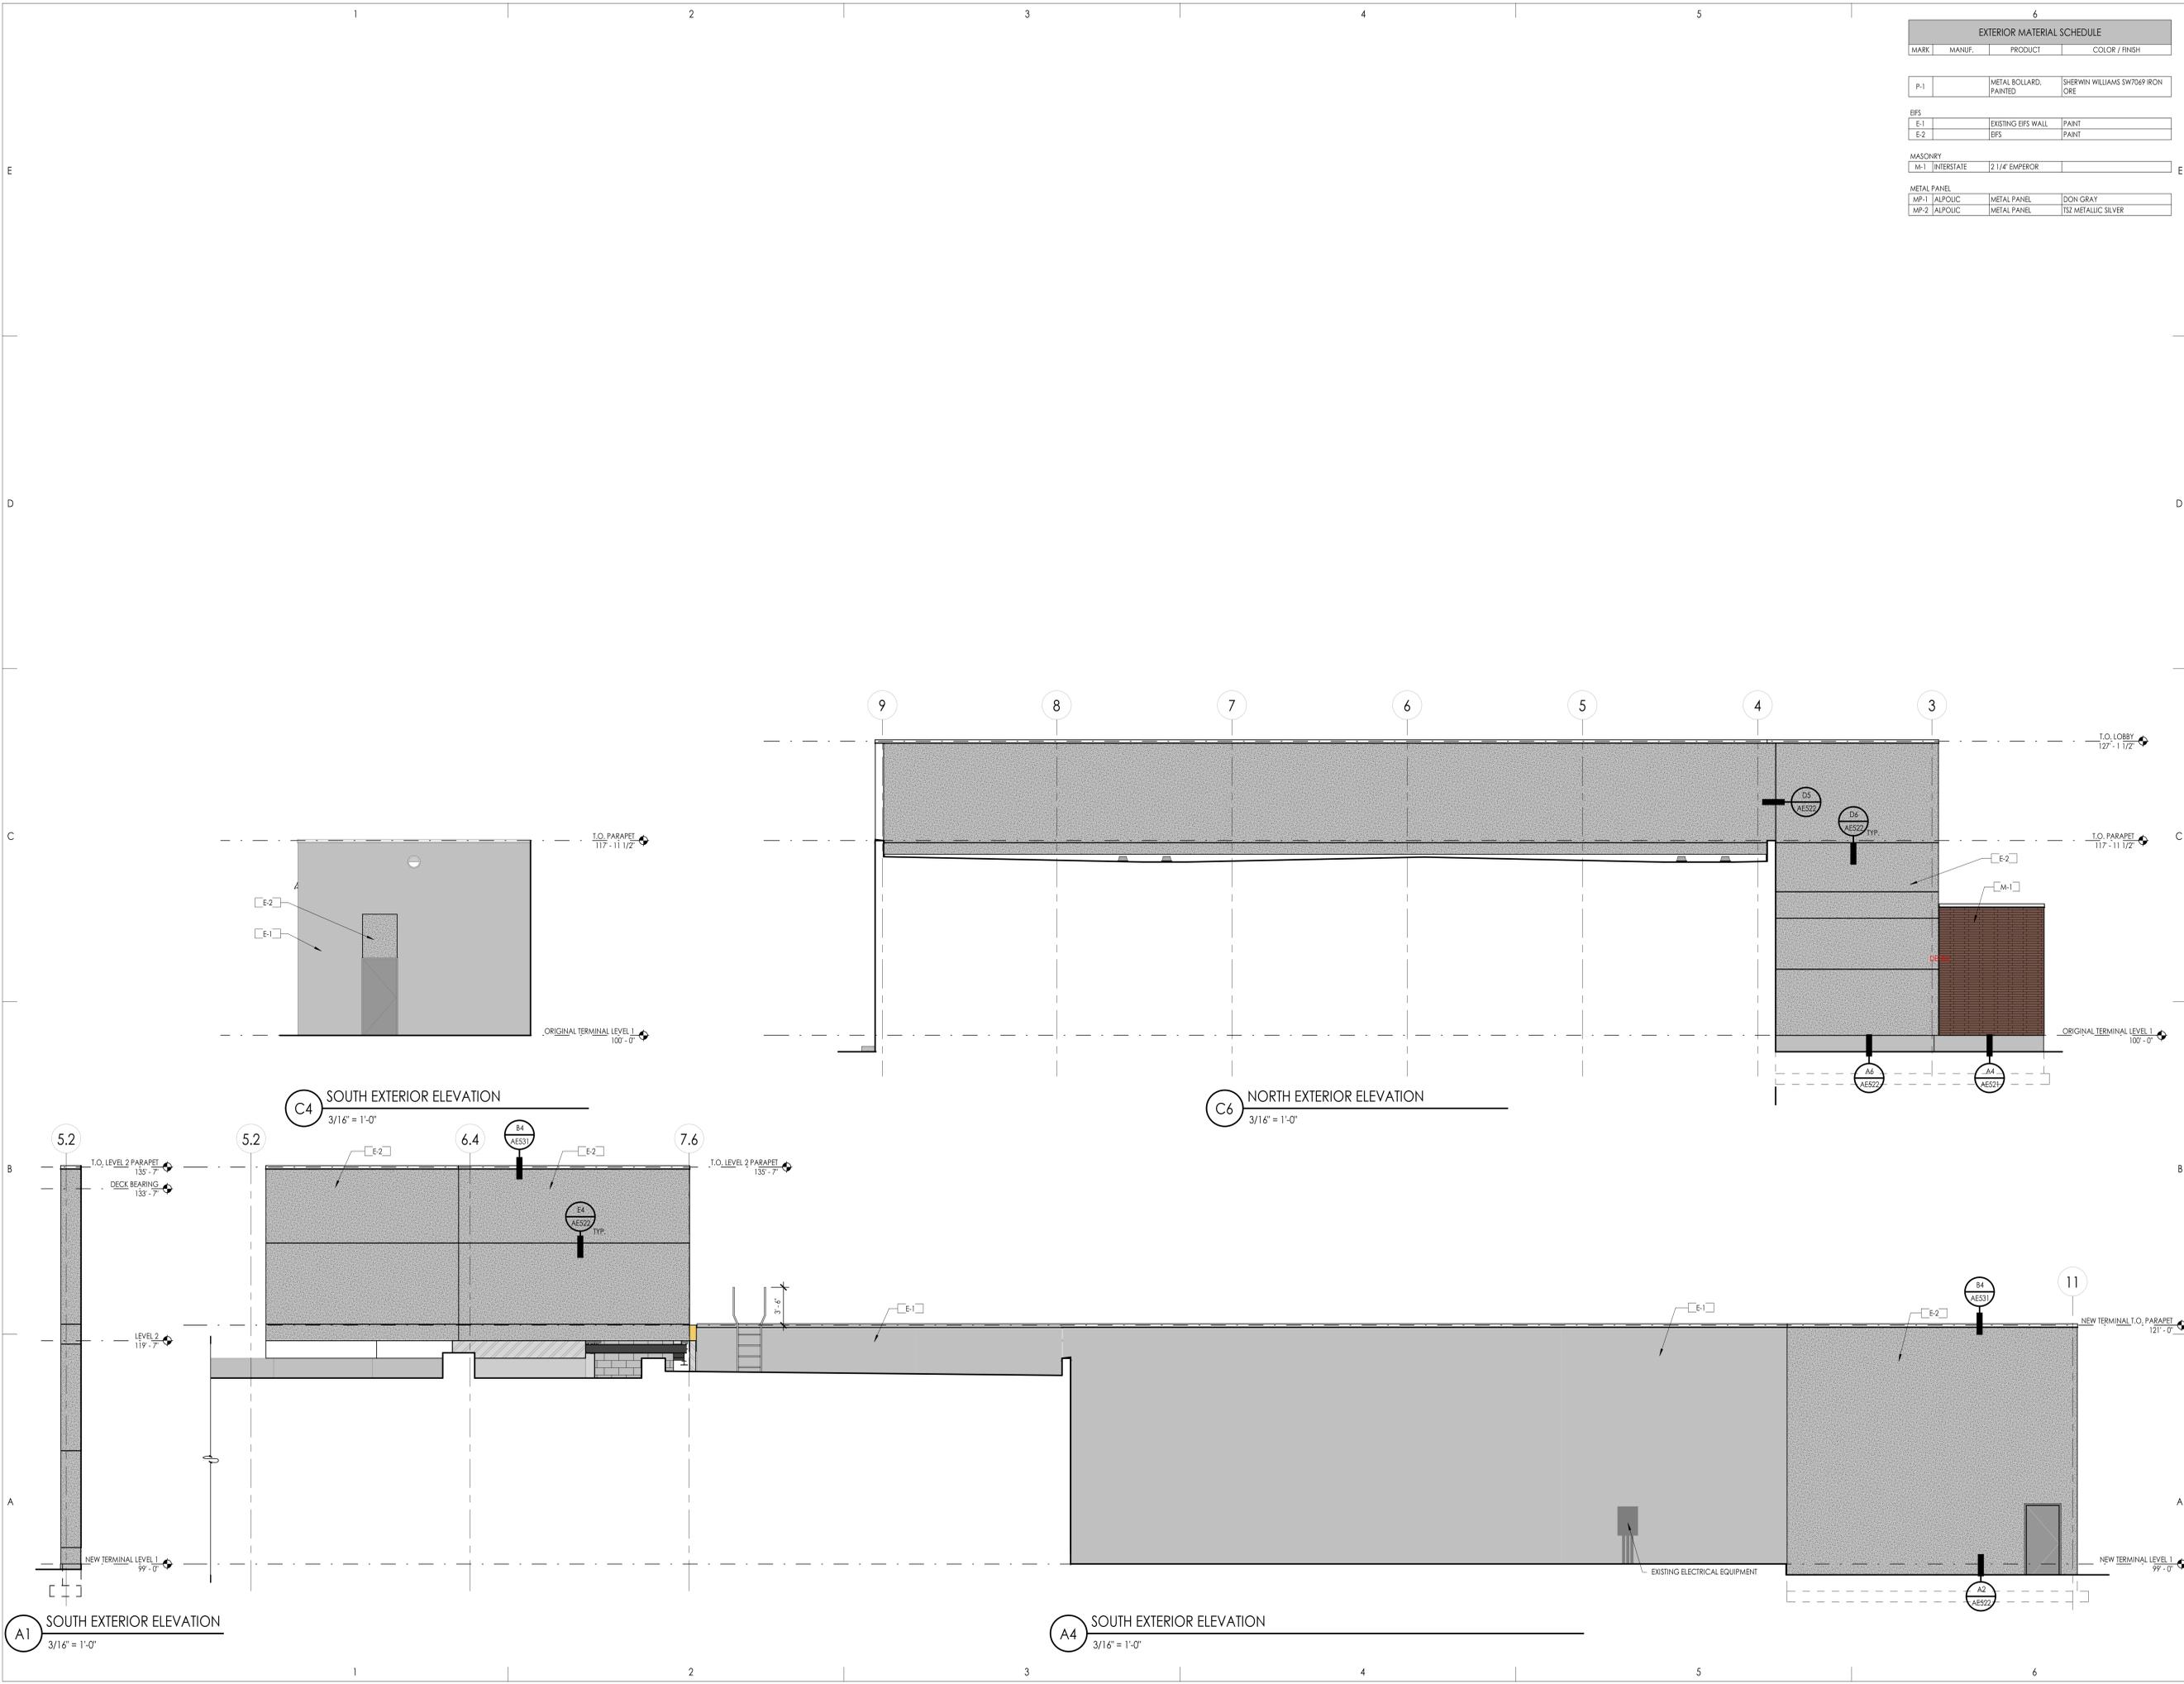


Project Name
**OGDEN-HINCKLEY AIRPORT
TERMINAL EXPANSION**
3909 AIRPORT ROAD
OGDEN, UT 84405

Issued		
No.	Date	Description
1	11-15-2022	BID SET
Revision		
No.	Date	Description


SAA Project No. 2021-10
Drawing Title

EXTERIOR ELEVATIONS

Sheet Number
AE203

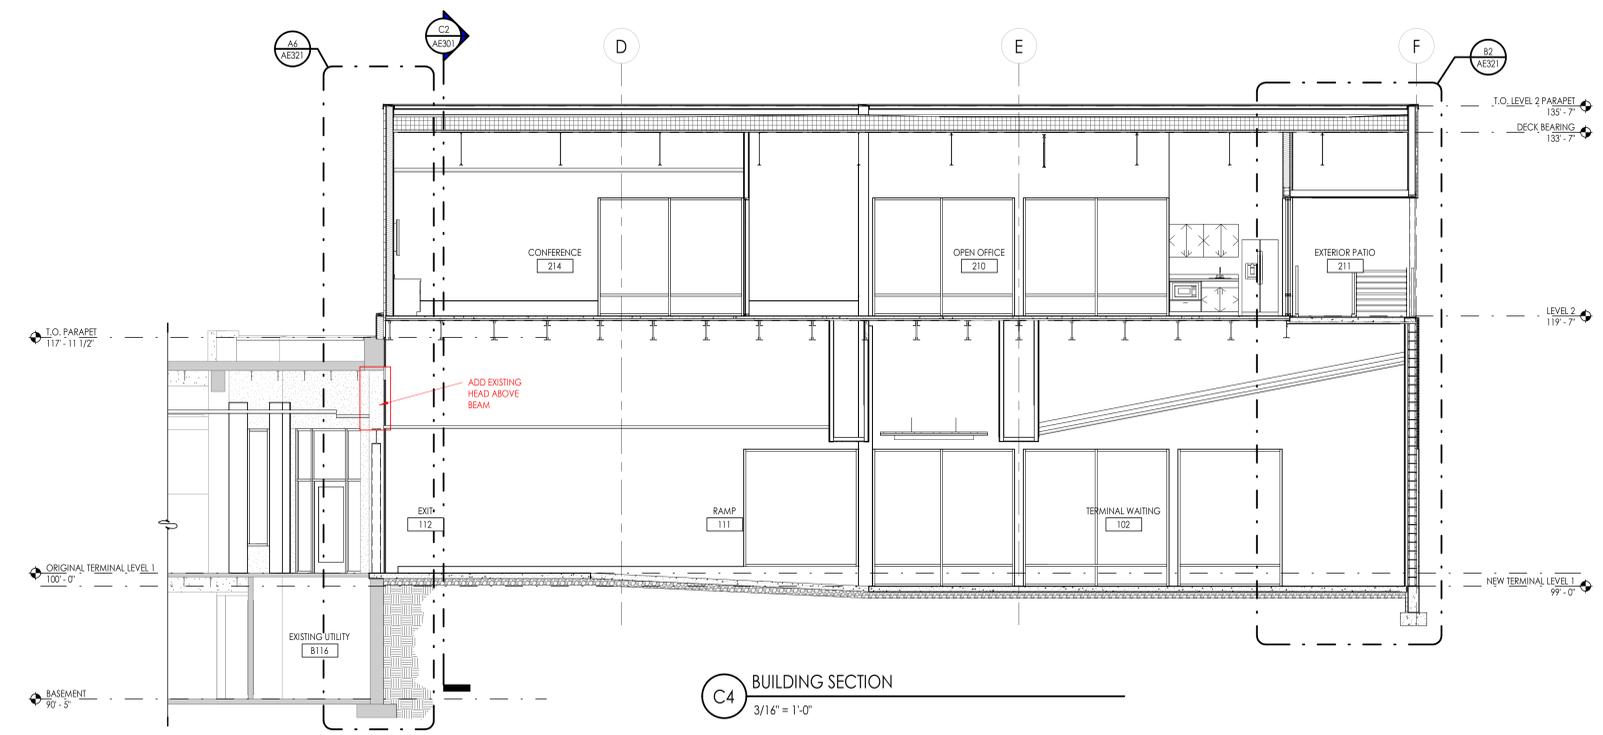

C4 BUILDING SECTION
3/16" = 1'-0"

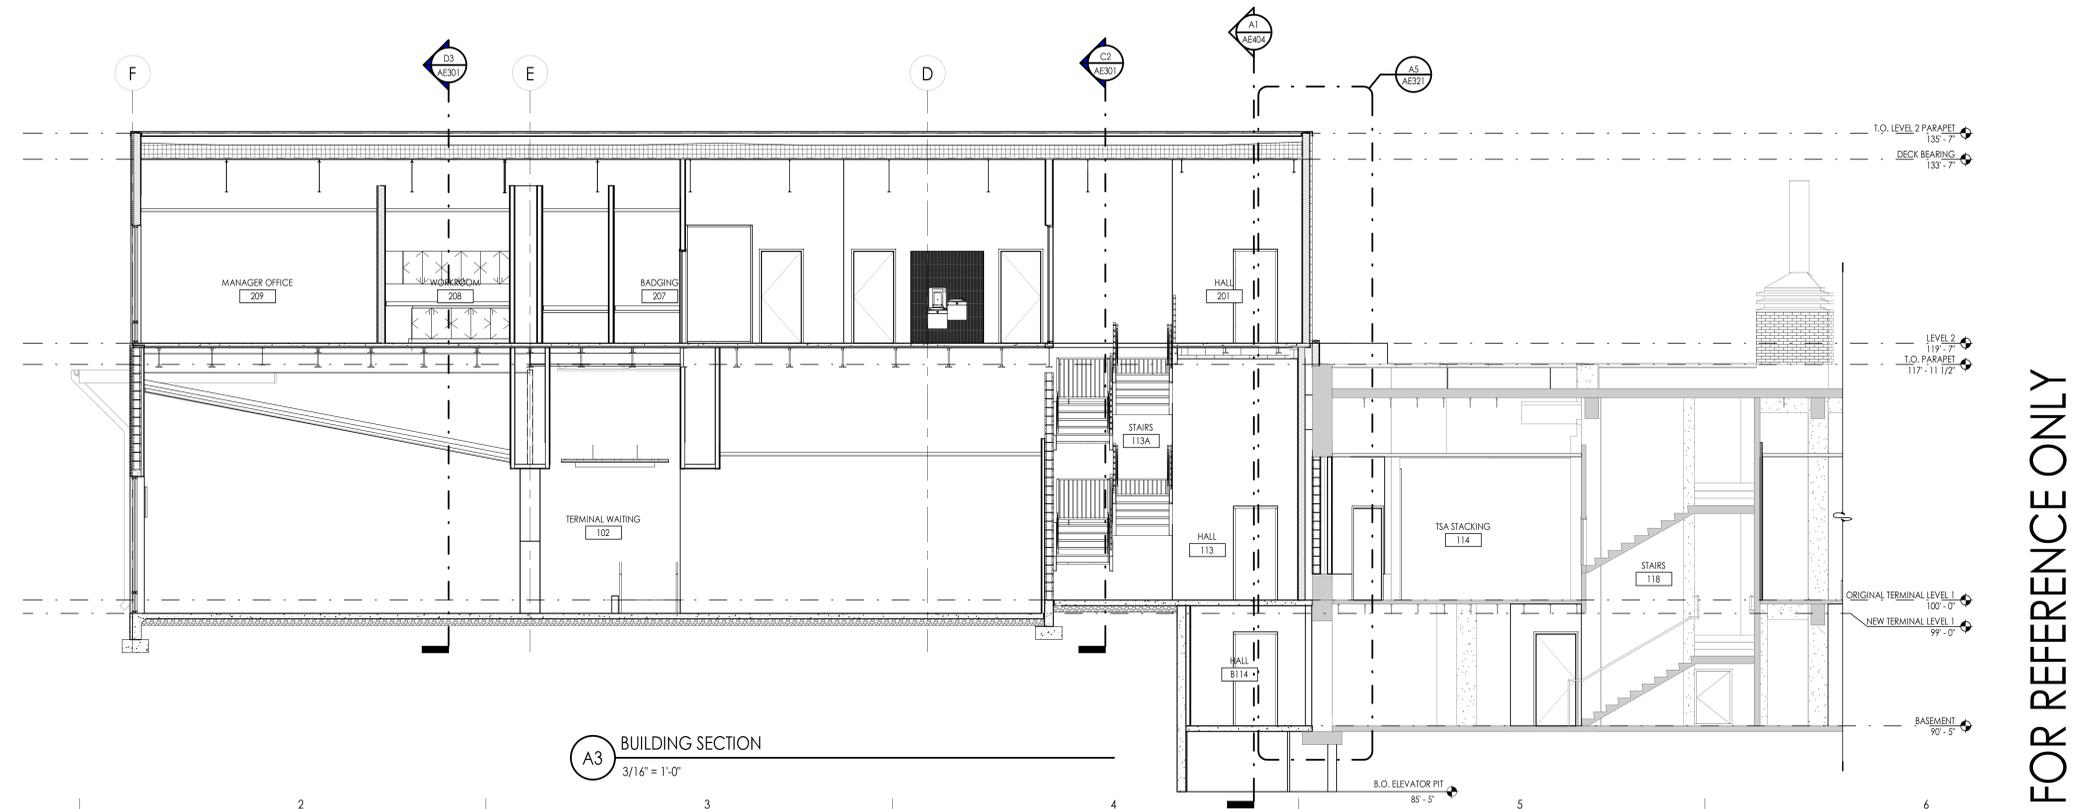

A3 BUILDING SECTION
3/16" = 1'-0"

OGDEN-HINCKLEY AIRPORT
TERMINAL EXPANSION
3909 AIRPORT ROAD
OGDEN, UT 84405

Project Name

Issued No.	Date	Description
1	11-15-2022	BID SET

Revision

No.	Date	Description

SAA Project No. 2021-10
Drawing Title

FOR REFERENCE ONLY

BUILDING SECTIONS


Sheet Number

AE302



General Contractor
STACEY CONSTRUCTION
Stacey Construction
Construction Manager
General Contractor
3788 Pacific Ave.
Ogden, UT 84405
801.821.6210
www.staceygc.com

Consultant

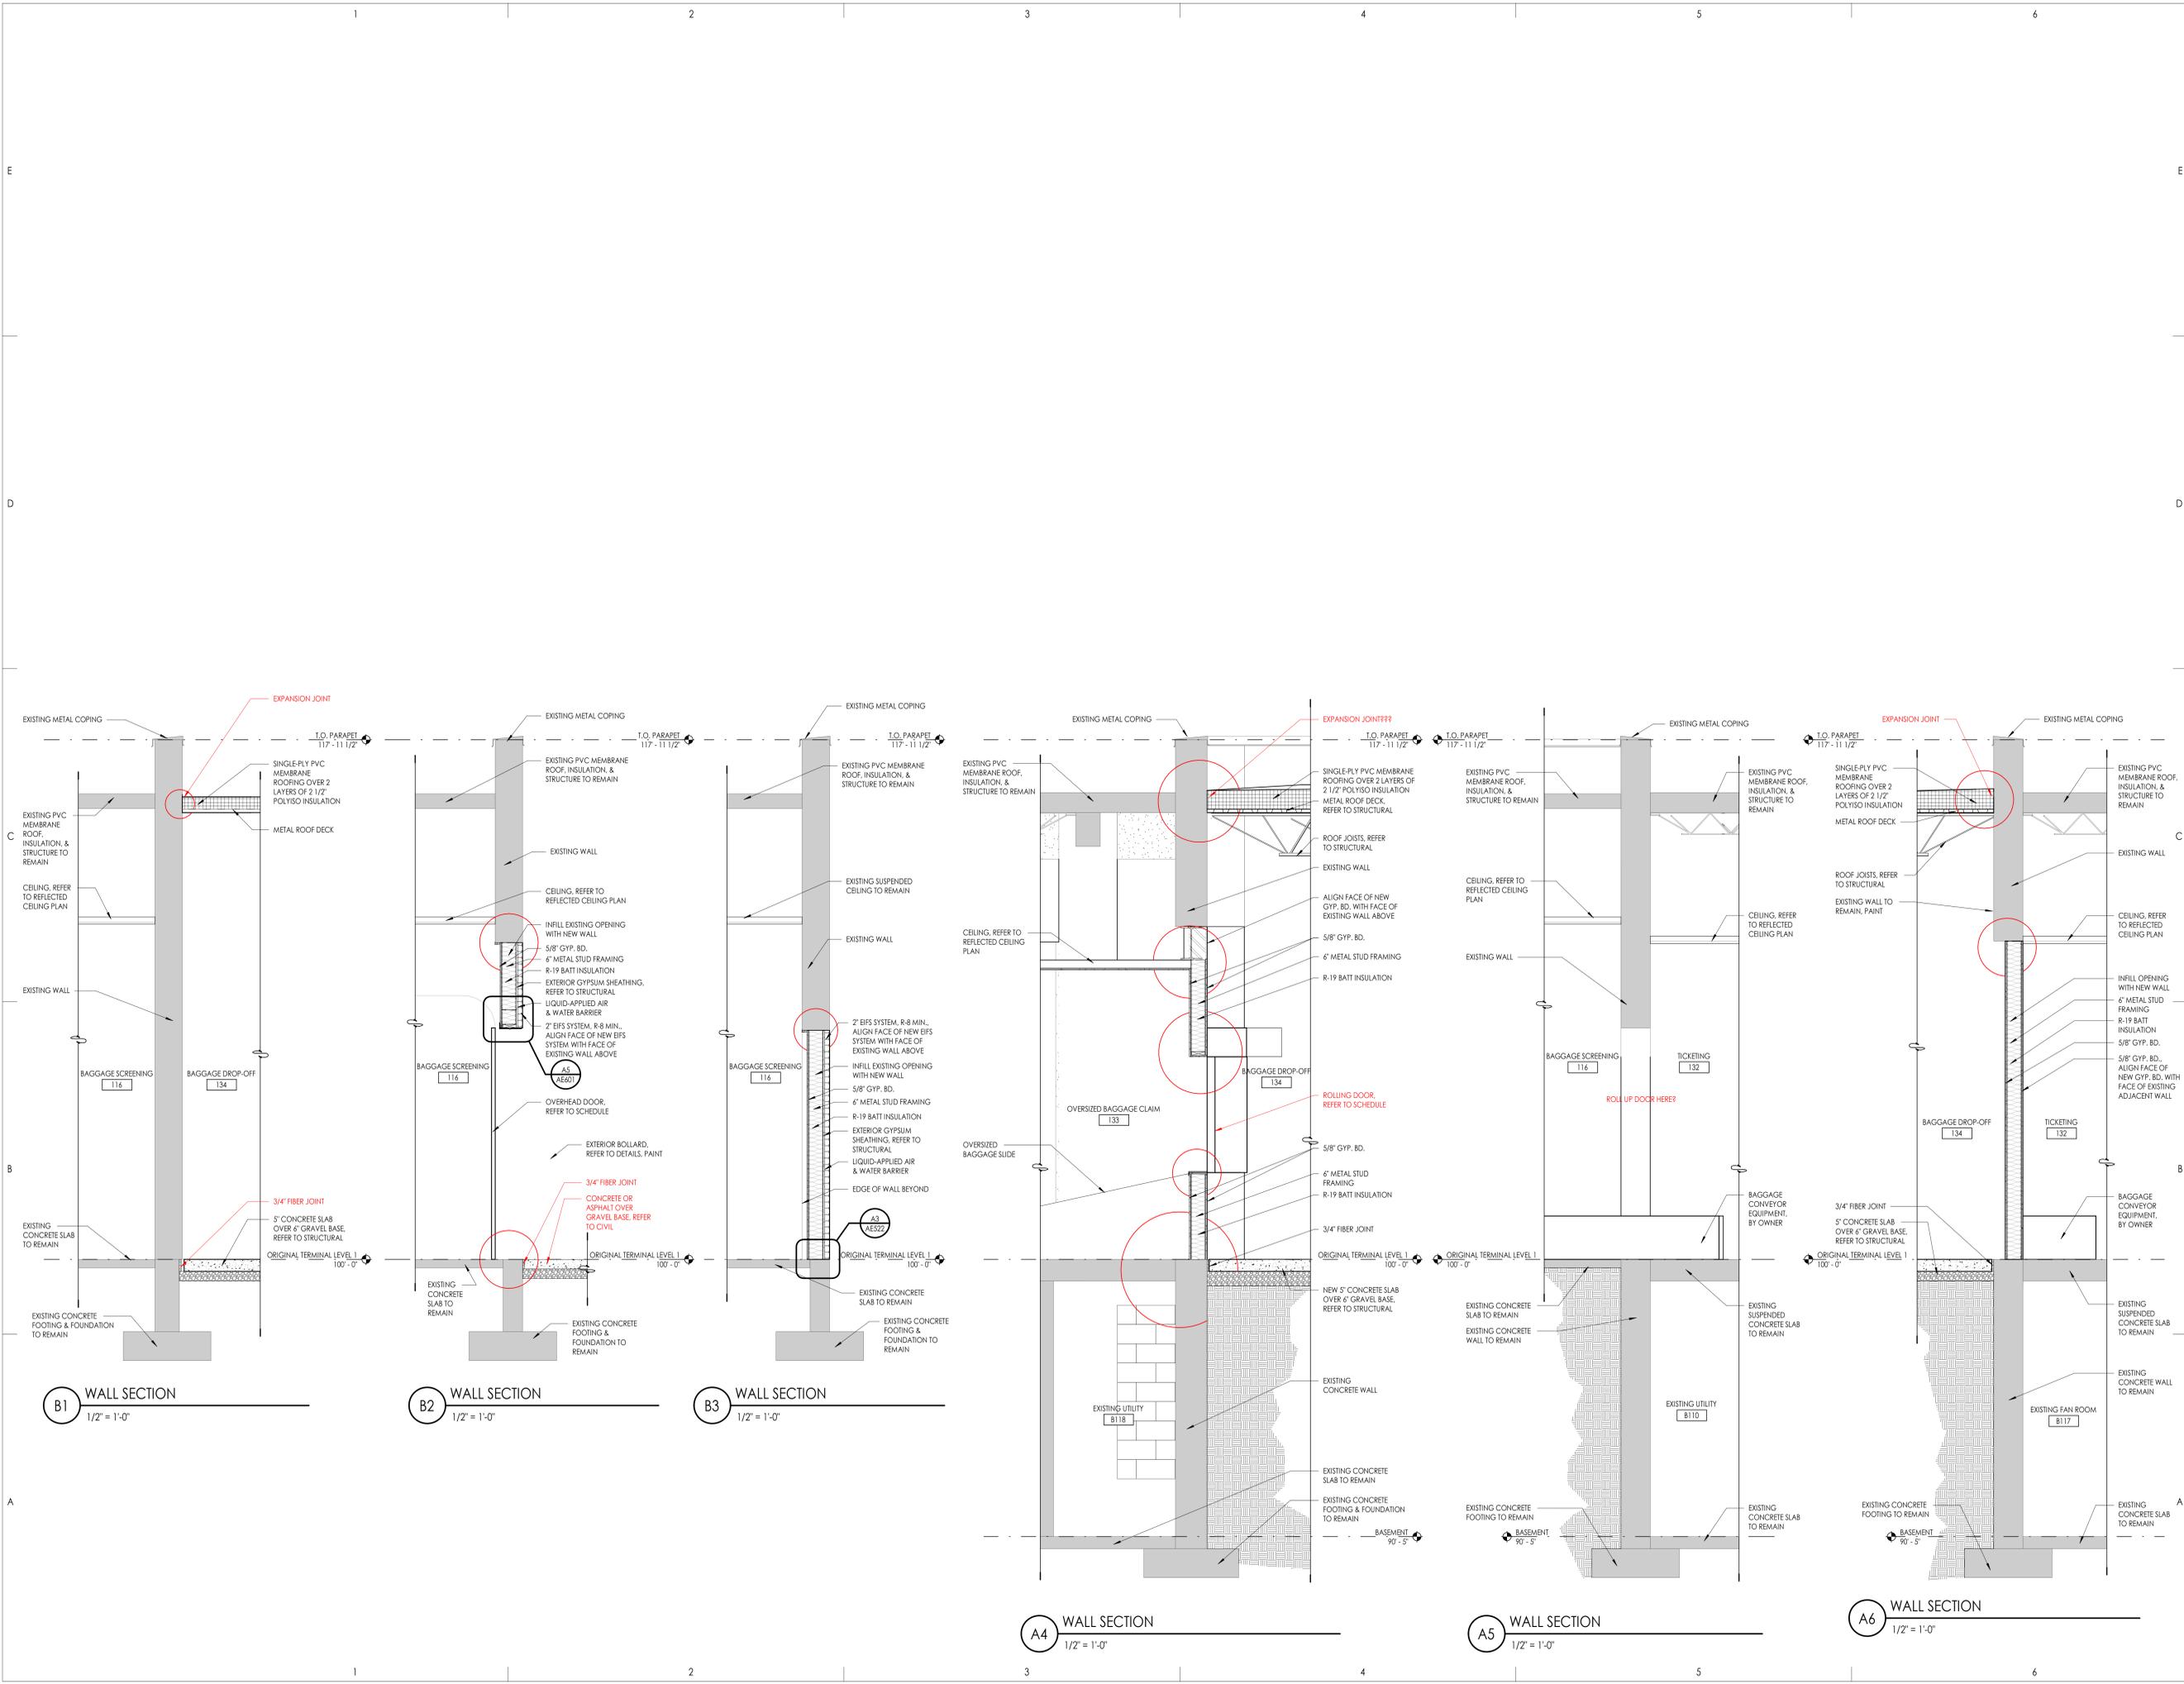

OGDEN-HINCKLEY AIRPORT
TERMINAL EXPANSION
3909 AIRPORT ROAD
OGDEN, UT 84405

Project Name


Issued		
No.	Date	Description
1	11-15-2022	BID SET
Revision		
No.	Date	Description

SAA Project No. 2021-10
Drawing Title



General Contractor
STACEY CONSTRUCTION
Stacey Construction
Construction Manager
General Contractor
3768 Pacific Ave.
Ogden, UT 84405
801.621.6210
www.staceyco.com

Consultant

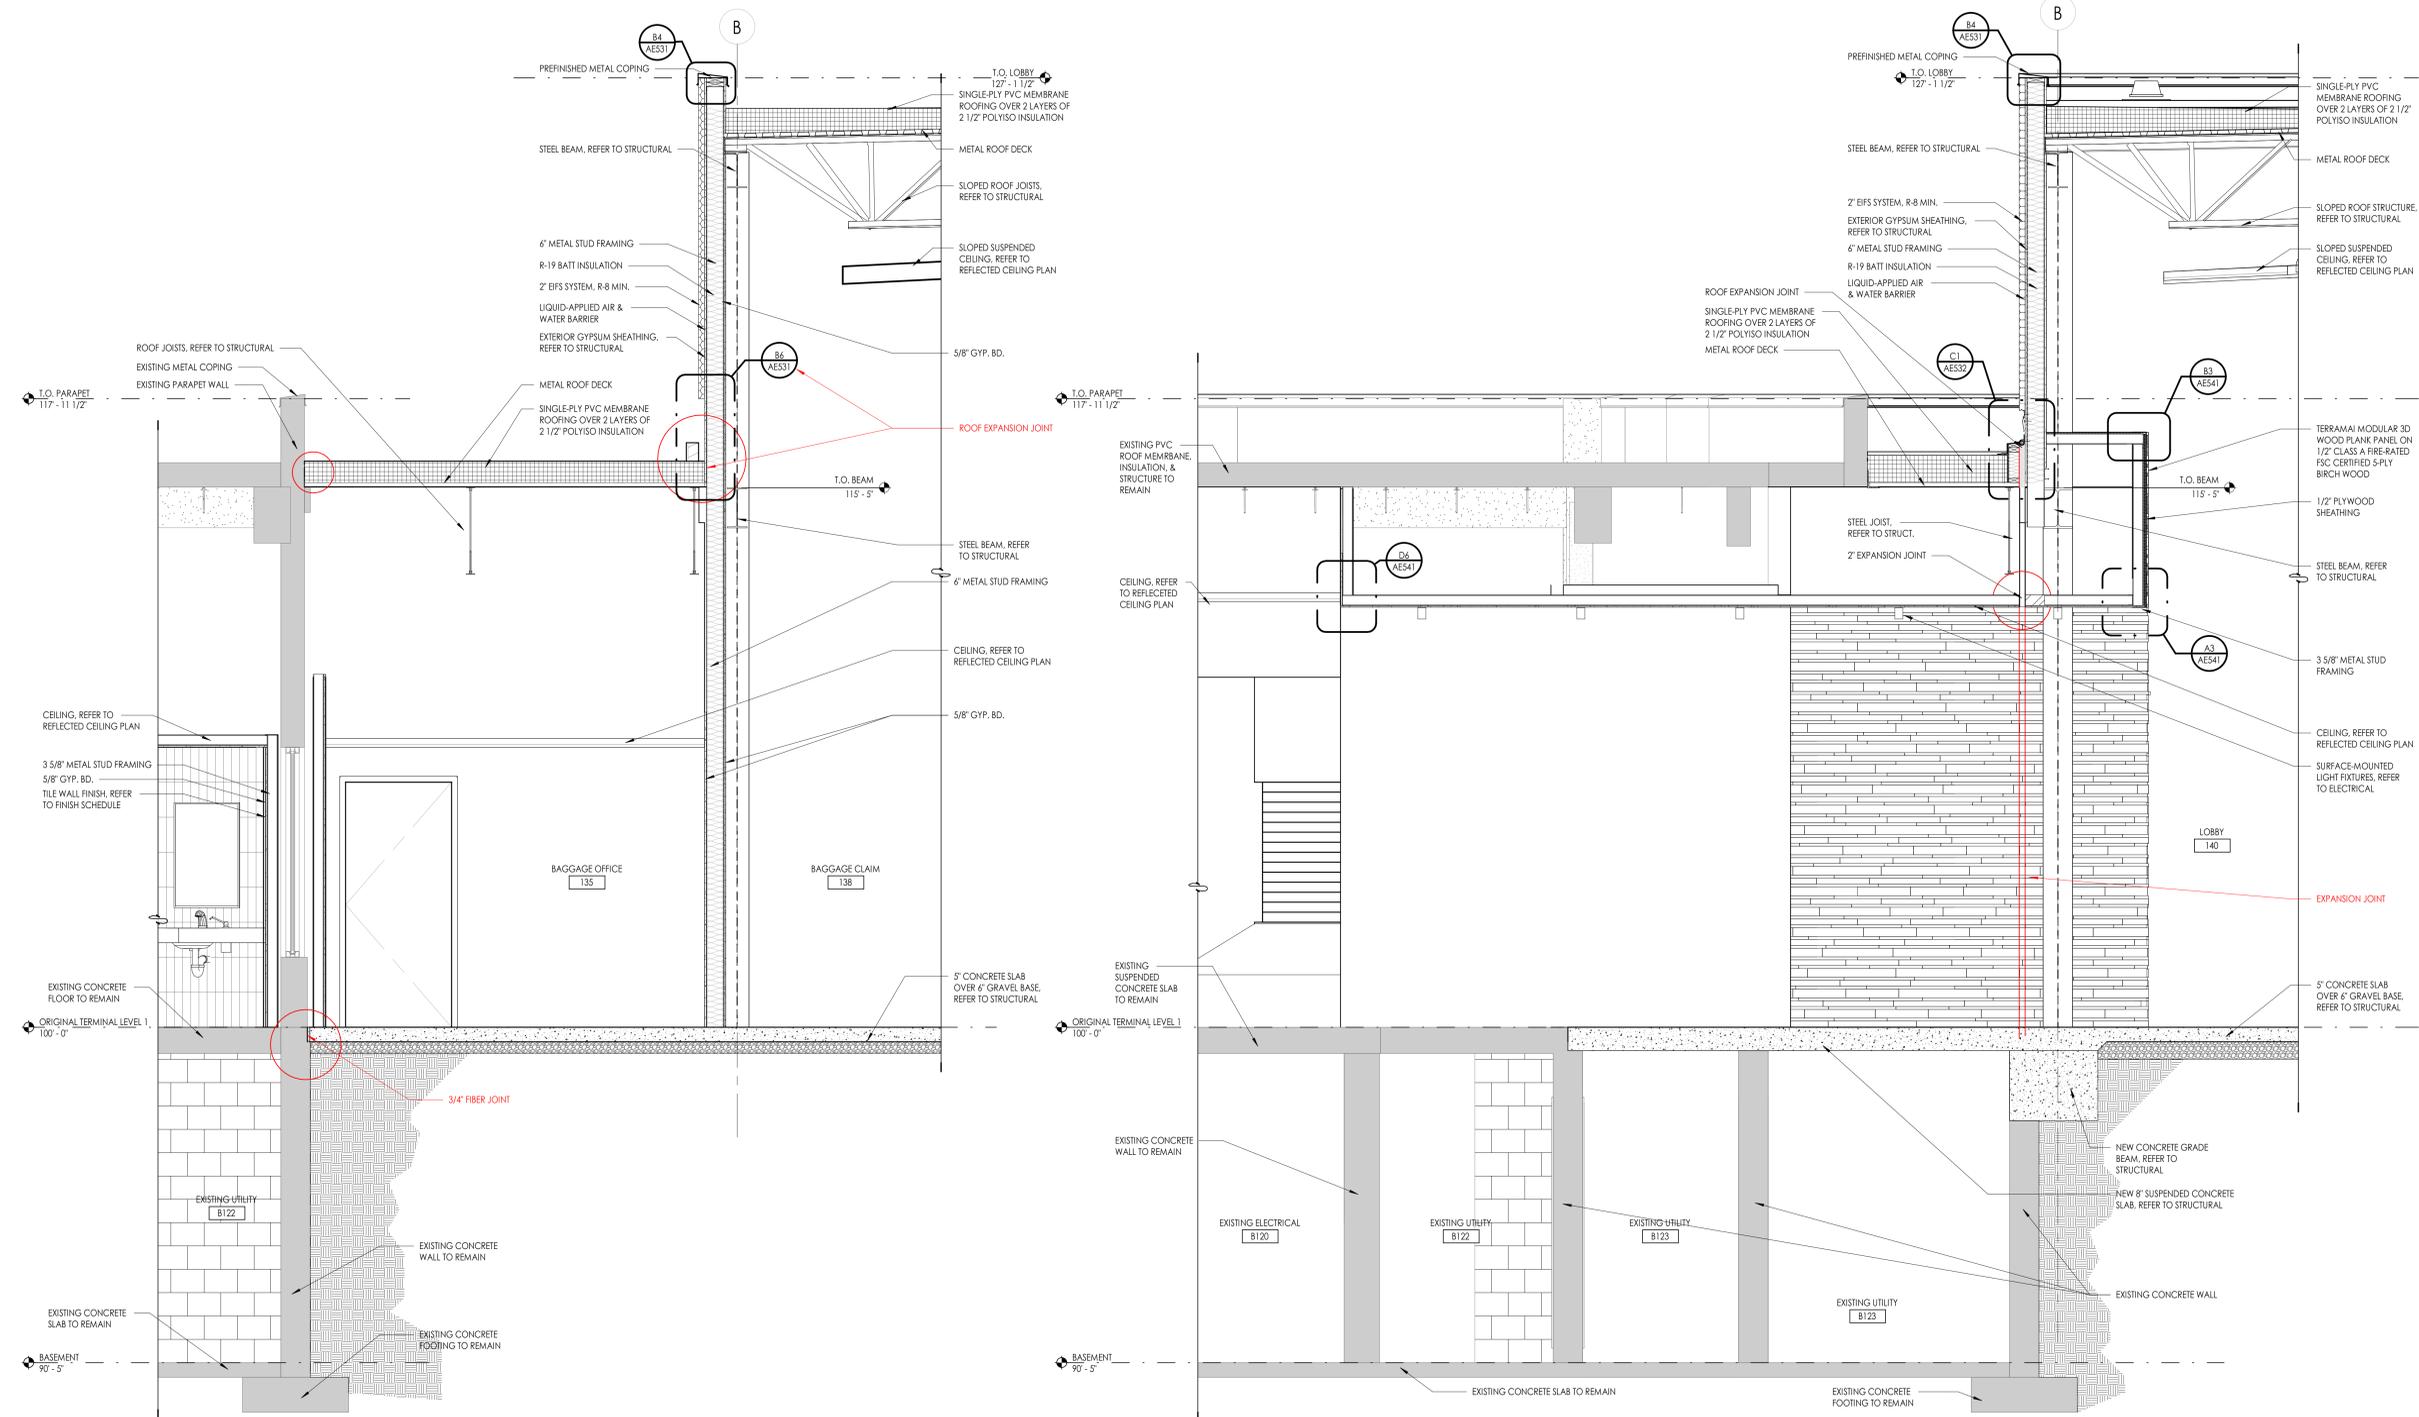

A2 WALL SECTION
1/2" = 1'-0"

A5 WALL SECTION
1/2" = 1'-0"

OGDEN-HINCKLEY AIRPORT
TERMINAL EXPANSION
3909 AIRPORT ROAD
OGDEN, UT 84405

Project Name

Issued No.	Date	Description
1	11-15-2022	BID SET

Revision


No.	Date	Description

SAA Project No. 2021-10
Drawing Title

WALL SECTIONS

Sheet Number

AE324

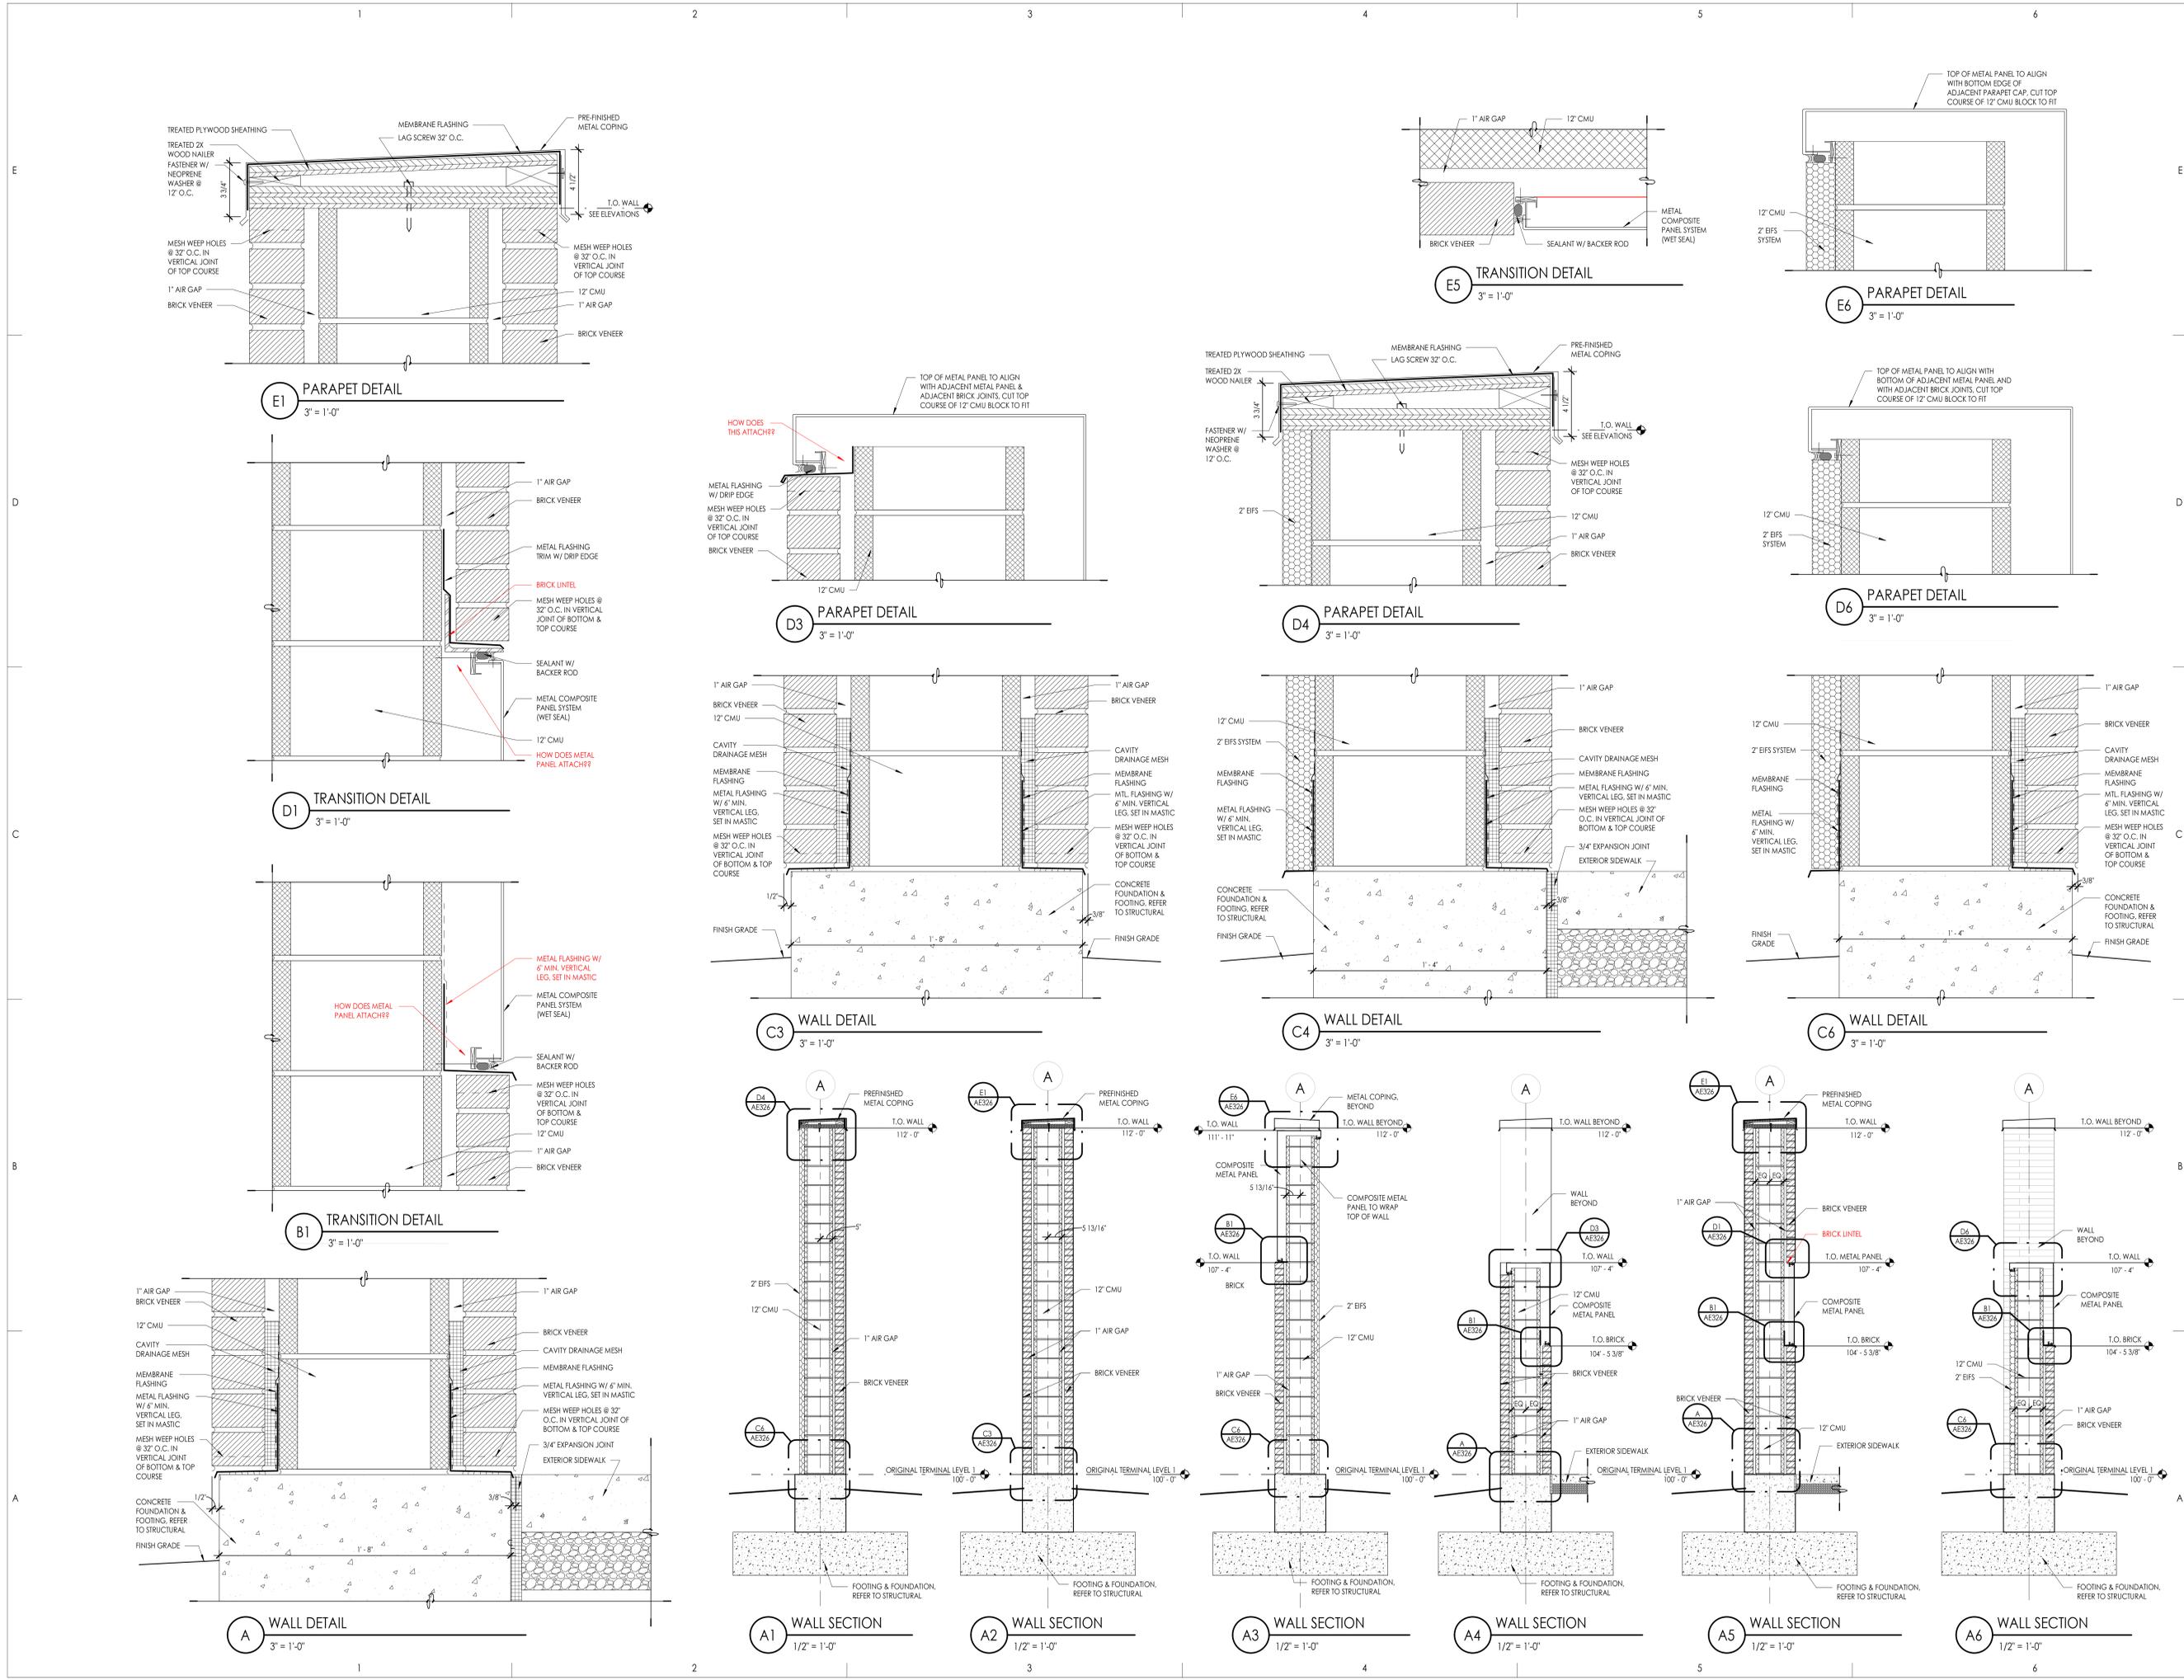

Project Name

Issued No.	Date	Description
1	11-15-2022	BID SET


Revision

No.	Date	Description
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SAA Project No. 2021-10
 Drawing Title



Consultant

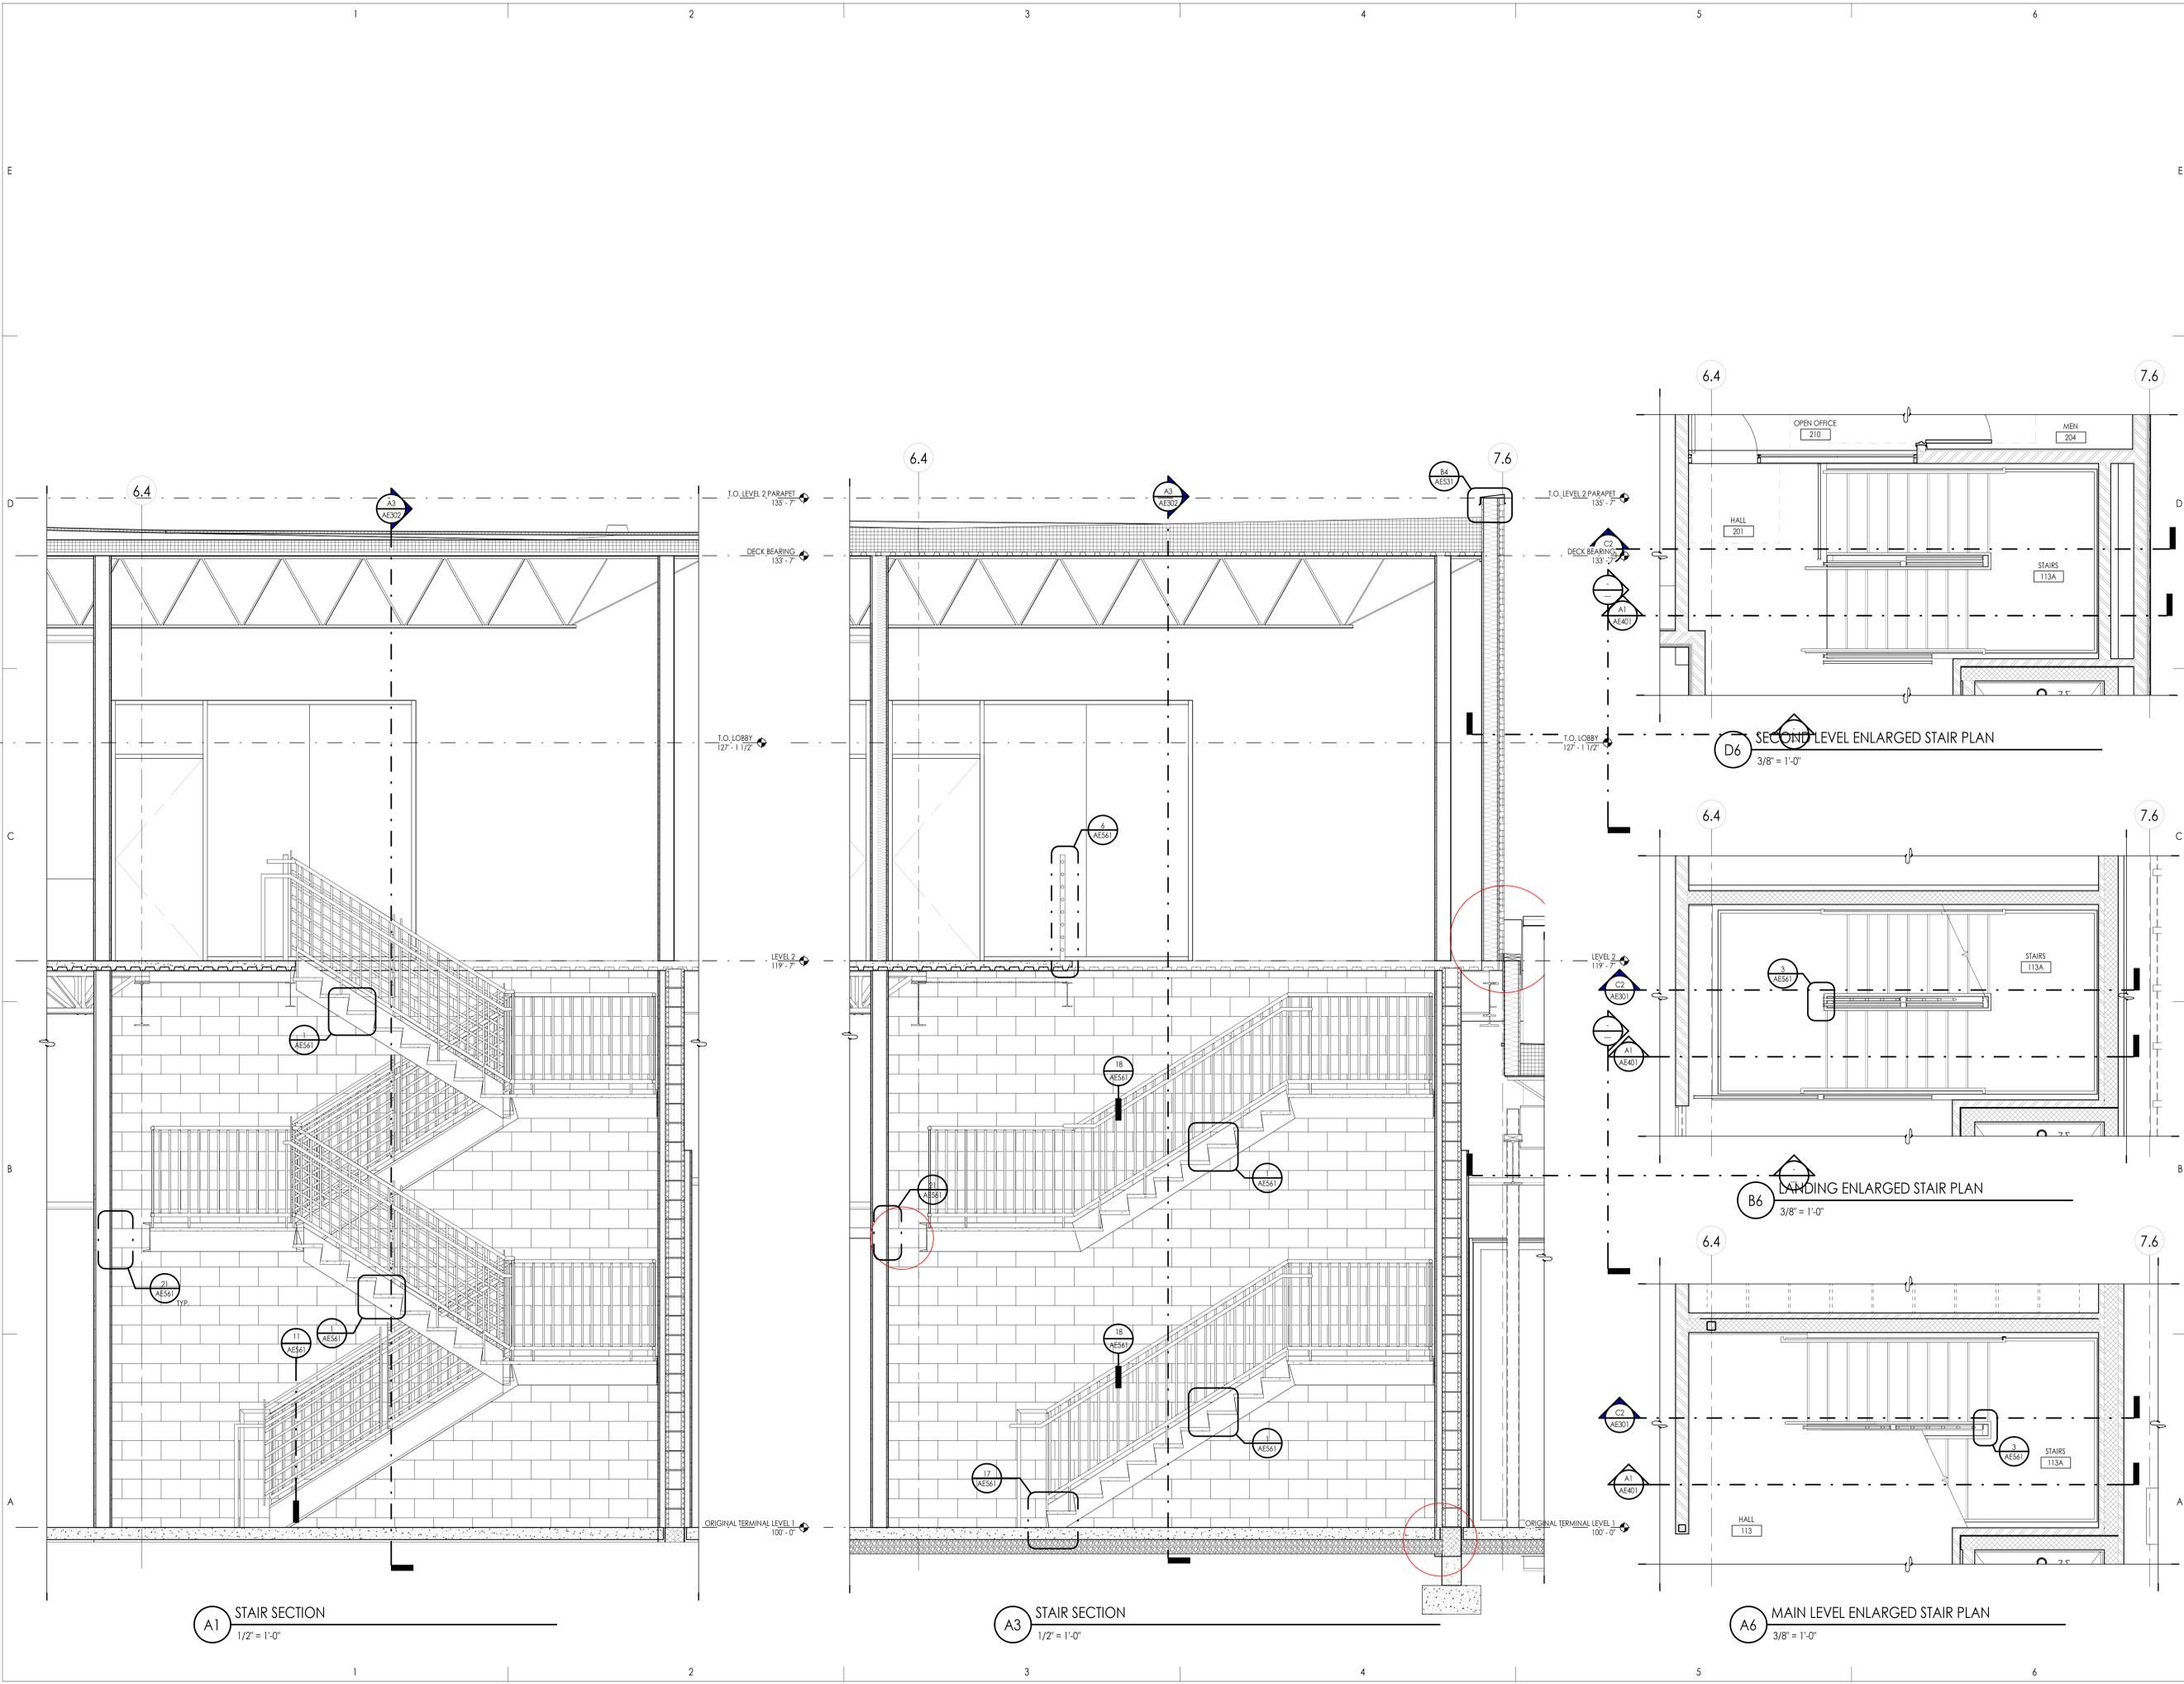

A1 STAIR SECTION
1/2" = 1'-0"

A3 STAIR SECTION
1/2" = 1'-0"

A6 MAIN LEVEL ENLARGED STAIR PLAN
3/8" = 1'-0"

D6 SECOND LEVEL ENLARGED STAIR PLAN
3/8" = 1'-0"

B6 LANDING ENLARGED STAIR PLAN
3/8" = 1'-0"

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TERMINAL EXPANSION
3909 AIRPORT ROAD
OGDEN, UT 84405

Project Name

Issued No.	Date	Description
1	11-15-2022	BID SET

Revision

No.	Date	Description
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SAA Project No. 2021-10
Drawing Title

STAIR PLANS & SECTIONS

Sheet Number
AE401



General Contractor
STACEY CONSTRUCTION
Stacey Construction
Construction Manager
General Contractor
3788 Pacific Ave.
Ogden, UT 84405
801.621.6210
www.staceyc.com

Consultant

OGDEN-HINCKLEY AIRPORT
TERMINAL EXPANSION
3909 AIRPORT ROAD
OGDEN, UT 84405


Project Name

Issued		
No.	Date	Description
1	11-15-2022	BID SET
Revision		
No.	Date	Description

SAA Project No. 2021-10
Drawing Title

STAIR PLANS & SECTIONS

Sheet Number
AE402

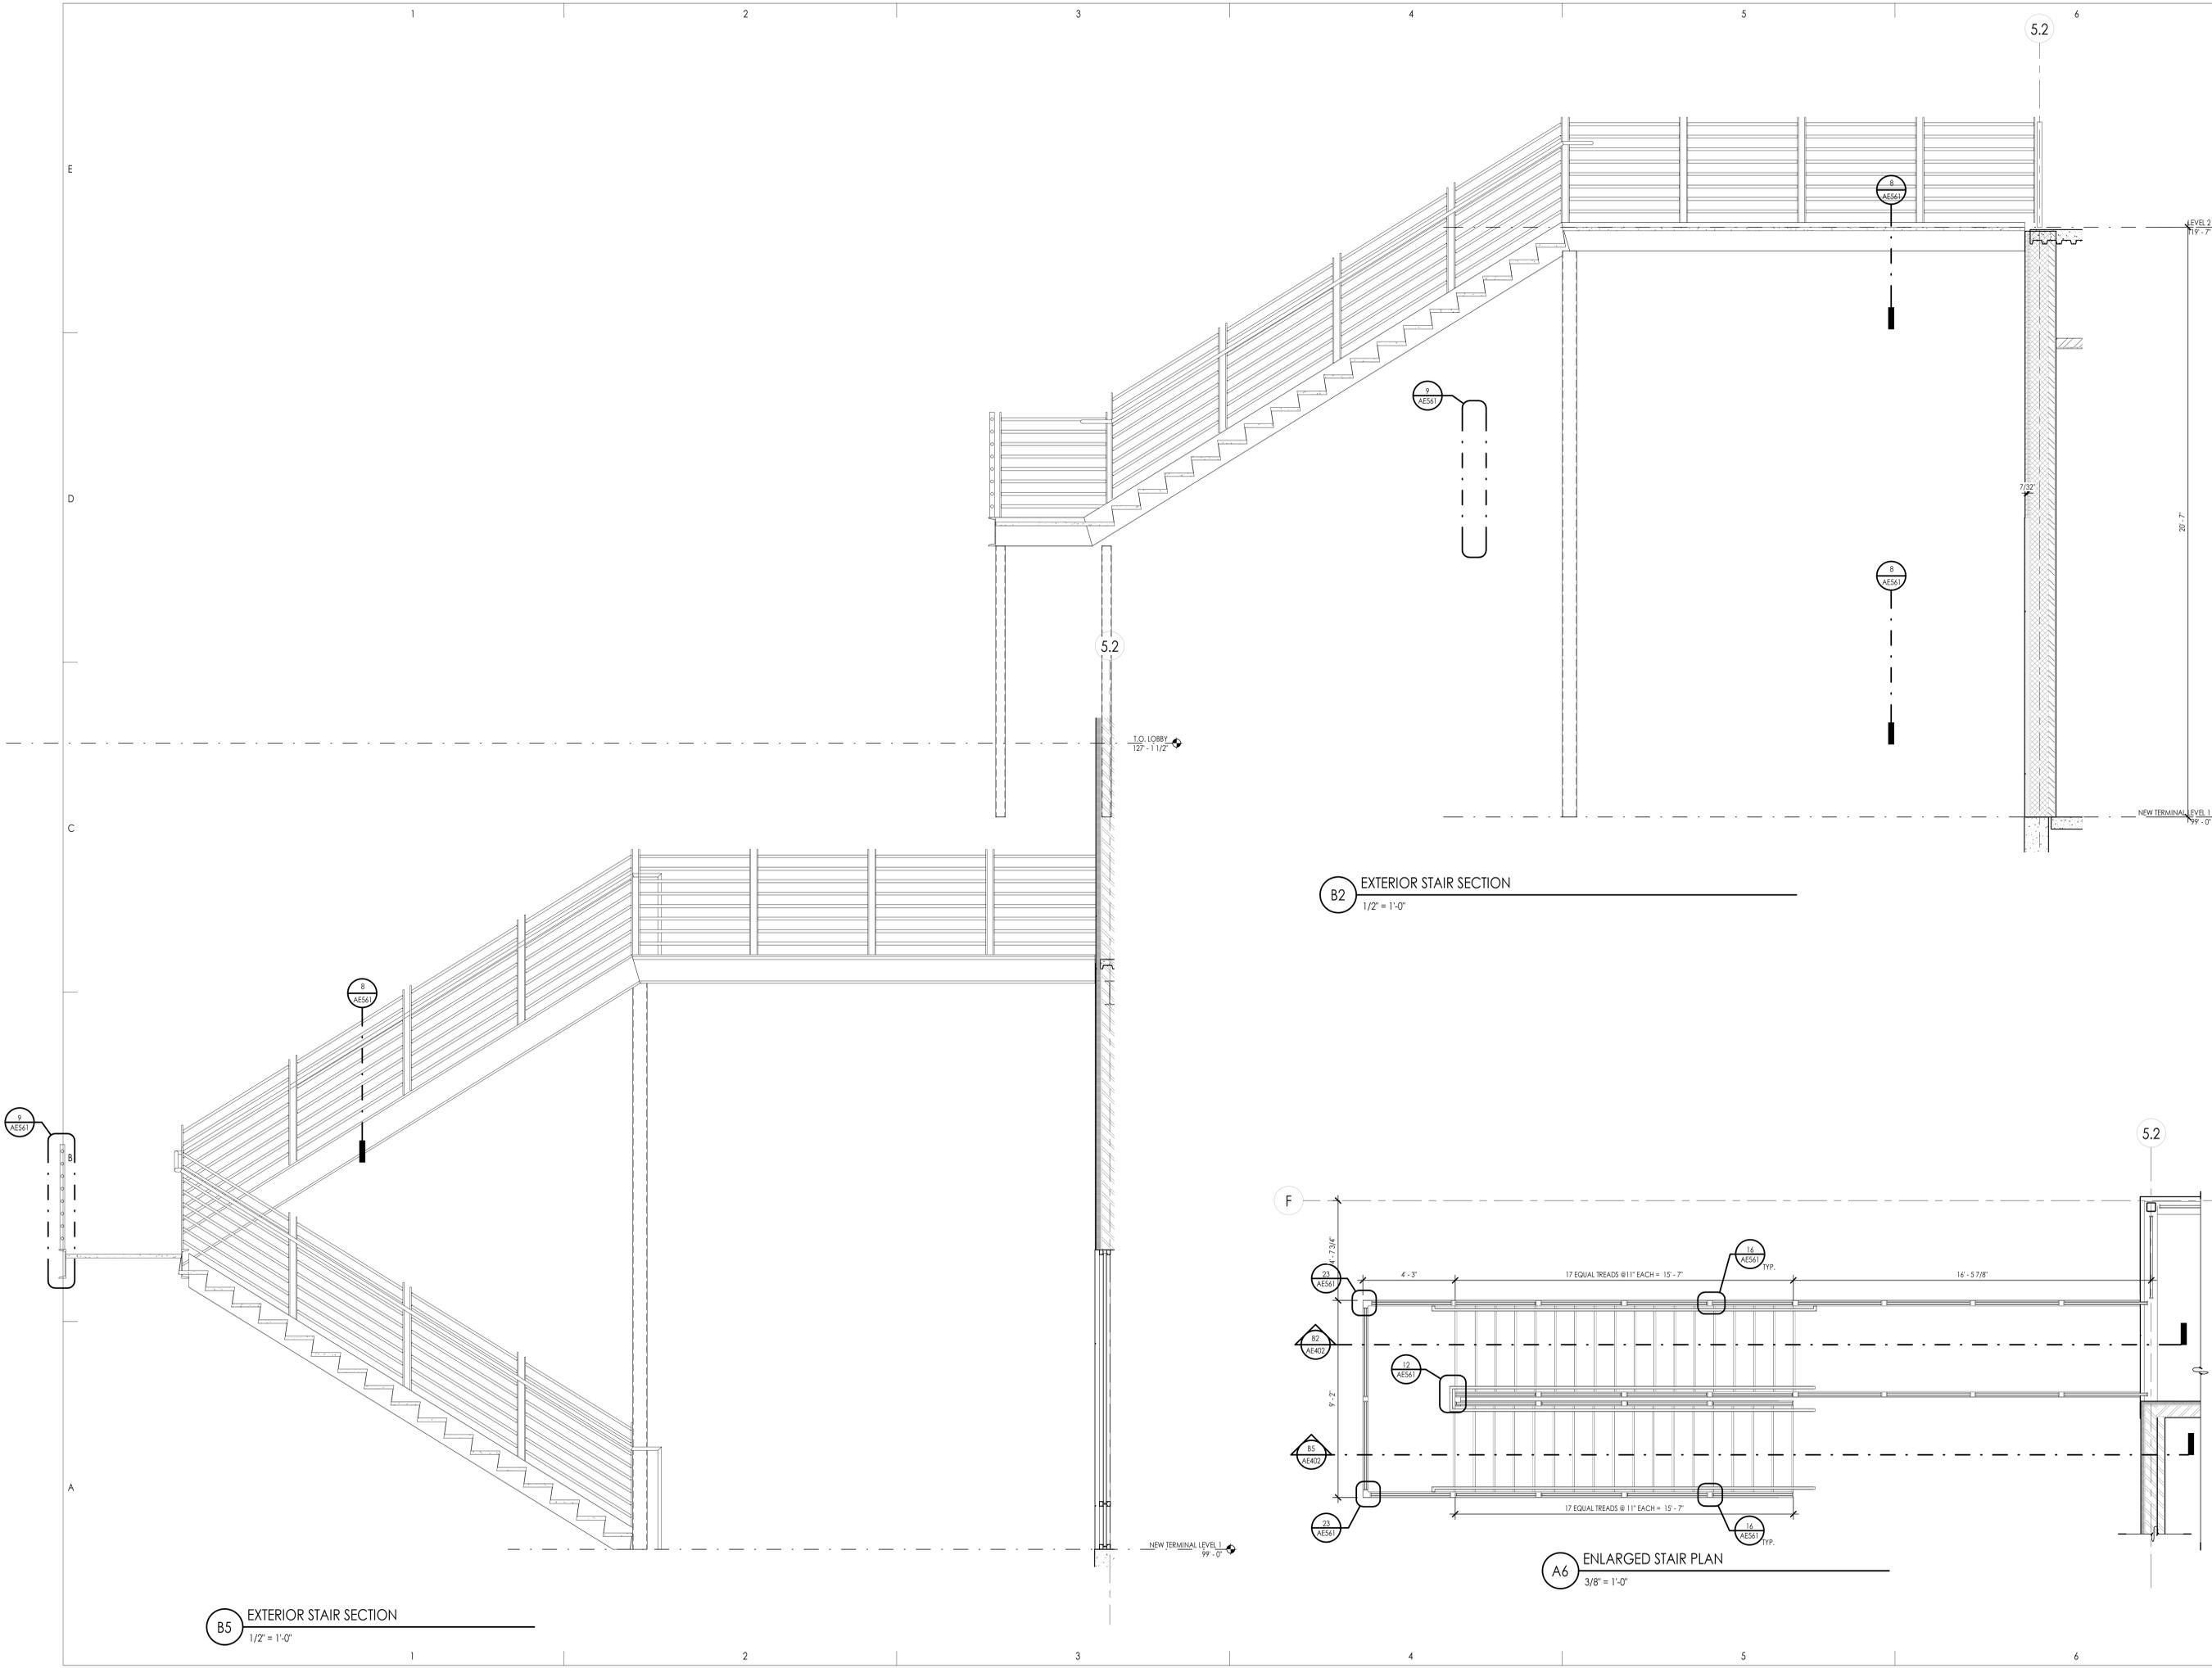

B5 EXTERIOR STAIR SECTION
1/2" = 1'-0"

B2 EXTERIOR STAIR SECTION
1/2" = 1'-0"

A6 ENLARGED STAIR PLAN
3/8" = 1'-0"

Sheet Number



General Contractor



STACEY
CONSTRUCTION

Stacey Construction
Construction Manager
General Contractor
3788 Pacific Ave.
Ogden, UT 84405
801.621.6210
www.staceyc.com

Consultant

Project Name
OGDEN-HINCKLEY AIRPORT
TERMINAL EXPANSION
3909 AIRPORT ROAD
OGDEN, UT 84405

Issued

No.	Date	Description
1	11-15-2022	BID SET

Revision


No.	Date	Description

SAA Project No. 2021-10
Drawing Title

RAMP PLANS &
SECTIONS

Sheet Number

AE403

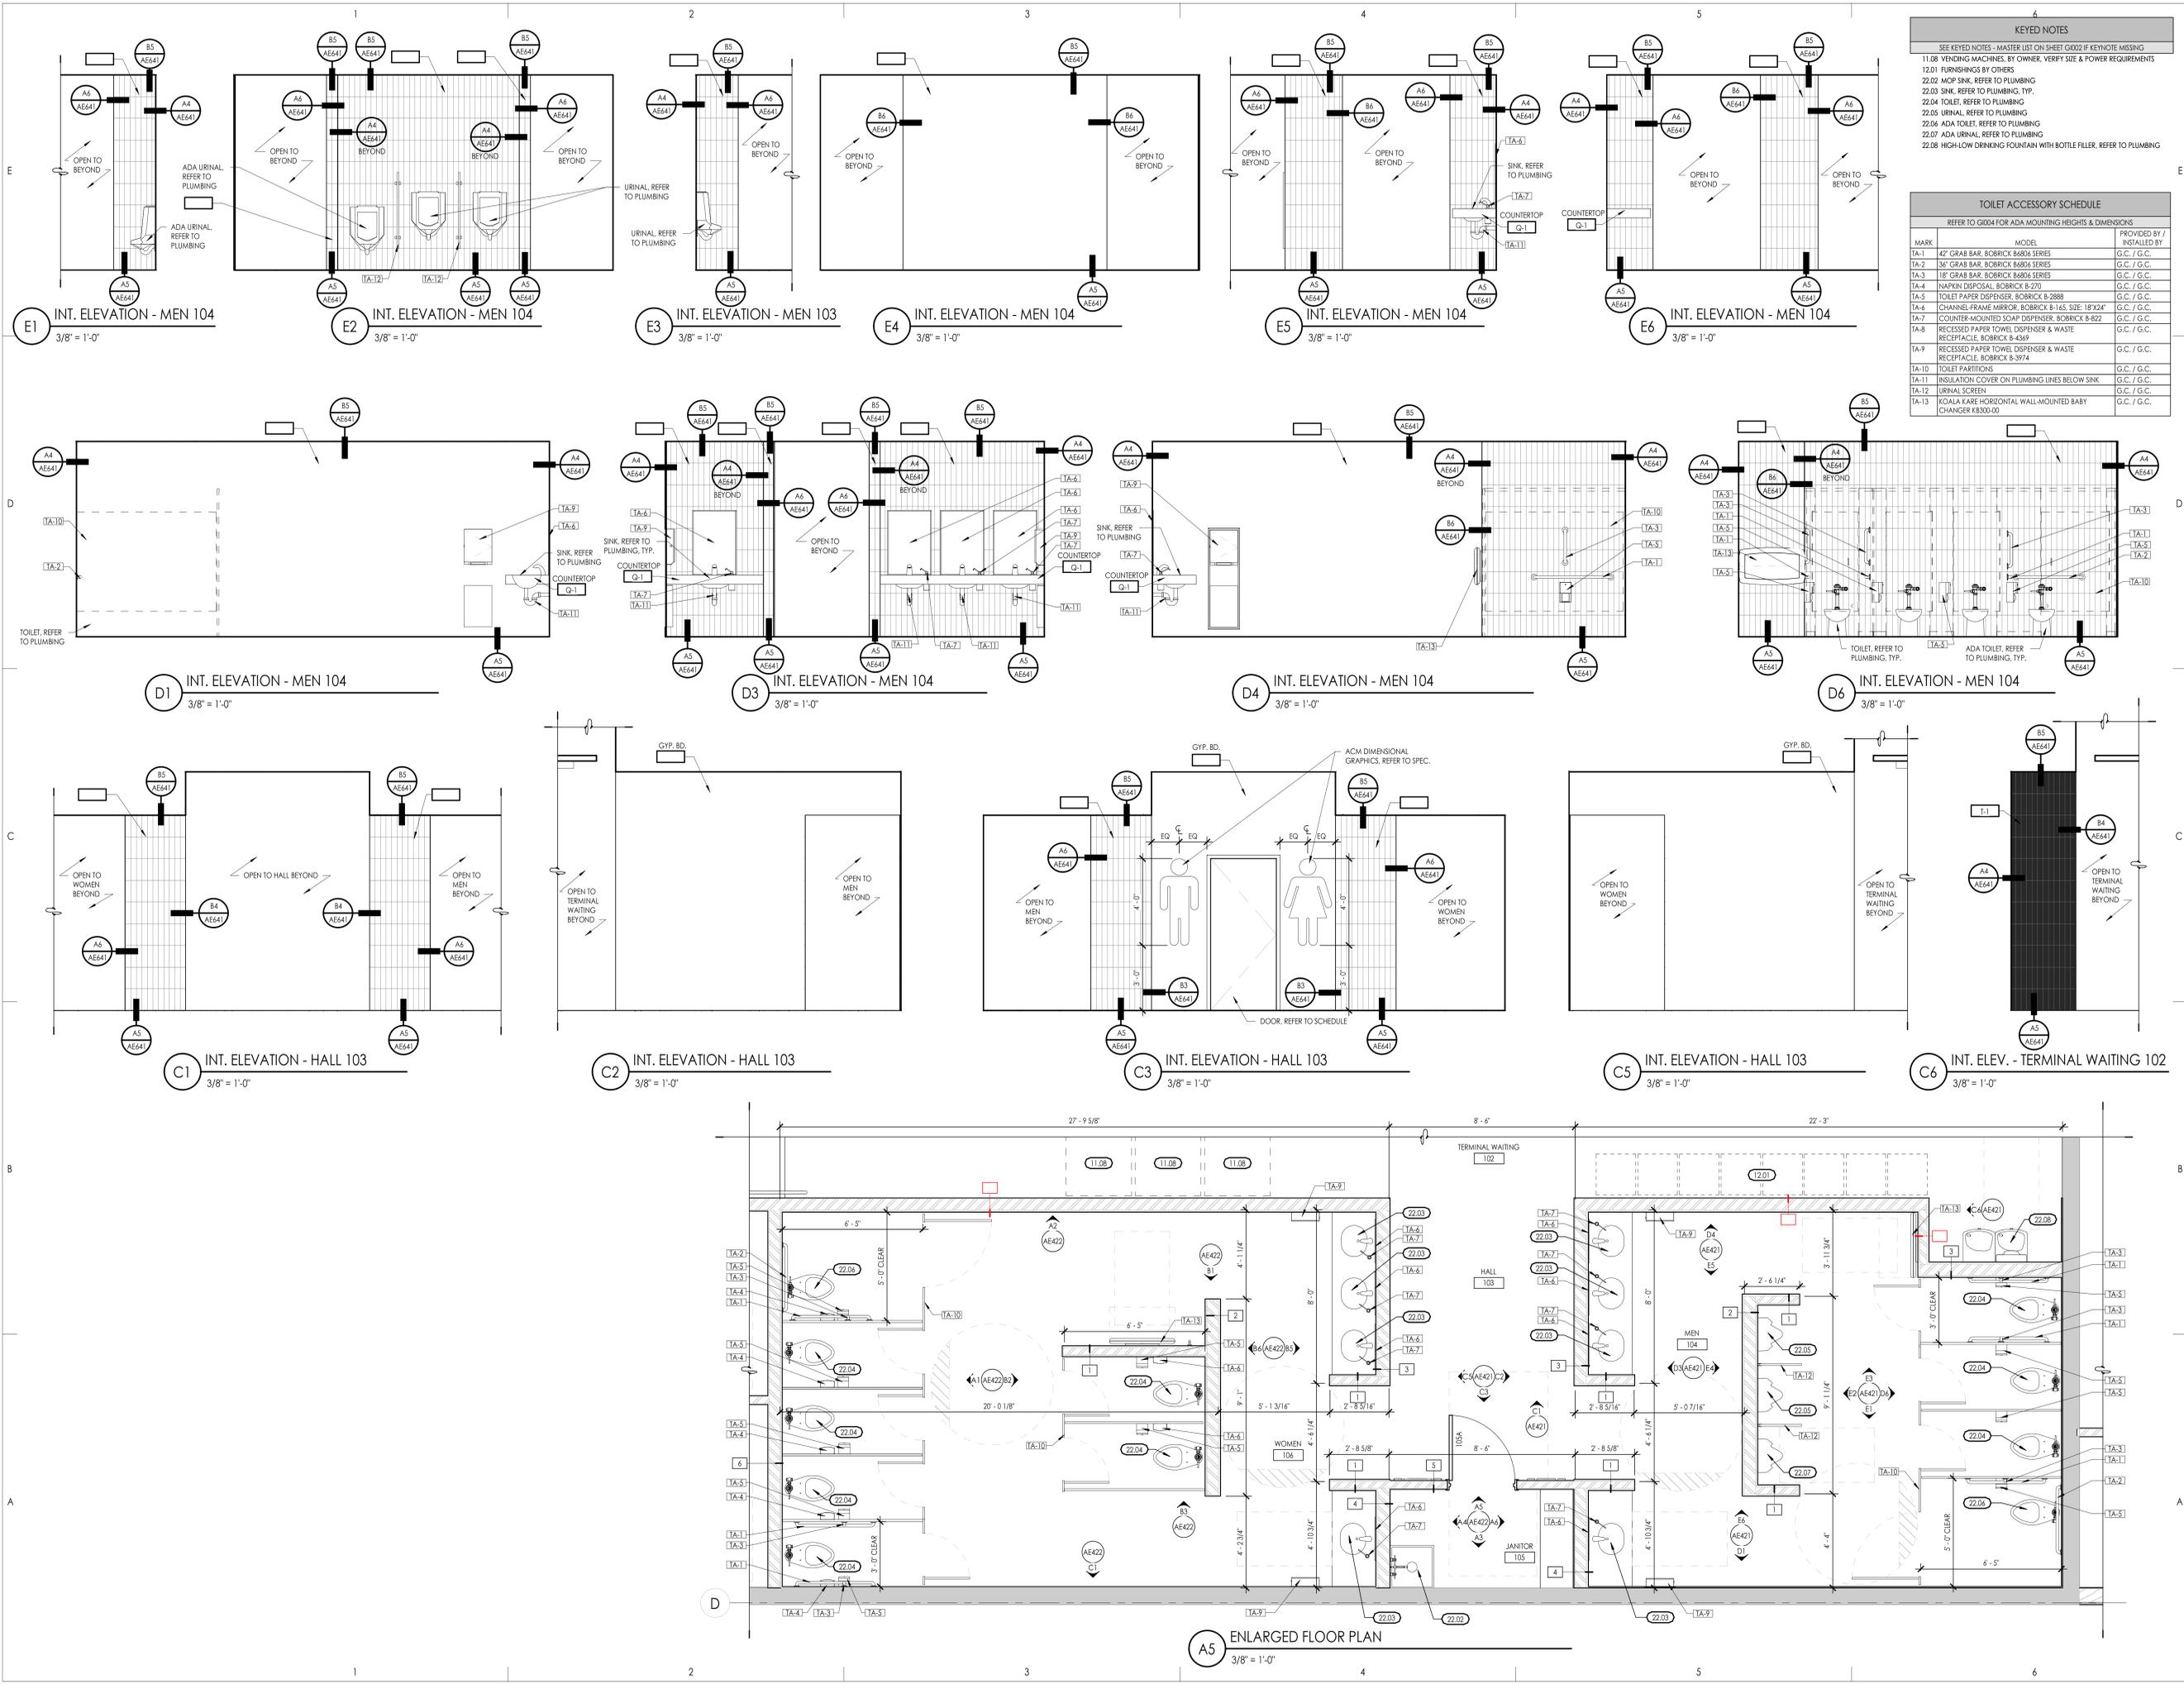

KEYED NOTES

SEE KEYED NOTES - MASTER LIST ON SHEET G002 IF KEYNOTE MISSING

11.08 VENDING MACHINES, BY OWNER, VERIFY SIZE & POWER REQUIREMENTS

12.01 FURNISHINGS BY OTHERS

22.02 WCP SINK, REFER TO PLUMBING

22.03 SINK, REFER TO PLUMBING, TYP.

22.04 TOILET, REFER TO PLUMBING

22.05 URINAL, REFER TO PLUMBING

22.06 ADA TOILET, REFER TO PLUMBING


22.07 ADA URINAL, REFER TO PLUMBING

22.08 HIGH-LOW DRINKING FOUNTAIN WITH BOTTLE FILLER, REFER TO PLUMBING

TOILET ACCESSORY SCHEDULE

REFER TO G004 FOR ADA MOUNTING HEIGHTS & DIMENSIONS

MARK	MODEL	PROVIDED BY / INSTALLED BY
TA-1	42" GRAB BAR, BOBRICK 86936 SERIES	G.C. / G.C.
TA-2	36" GRAB BAR, BOBRICK 86936 SERIES	G.C. / G.C.
TA-3	18" GRAB BAR, BOBRICK 86936 SERIES	G.C. / G.C.
TA-4	NAPKIN DISPOSAL, BOBRICK B-270	G.C. / G.C.
TA-5	TOILET PAPER DISPENSER, BOBRICK B-2888	G.C. / G.C.
TA-6	CHANNEL-FRAME MIRROR, BOBRICK B-165, SIZE: 18'X24"	G.C. / G.C.
TA-7	COUNTER-MOUNTED SOAP DISPENSER, BOBRICK B-822	G.C. / G.C.
TA-8	RECESSED PAPER TOWEL DISPENSER & WASTE RECEPTACLE, BOBRICK B-4369	G.C. / G.C.
TA-9	RECESSED PAPER TOWEL DISPENSER & WASTE RECEPTACLE, BOBRICK B-3974	G.C. / G.C.
TA-10	TOILET PARTITIONS	G.C. / G.C.
TA-11	INSULATION COVER ON PLUMBING LINES BELOW SINK	G.C. / G.C.
TA-12	URINAL SCREEN	G.C. / G.C.
TA-13	KOJALA KARE HORIZONTAL WALL-MOUNTED BABY CHANGER KB300-00	G.C. / G.C.

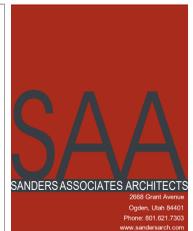

General Contractor

Stacey Construction
Construction Manager
General Contractor
376B Pacific Ave.
Ogden, UT 84405
801.621.6210
www.staceycg.com

Consultant

Project Name
OGDEN-HINCKLEY AIRPORT
TERMINAL EXPANSION
3909 AIRPORT ROAD
OGDEN, UT 84405

Project No. 2021-10

Issued

No.	Date	Description
1	11-15-2022	BID SET


Revision

No.	Date	Description

Drawing Title
ENLARGED FLOOR PLANS & INTERIOR ELEVATIONS

Sheet Number


AE421

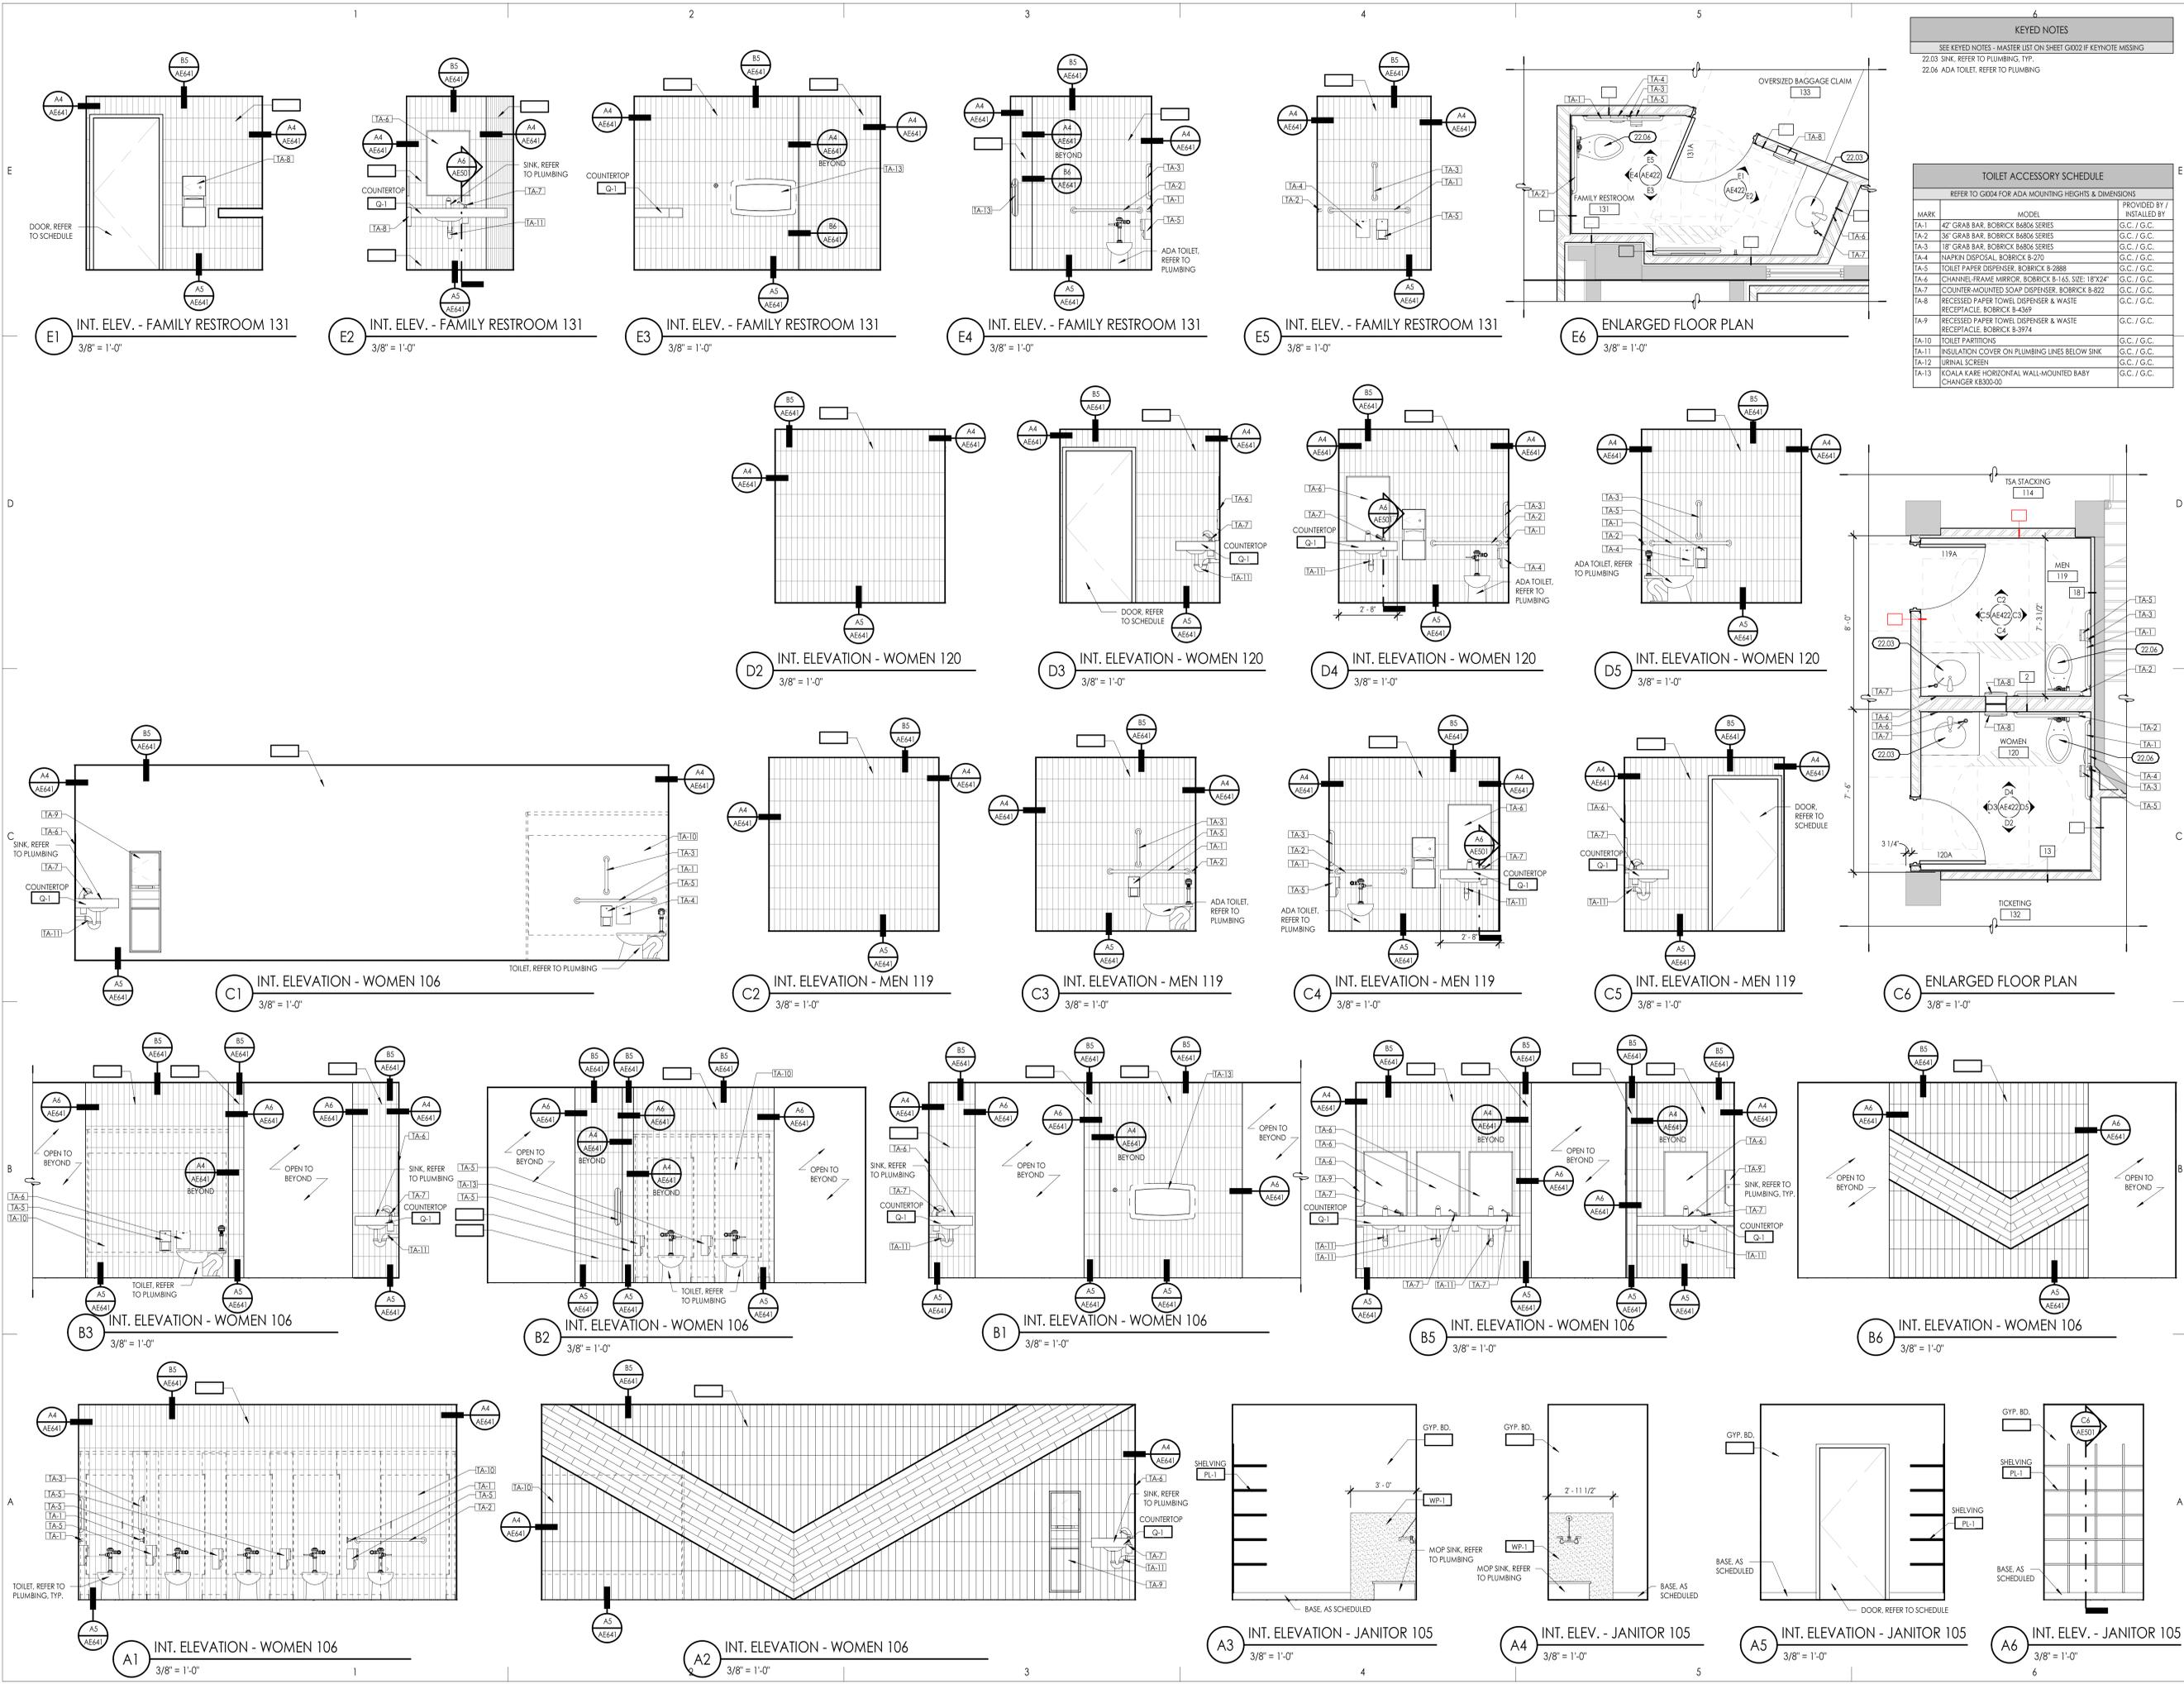

KEY NOTES
 SEE KEYED NOTES - MASTER LIST ON SHEET G002 IF KEYNOTE MISSING
 22.03 SINK, REFER TO PLUMBING, TYP.
 22.06 ADA TOILET, REFER TO PLUMBING

TOILET ACCESSORY SCHEDULE
 REFER TO G004 FOR ADA MOUNTING HEIGHTS & DIMENSIONS

MARK	MODEL	PROVIDED BY / INSTALLED BY
TA-1	47" GRAB BAR, BOBRICK 8480S SERIES	G.C. / G.C.
TA-2	36" GRAB BAR, BOBRICK 8480S SERIES	G.C. / G.C.
TA-3	18" GRAB BAR, BOBRICK 8480S SERIES	G.C. / G.C.
TA-4	NAPKIN DISPOSAL, BOBRICK B-270	G.C. / G.C.
TA-5	TOILET PAPER DISPENSER, BOBRICK B-2888	G.C. / G.C.
TA-6	CHANNEL FRAME MIRROR, BOBRICK B-1AS, SIZE: 18"X24"	G.C. / G.C.
TA-7	COUNTER MOUNTED SOAP DISPENSER, BOBRICK B-922	G.C. / G.C.
TA-8	RECESSED PAPER TOWEL DISPENSER & WASTE RECEPTACLE, BOBRICK B-4369	G.C. / G.C.
TA-9	RECESSED PAPER TOWEL DISPENSER & WASTE RECEPTACLE, BOBRICK B-3974	G.C. / G.C.
TA-10	TOILET PARTITIONS	G.C. / G.C.
TA-11	INSULATION COVER ON PLUMBING LINES BELOW SINK	G.C. / G.C.
TA-12	URINAL SCREEN	G.C. / G.C.
TA-13	KOALA KARE HORIZONTAL WALL-MOUNTED BABY CHANGER K3300-00	G.C. / G.C.

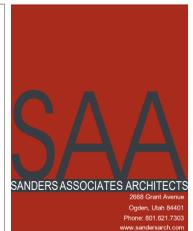

STACEY CONSTRUCTION
 Stacey Construction
 Construction Manager
 General Contractor
 376B Pacific Ave.
 Ogden, UT 84405
 BO11621162110
 www.staceycg.com

Consultant

OGDEN-HINCKLEY AIRPORT
 TERMINAL EXPANSION
 3909 AIRPORT ROAD
 OGDEN, UT 84405

Project Name

No.	Date	Description
1	11-15-2022	BID SET


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No.	Date	Description
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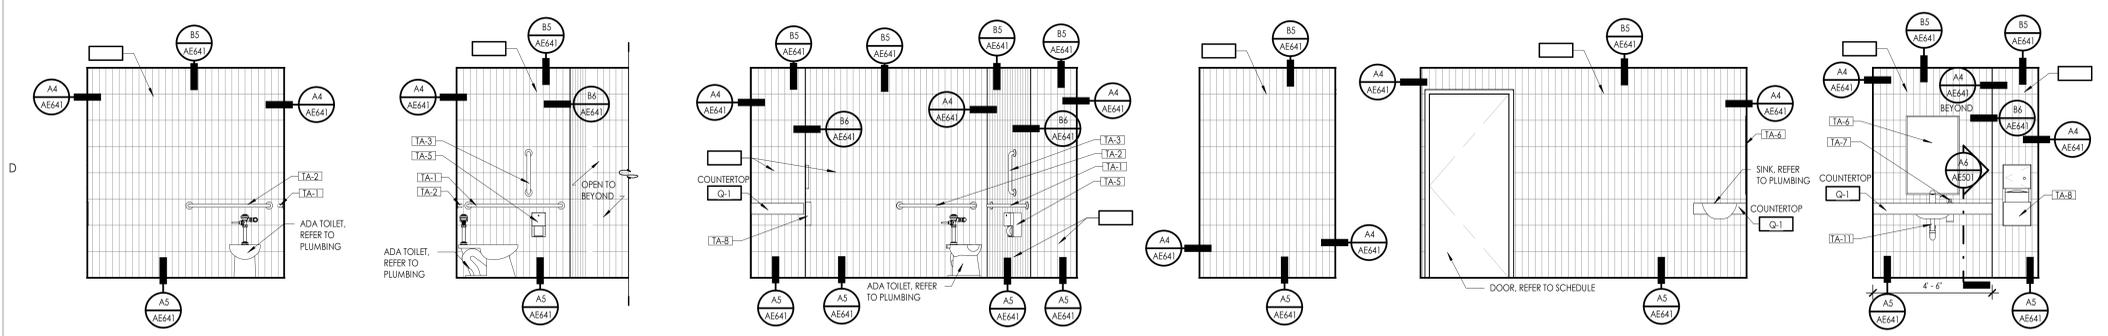
SAA Project No. 2021-10
 Drawing Title

ENLARGED FLOOR PLANS & INTERIOR ELEVATIONS


Sheet Number
AE422




E INT. ELEVATION - WOMEN B103 3/8" = 1'-0"
 E1 INT. ELEVATION - WOMEN B103 3/8" = 1'-0"
 E2 INT. ELEVATION - WOMEN B103 3/8" = 1'-0"
 E3 INT. ELEVATION - WOMEN B103 3/8" = 1'-0"
 E4 INT. ELEVATION - WOMEN B103 3/8" = 1'-0"
 E5 INT. ELEVATION - WOMEN B103 3/8" = 1'-0"

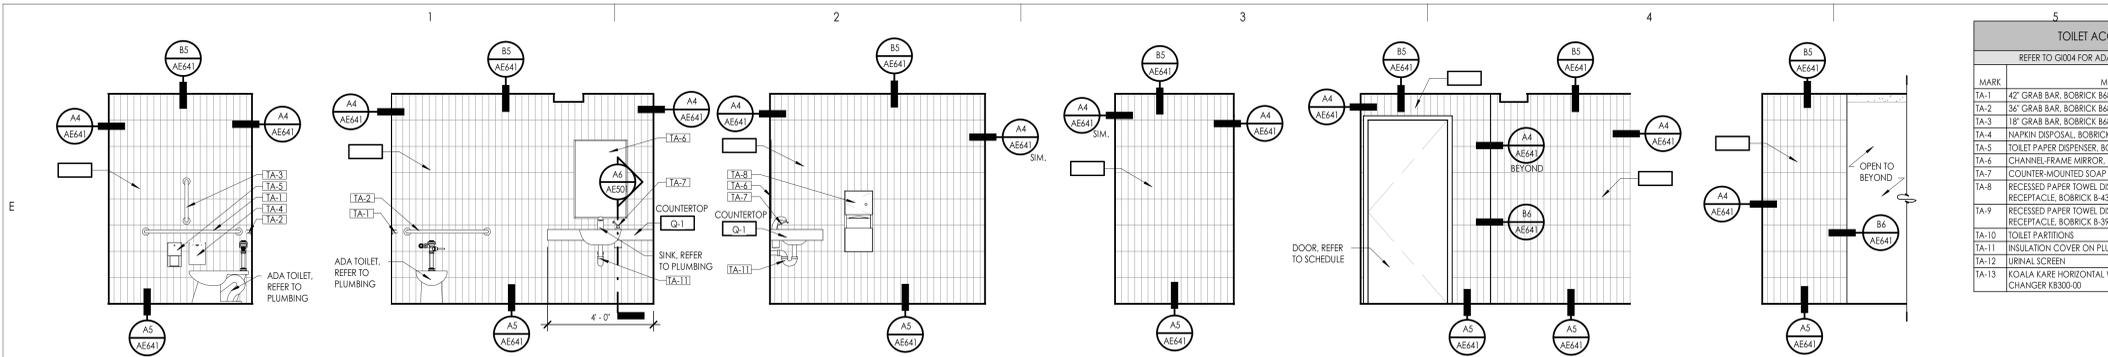


D INT. ELEVATION - MEN B102 3/8" = 1'-0"
 D1 INT. ELEVATION - MEN B102 3/8" = 1'-0"
 D2 INT. ELEVATION - MEN B102 3/8" = 1'-0"
 D3 INT. ELEVATION - MEN B102 3/8" = 1'-0"
 D4 INT. ELEVATION - MEN B102 3/8" = 1'-0"
 D5 INT. ELEVATION - MEN B102 3/8" = 1'-0"

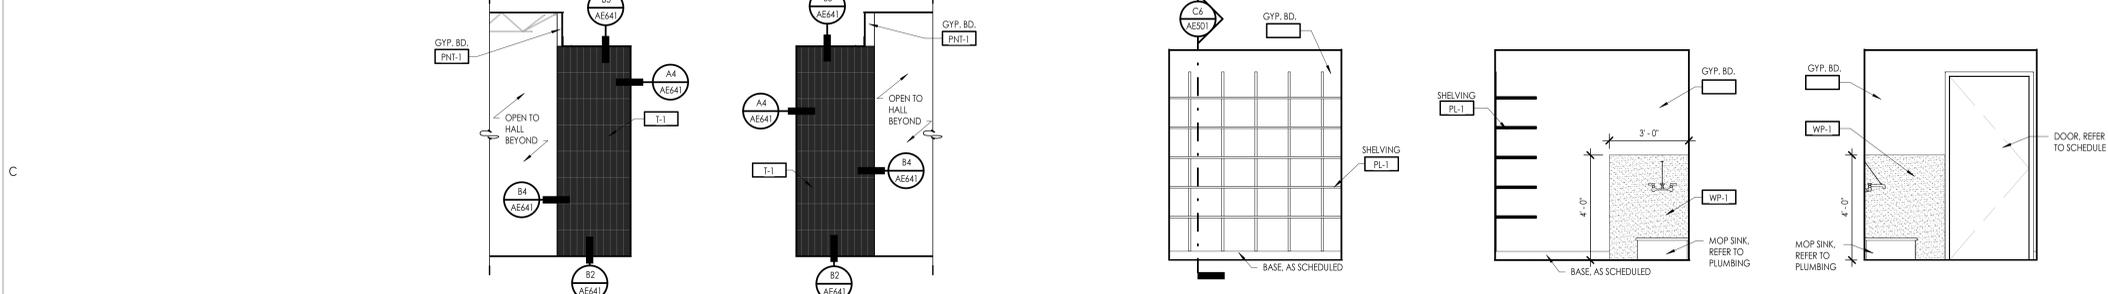

C1 INT. ELEVATION - HALL B101 3/8" = 1'-0"
 C2 INT. ELEVATION - HALL B101 3/8" = 1'-0"
 C3 INT. ELEV. - JANITOR/STORAGE 207 3/8" = 1'-0"
 C4 INT. ELEV. - JANITOR/STORAGE 207 3/8" = 1'-0"
 C5 INT. ELEV. - JANITOR/STORAGE 207 3/8" = 1'-0"

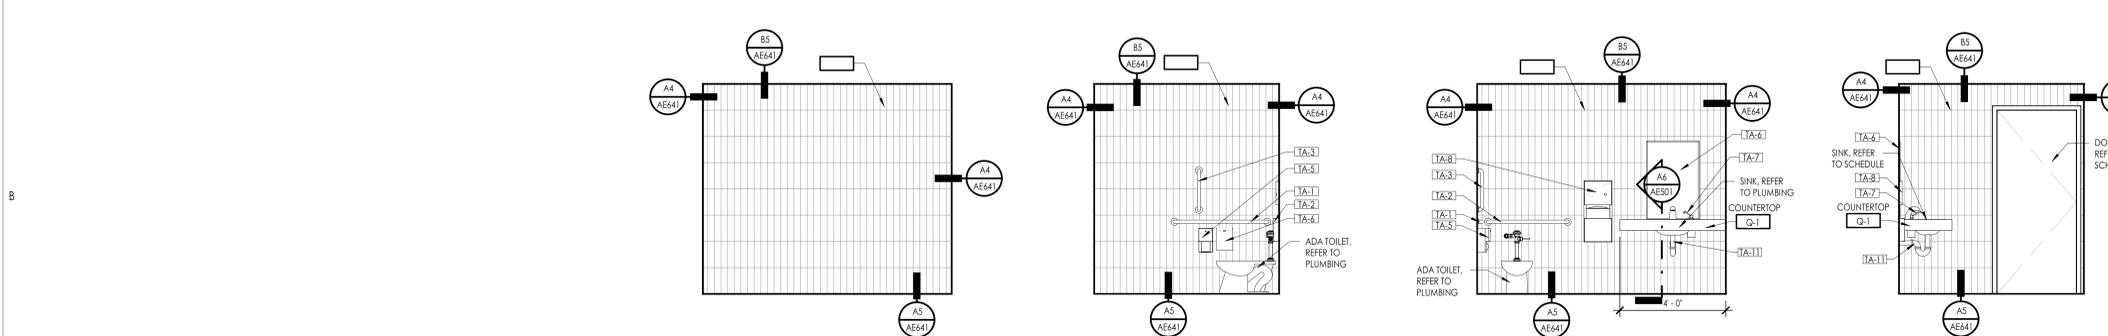


B2 INT. ELEVATION - WOMEN 205 3/8" = 1'-0"
 B3 INT. ELEVATION - WOMEN 205 3/8" = 1'-0"
 B4 INT. ELEVATION - WOMEN 205 3/8" = 1'-0"
 B5 INT. ELEVATION - WOMEN 205 3/8" = 1'-0"

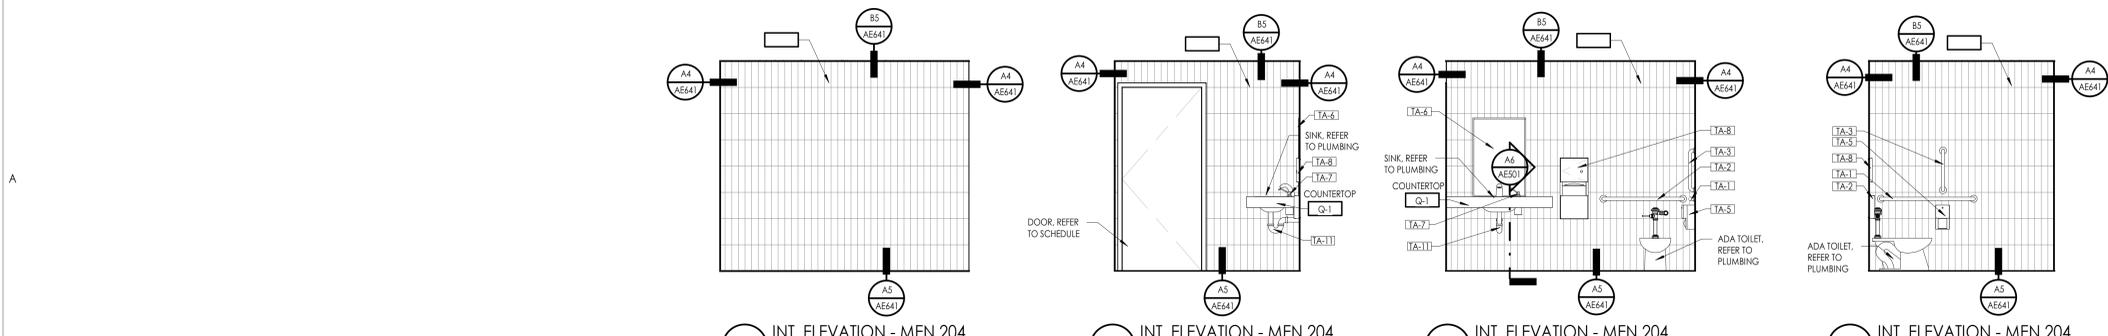


A2 INT. ELEVATION - MEN 204 3/8" = 1'-0"
 A3 INT. ELEVATION - MEN 204 3/8" = 1'-0"
 A4 INT. ELEVATION - MEN 204 3/8" = 1'-0"
 A5 INT. ELEVATION - MEN 204 3/8" = 1'-0"


TOILET ACCESSORY SCHEDULE		KEYNOTE NOTES	
REFER TO G1004 FOR ADA MOUNTING HEIGHTS & DIMENSIONS			
MARK	MODEL	PROVIDED BY /	INSTALLER
TA-1	42" GRAB BAR, BOBRICK B4804 SERIES	G.C. / G.C.	
TA-2	36" GRAB BAR, BOBRICK B4804 SERIES	G.C. / G.C.	
TA-3	18" GRAB BAR, BOBRICK B4804 SERIES	G.C. / G.C.	
TA-4	NAPKIN DISPOSAL, BOBRICK B-270	G.C. / G.C.	
TA-5	TOILET PAPER DISPENSER, BOBRICK B-2888	G.C. / G.C.	
TA-6	CHANNEL FRAME MIRROR, BOBRICK B-165, SIZE: 18"X24"	G.C. / G.C.	
TA-7	COUNTER-MOUNTED SOAP DISPENSER, BOBRICK B-422	G.C. / G.C.	
TA-8	RECESSED PAPER TOWEL DISPENSER & WASTE RECEPTACLE, BOBRICK B-4349	G.C. / G.C.	
TA-9	RECESSED PAPER TOWEL DISPENSER & WASTE RECEPTACLE, BOBRICK B-3974	G.C. / G.C.	
TA-10	TOILET PARTITIONS	G.C. / G.C.	
TA-11	INSULATION COVER ON PLUMBING LINES BELOW SINK	G.C. / G.C.	
TA-12	URNAL SCREEN	G.C. / G.C.	
TA-13	KOALA CARE HORIZONTAL WALL-MOUNTED BABY CHANGER KB3003D	G.C. / G.C.	

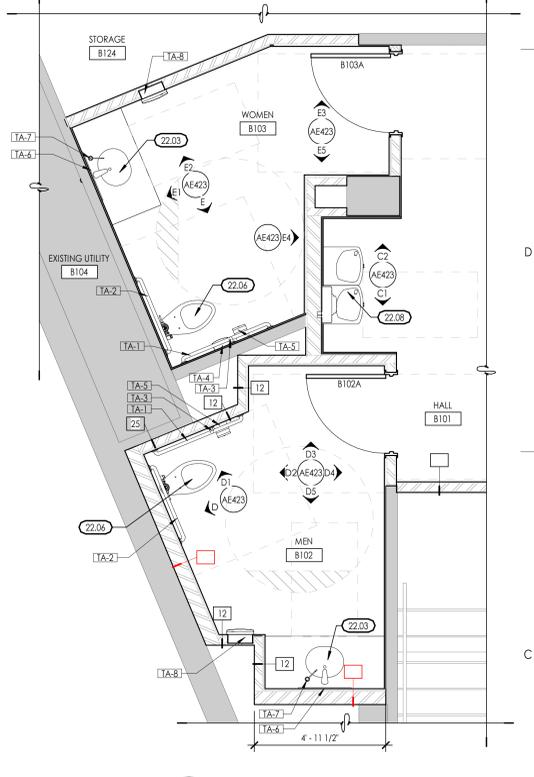

C6 ENLARGED FLOOR PLAN 3/8" = 1'-0"

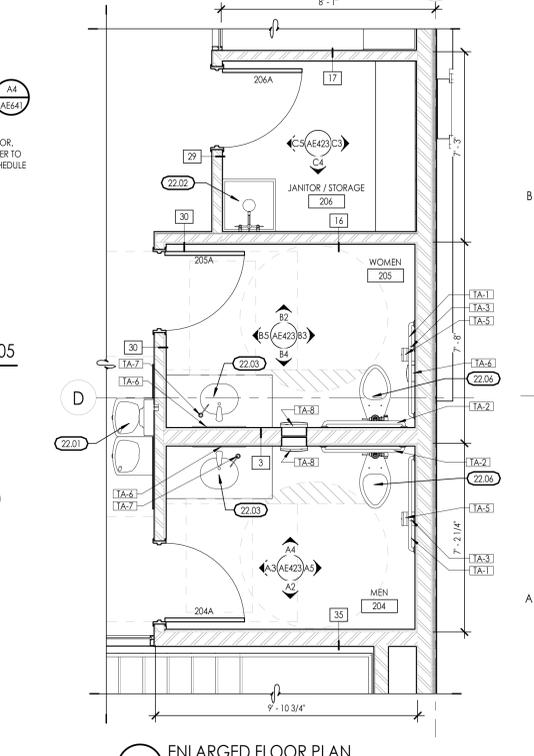

A6 ENLARGED FLOOR PLAN 3/8" = 1'-0"

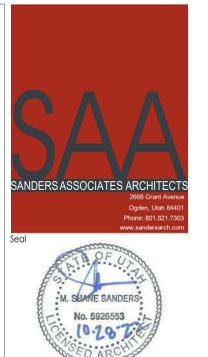


General Contractor
STACEY CONSTRUCTION
 Stacey Construction
 Construction Manager
 General Contractor
 378B Pacific Ave.
 Ogden, UT 84405
 801.621.6210
 www.staceycg.com
 Consultant

Project Name
OGDEN-HINCKLEY AIRPORT
 TERMINAL EXPANSION
 3909 AIRPORT ROAD
 OGDEN, UT 84405

No.	Date	Description
1	11-15-2022	BID SET

SAA Project No. 2021-10
 Drawing Title
ENLARGED FLOOR PLANS & INTERIOR ELEVATIONS
 Sheet Number

AE423

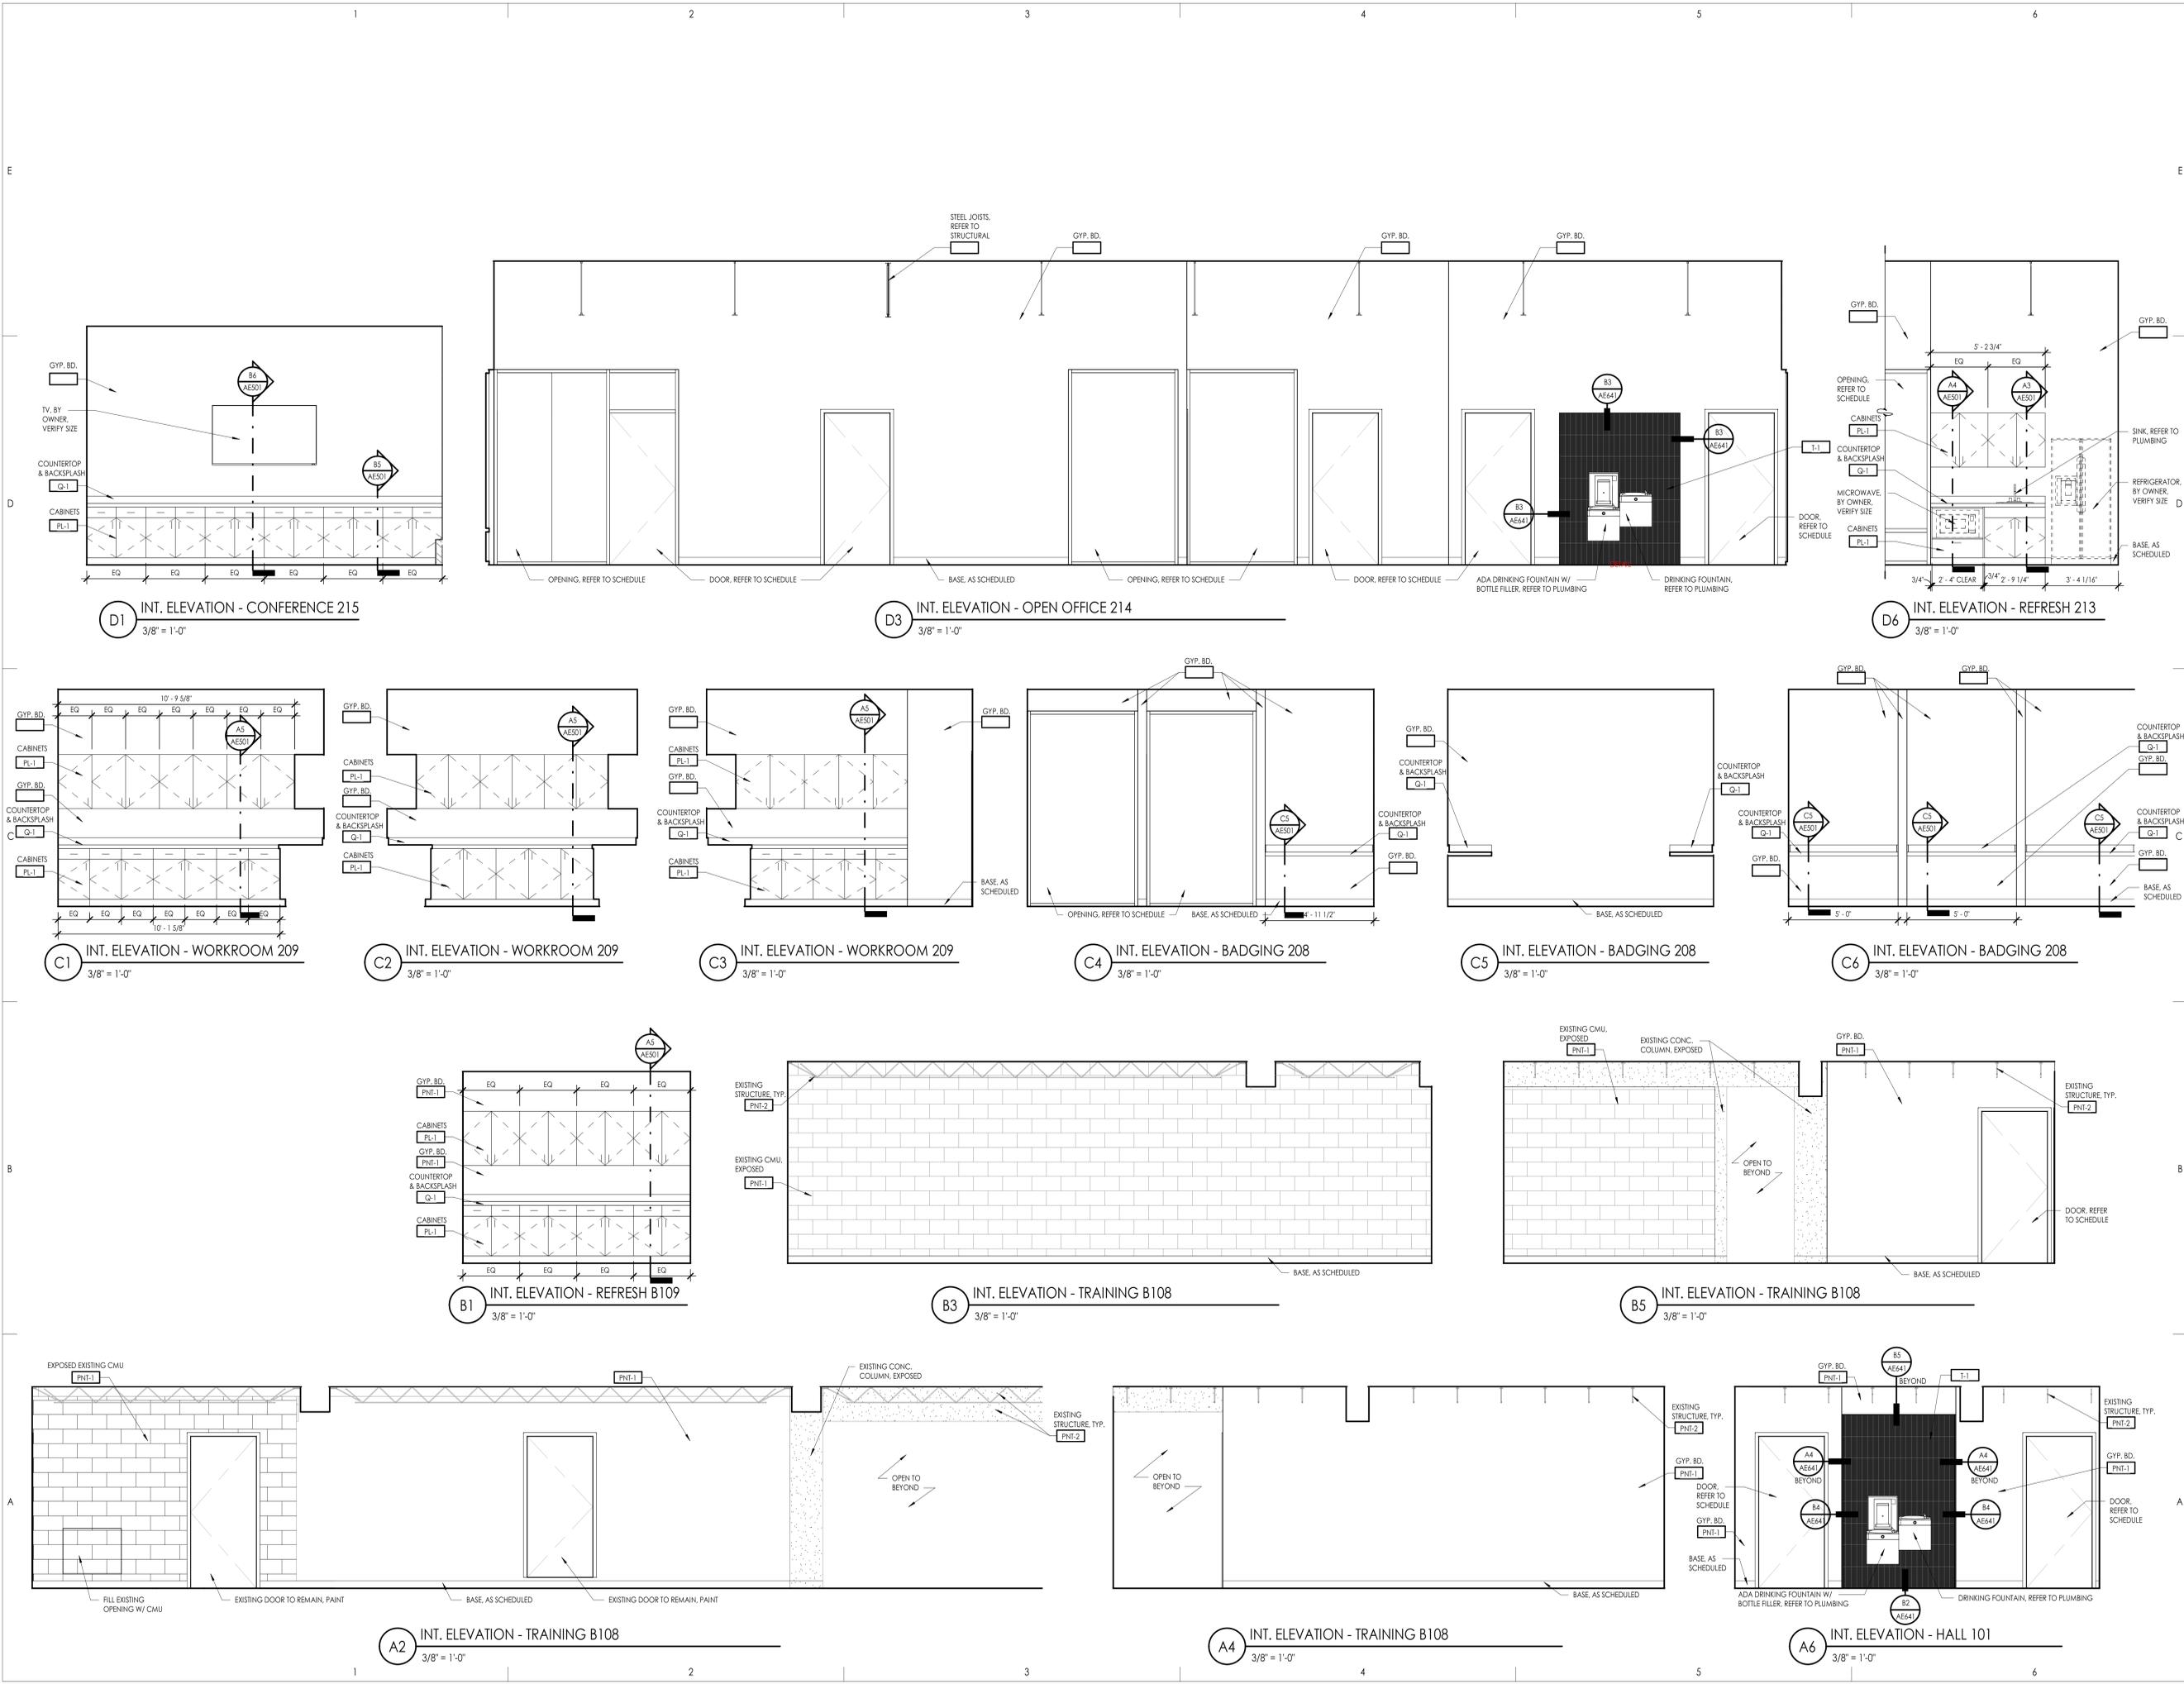

OGDEN-HINCKLEY AIRPORT
TERMINAL EXPANSION
3909 AIRPORT ROAD
OGDEN, UT 84405

Project Name

Issued No.	Date	Description
1	11-15-2022	BID SET

Revision

No.	Date	Description

SAA Project No. 2021-10
Drawing Title

INTERIOR ELEVATIONS - BASEMENT & LEVEL 2

Sheet Number

AE441



General Contractor

STACEY
 CONSTRUCTION
 Stacey Construction
 Construction Manager
 General Contractor
 3788 Pacific Ave.
 Ogden, UT 84405
 801.821.8210
 www.staceygc.com

Consultant

OGDEN-HINCKLEY AIRPORT
 TERMINAL EXPANSION
 3909 AIRPORT ROAD
 OGDEN, UT 84405

Project Name

Issued No.	Date	Description
1	11-15-2022	BID SET

Revision



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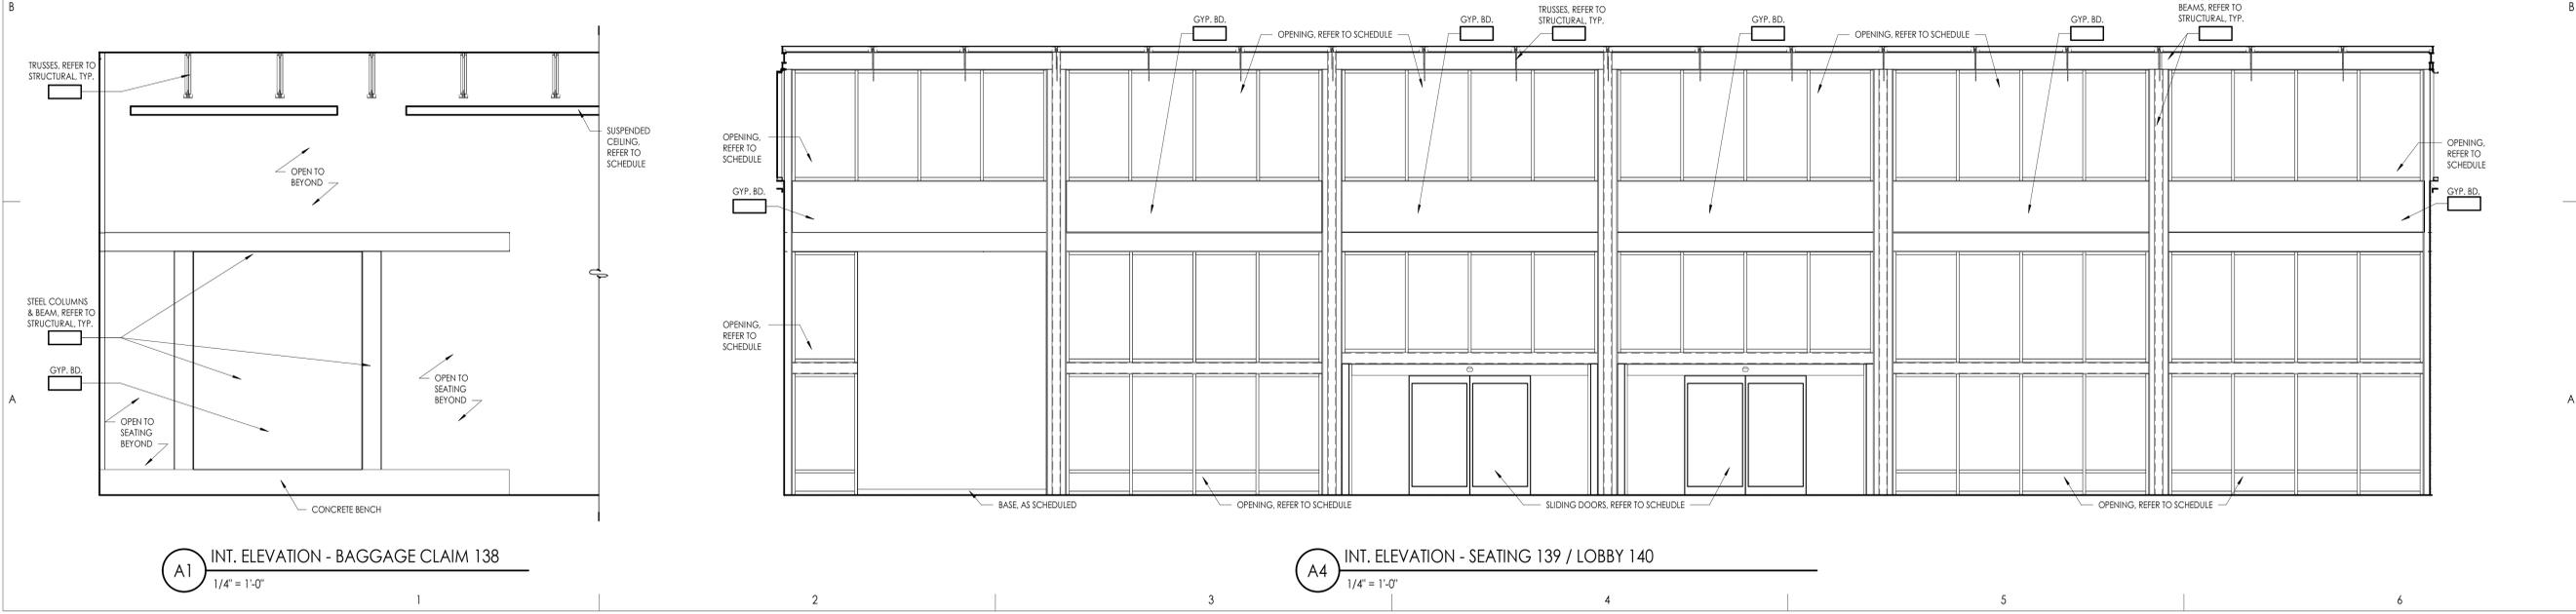
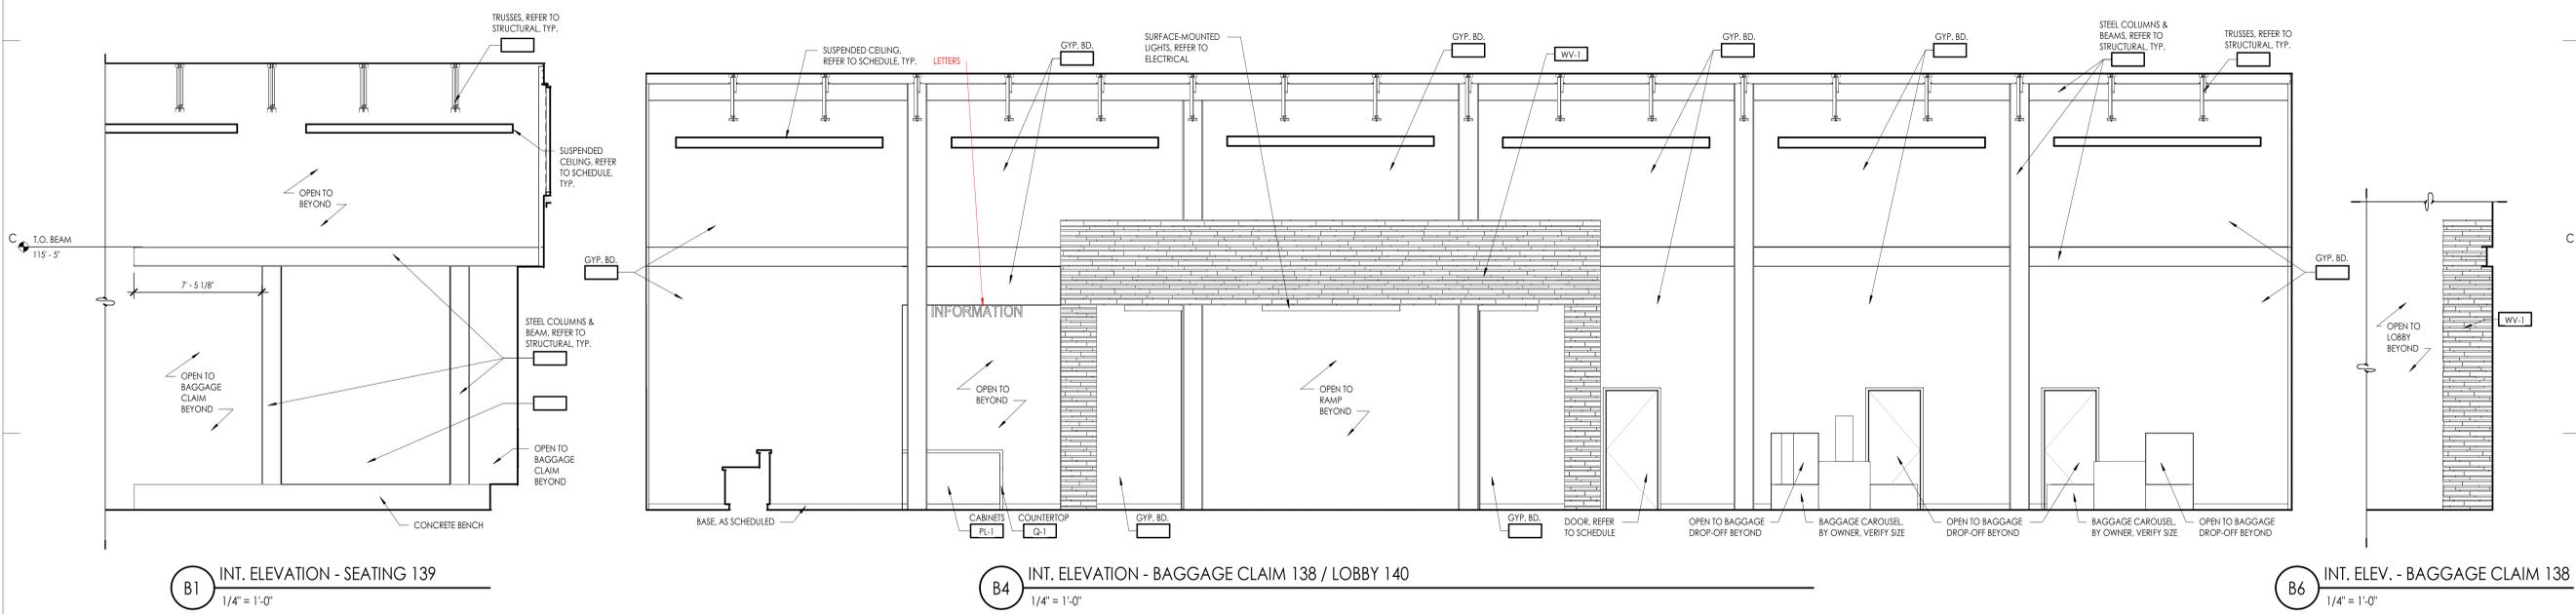
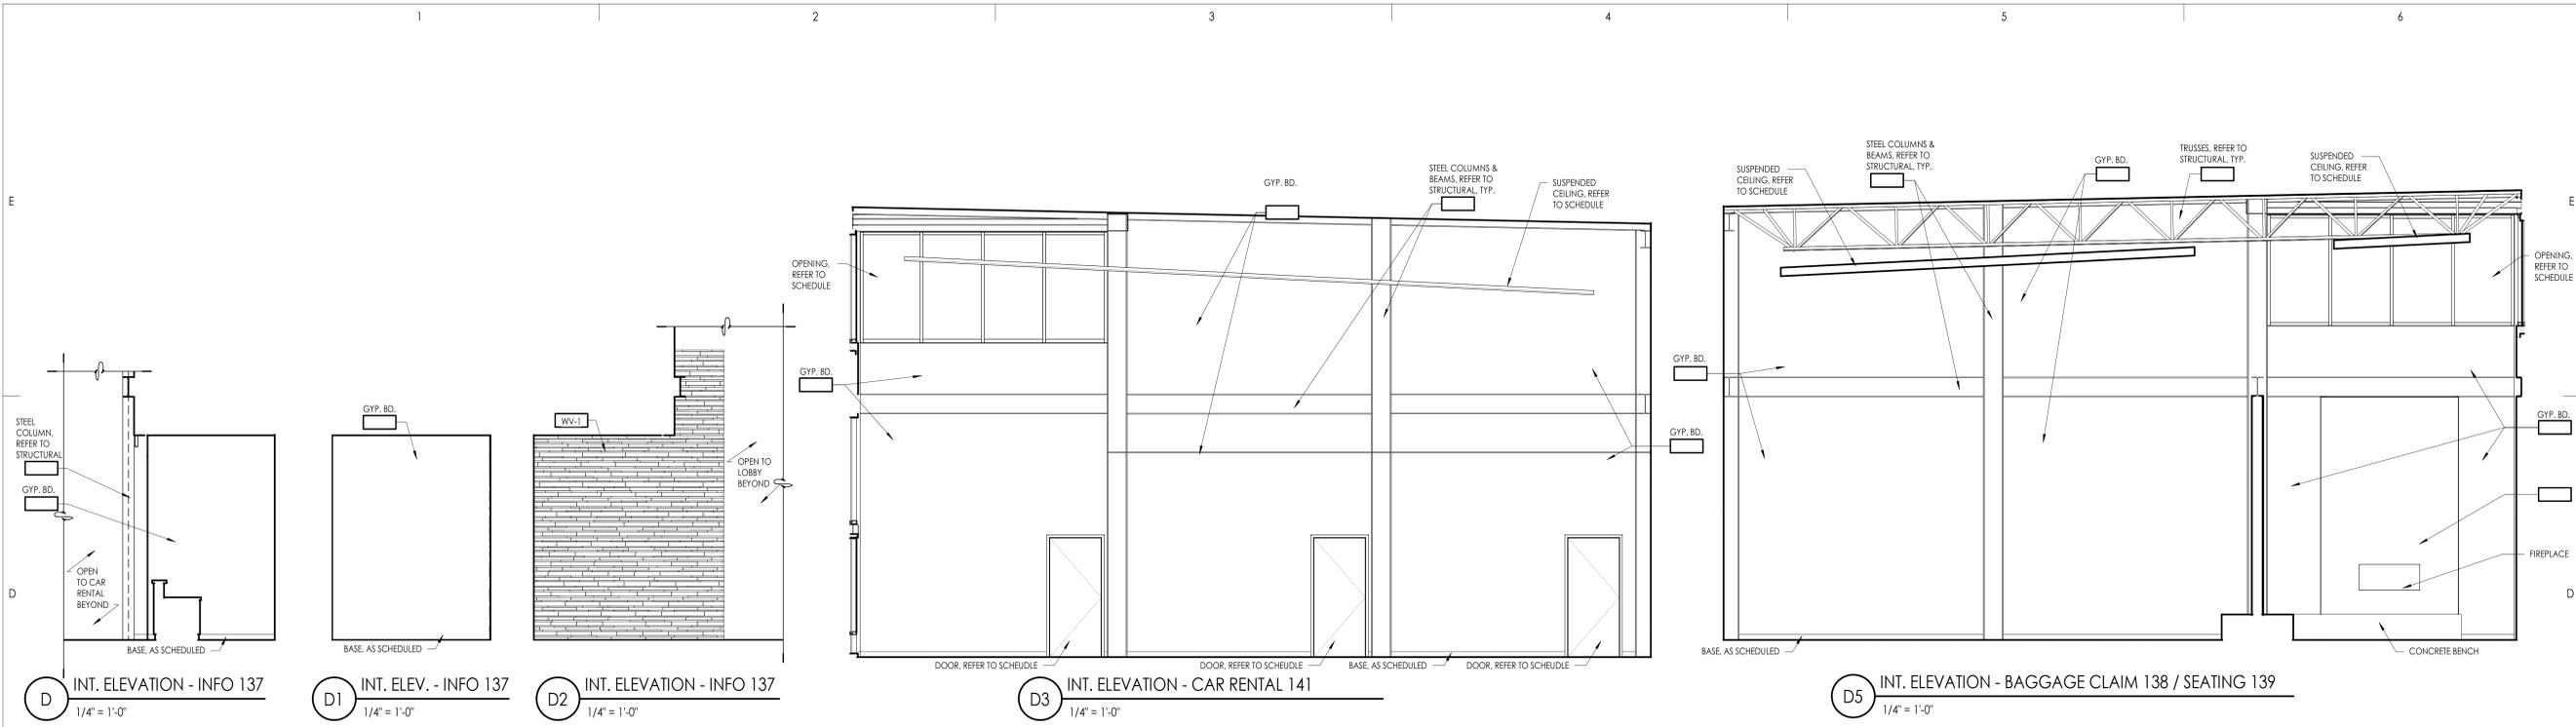
SAA Project No. 2021-10
 Drawing Title

INTERIOR ELEVATIONS - AREA B

Sheet Number

AE444



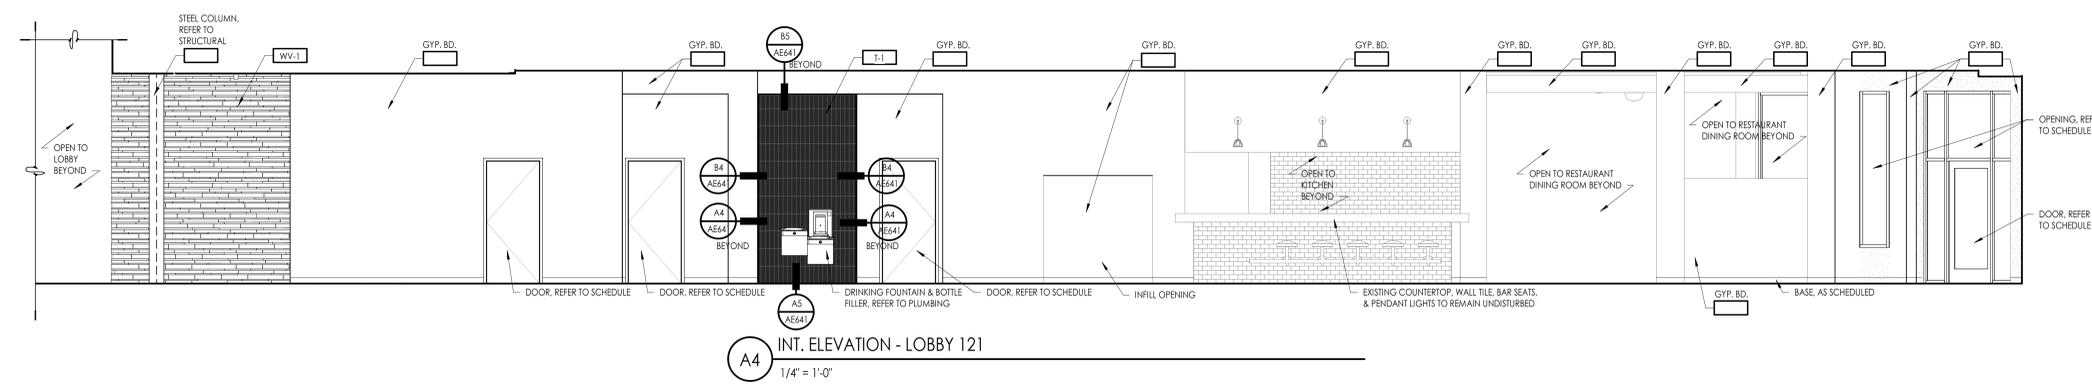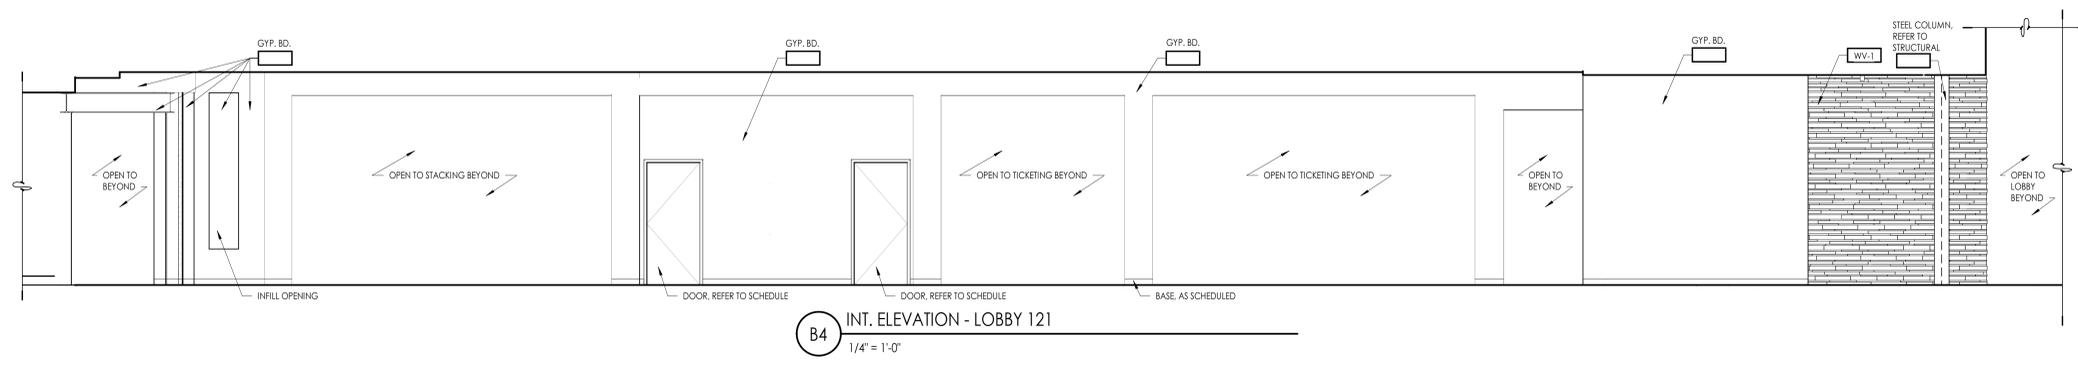

OGDEN-HINCKLEY AIRPORT
TERMINAL EXPANSION
3909 AIRPORT ROAD
OGDEN, UT 84405

Project Name


Issued		
No.	Date	Description
1	11-15-2022	BID SET

Revision		
No.	Date	Description

SAA Project No. 2021-10
Drawing Title

INTERIOR ELEVATIONS - AREA C

Sheet Number
AE445

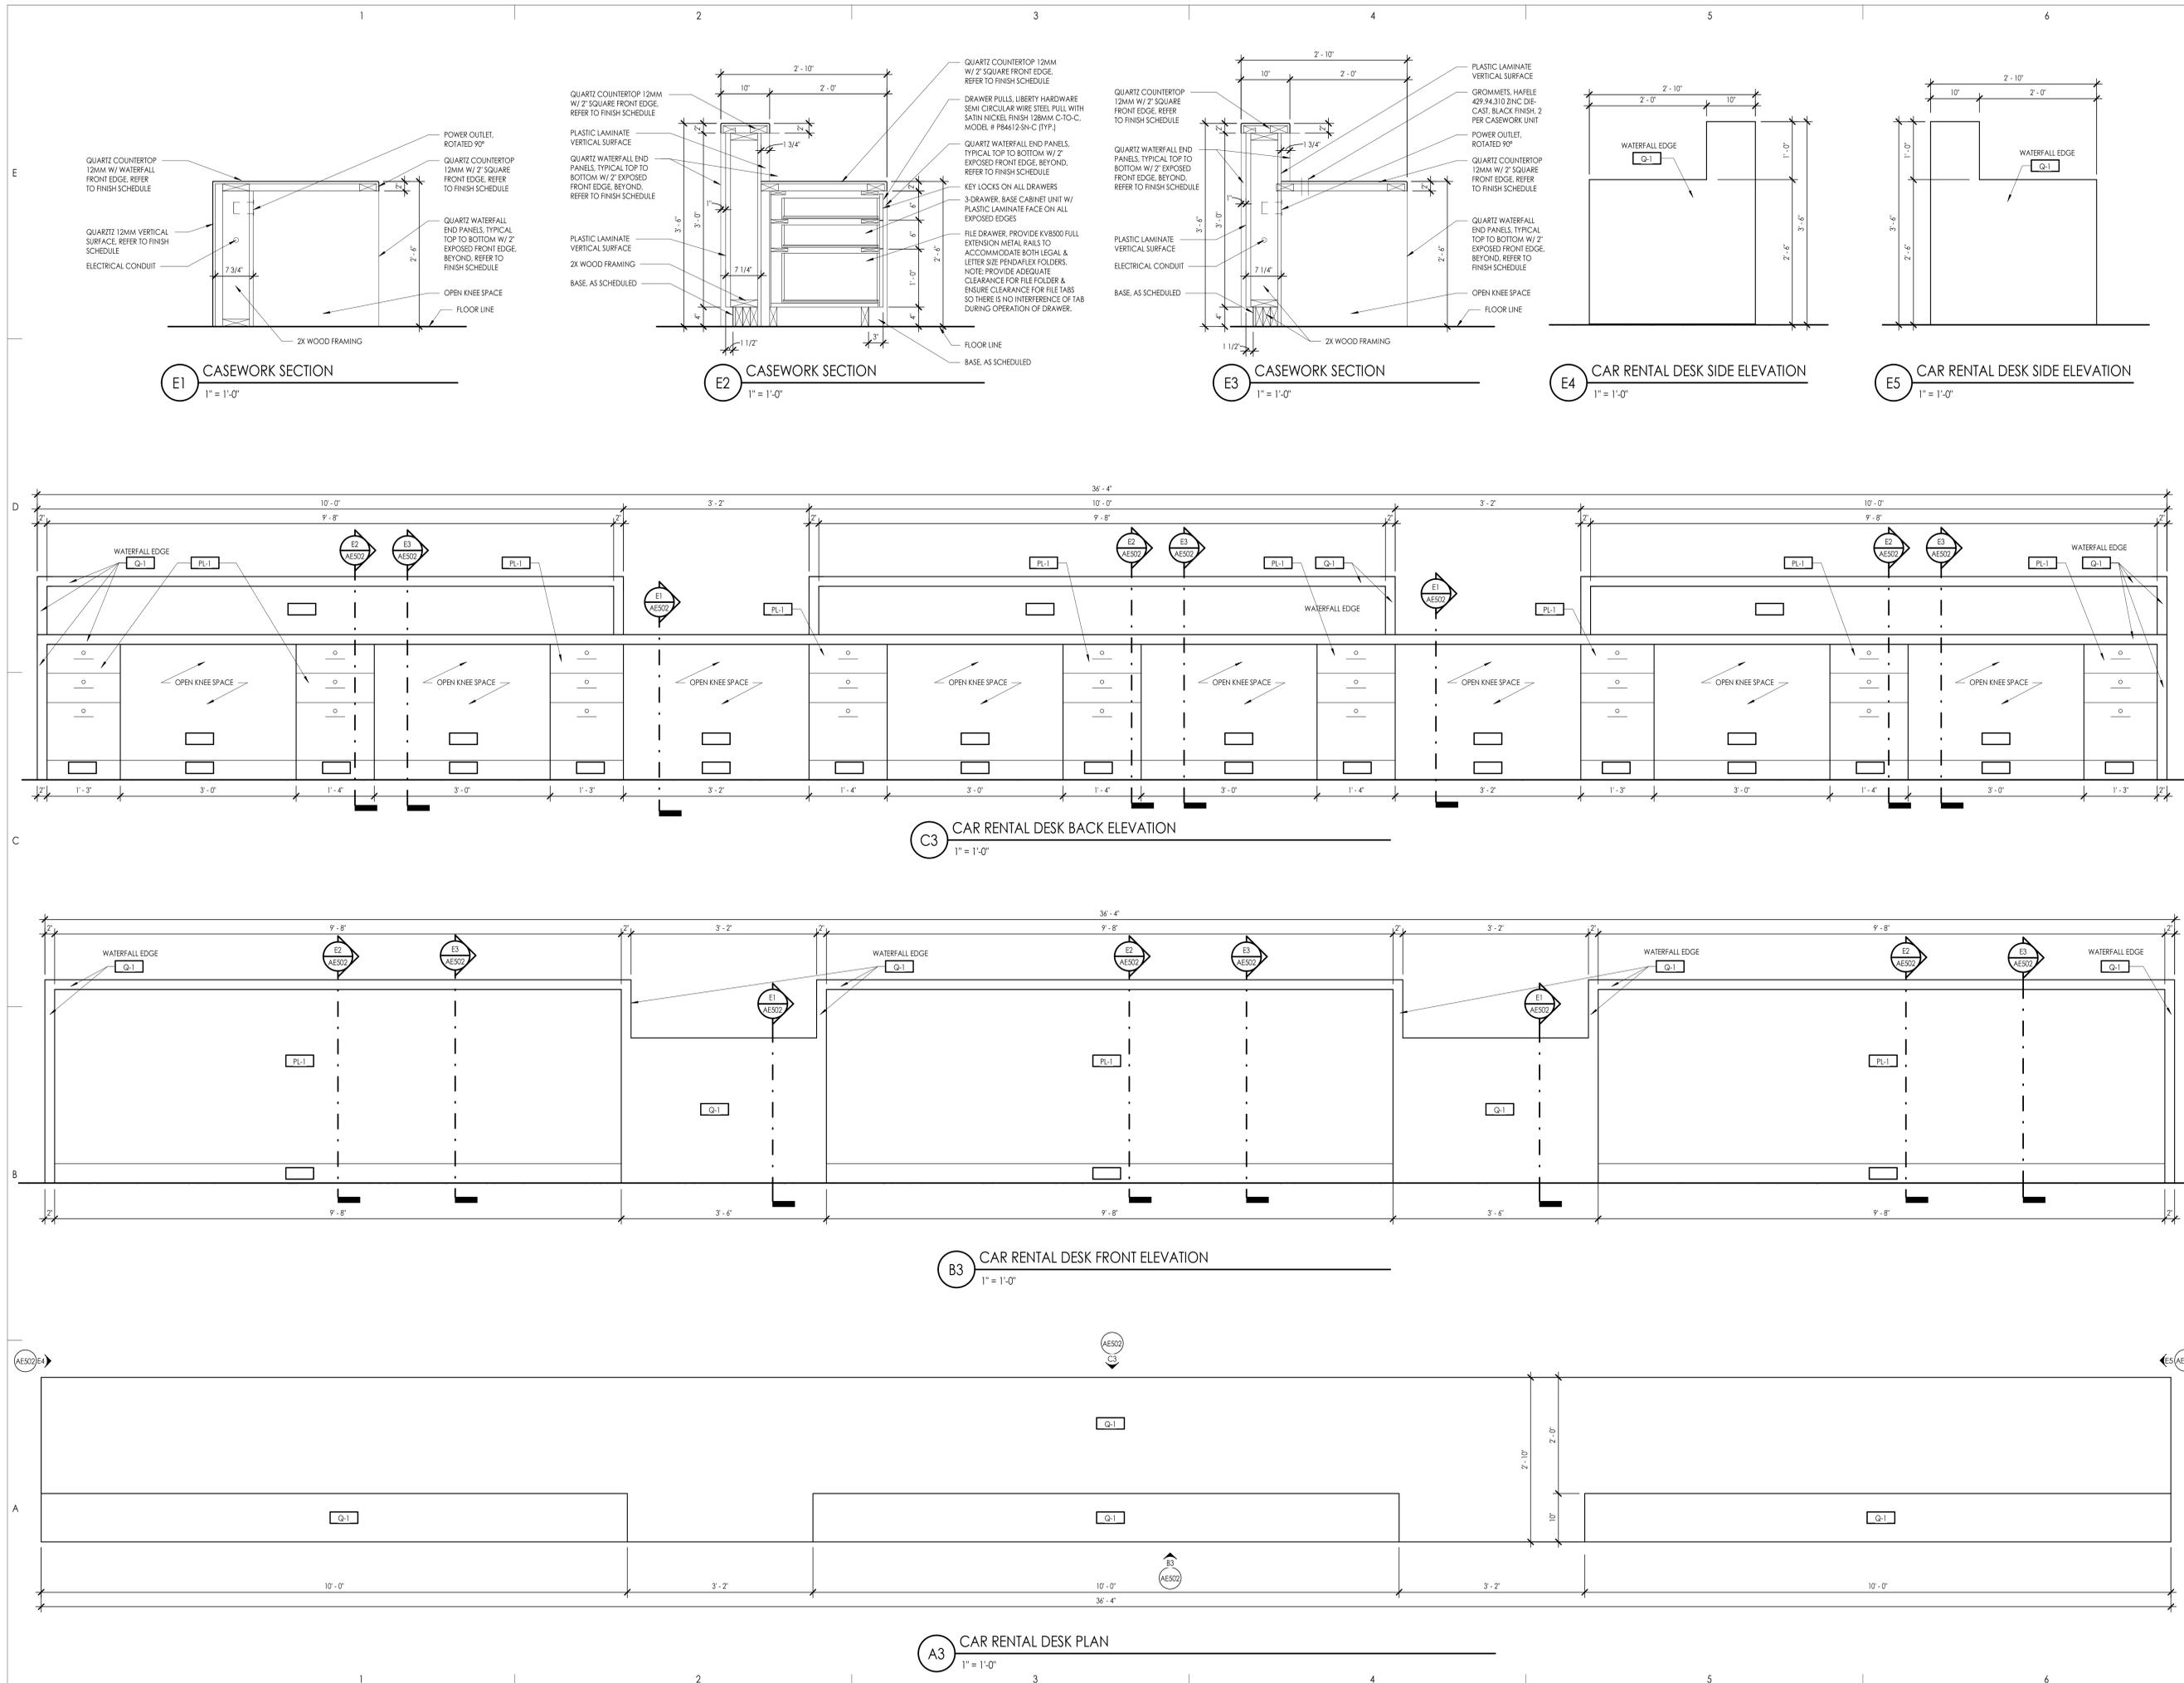

Project Name

Issued	No.	Date	Description
1	11-15-2022	BID SET	

Revision


No.	Date	Description

SAA Project No. 2021-10
Drawing Title


MILLWORK DETAILS

Sheet Number


AE502

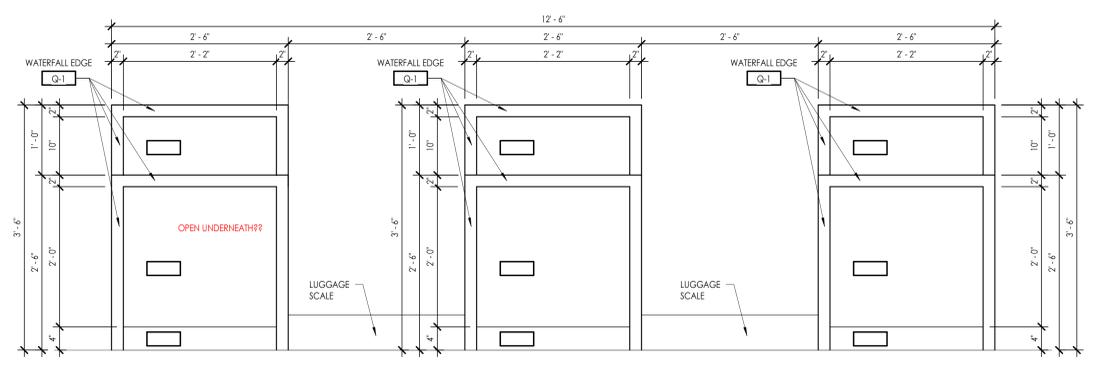


E3 TICKETING DESK BACK ELEVATION
 1" = 1'-0"

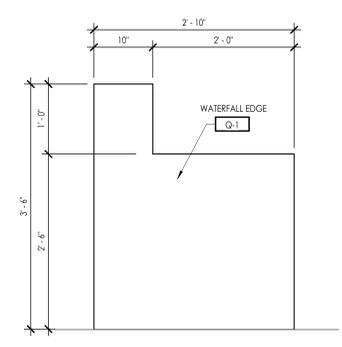


C2 TICKETING DESK SIDE ELEVATION
 1" = 1'-0"

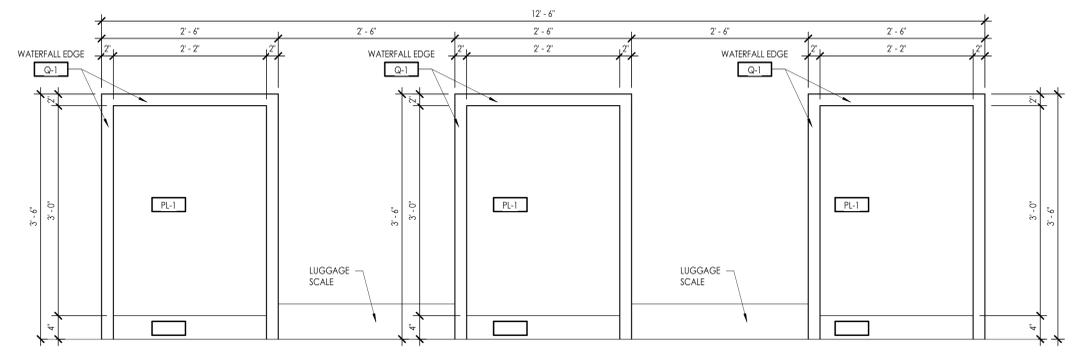


C3 TICKETING DESK FRONT ELEVATION
 1" = 1'-0"

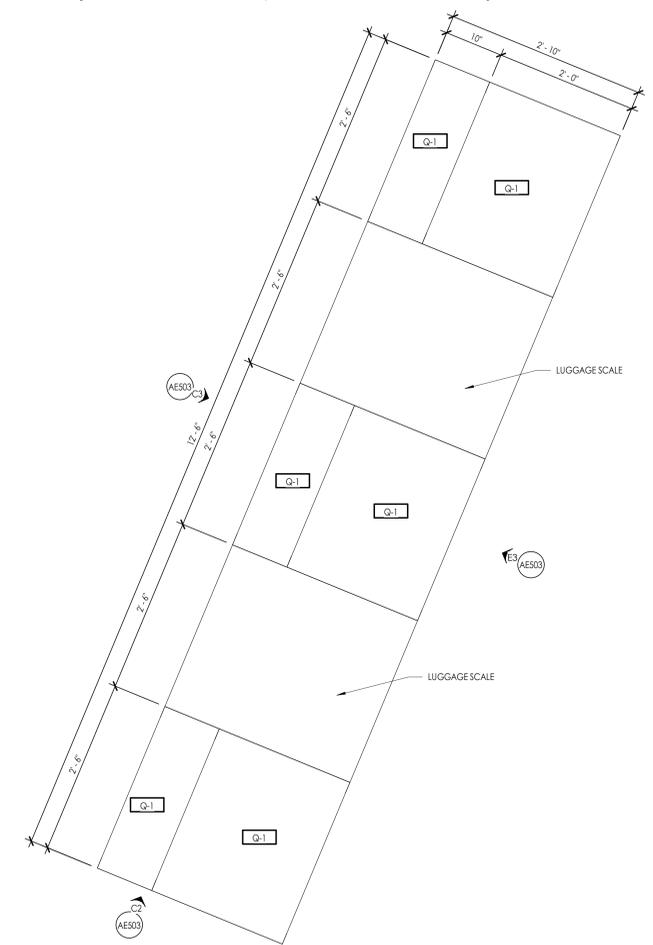


C6 TICKETING DESK PLAN
 1" = 1'-0"

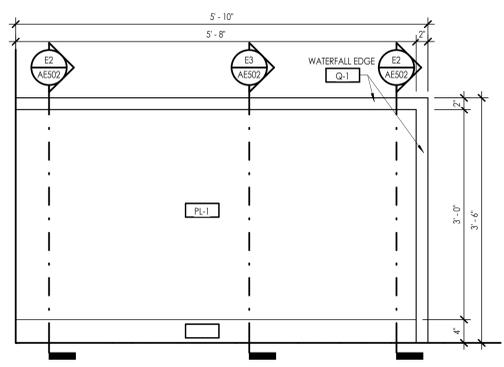


B2 INFORMATION DESK FRONT ELEVATION
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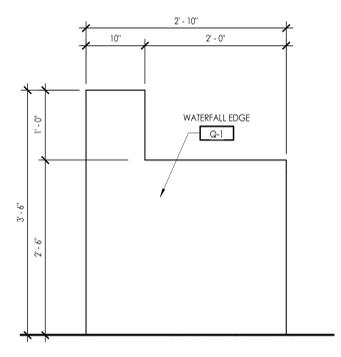
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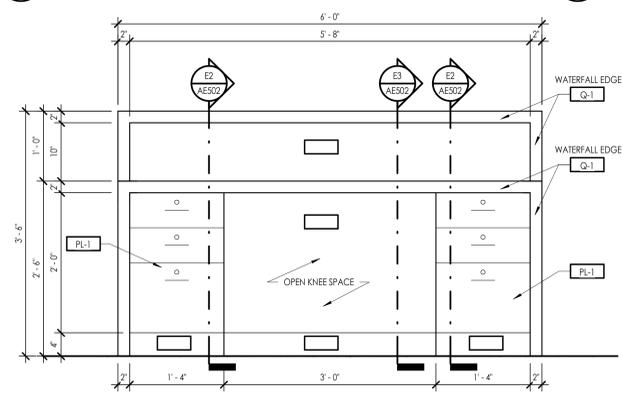
B4 INFORMATION DESK BACK ELEVATION
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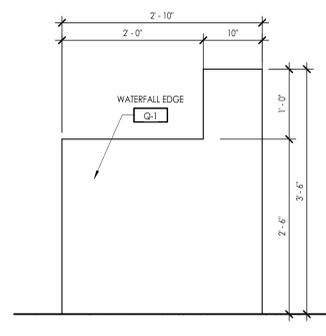
B6 INFORMATION DESK PLAN
 1" = 1'-0"

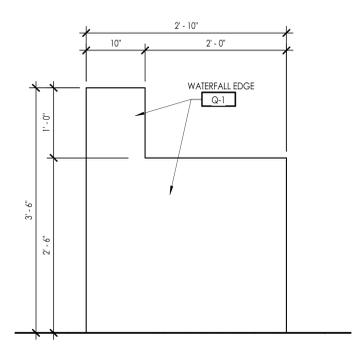


A1 GATE DESK SIDE ELEVATION
 1" = 1'-0"

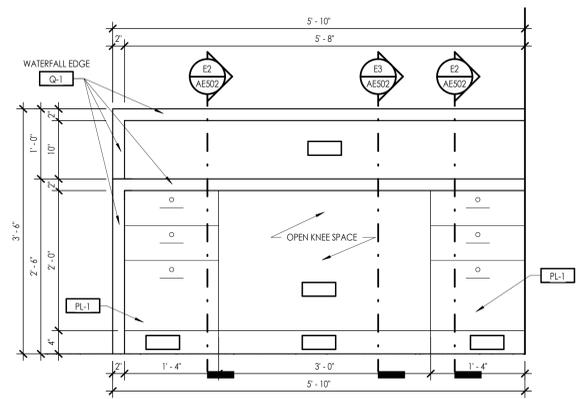


A2 GATE DESK BACK ELEVATION
 1" = 1'-0"

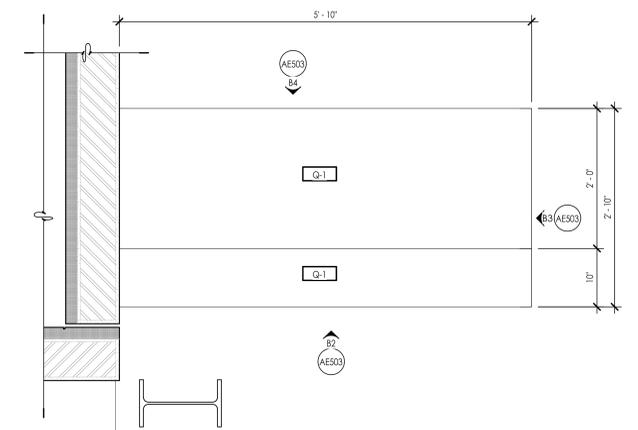

A3 GATE DESK SIDE ELEVATION
 1" = 1'-0"

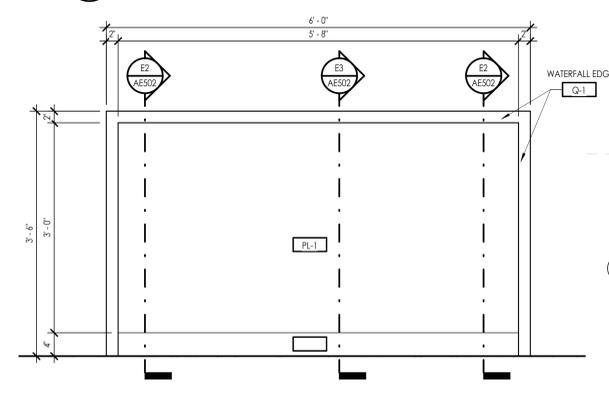

A4 GATE DESK FRONT ELEVATION
 1" = 1'-0"

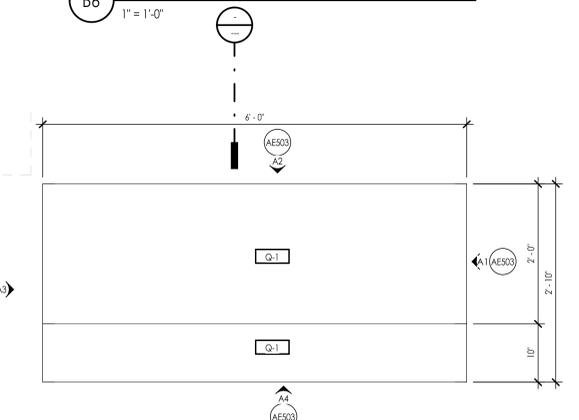


A5 GATE DESK PLAN
 1" = 1'-0"


Project Name: OGDEN-HINCKLEY AIRPORT TERMINAL EXPANSION

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No.	Date	Description
1	11-15-2022	BID SET
Revision		
No.	Date	Description


SAA Project No. 2021-10
 Drawing Title

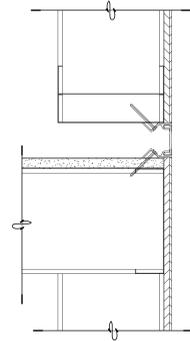


E1 EXPANSION JOINT (VERT.)
3" = 1'-0"

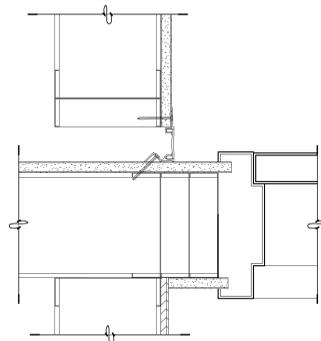


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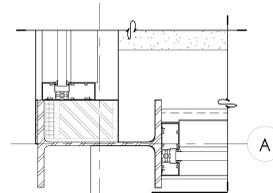
E3 EXPANSION JOINT (VERT.)
3" = 1'-0"

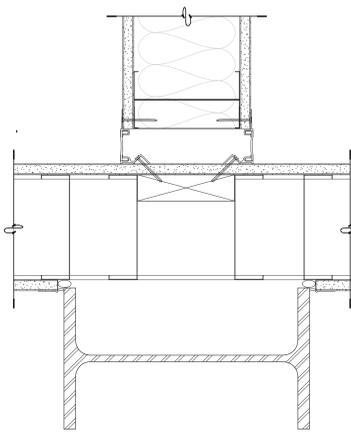


3 Detail 1
1 1/2" = 1'-0"

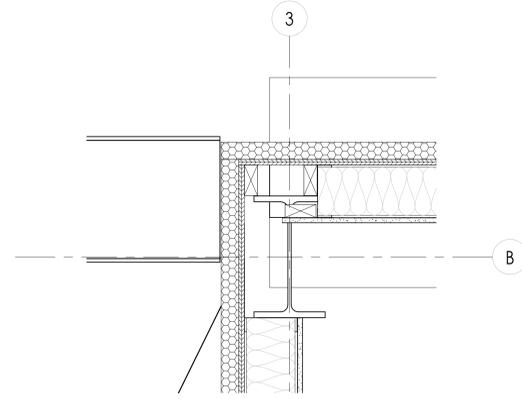


2 Detail 0
1 1/2" = 1'-0"

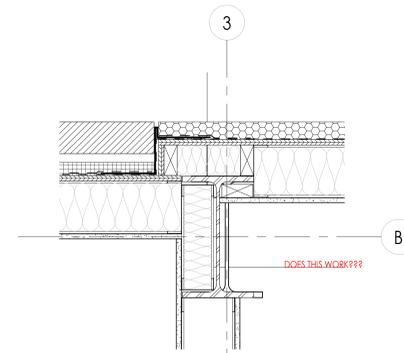


B5 PLAN DETAIL
1 1/2" = 1'-0"

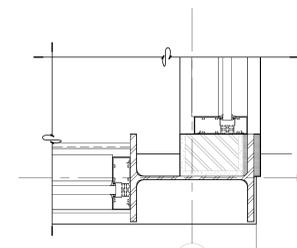


B6 PLAN DETAIL
1 1/2" = 1'-0"

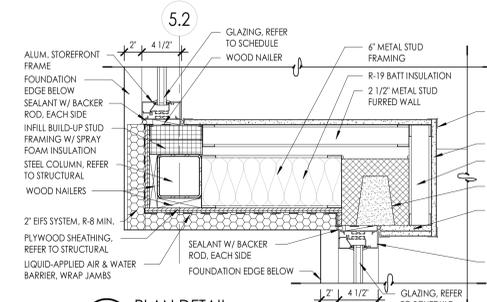


5 PLAN DETAIL
1 1/2" = 1'-0"

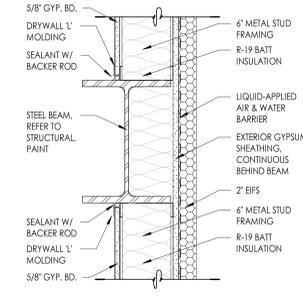


4 WALL DETAIL
1 1/2" = 1'-0"

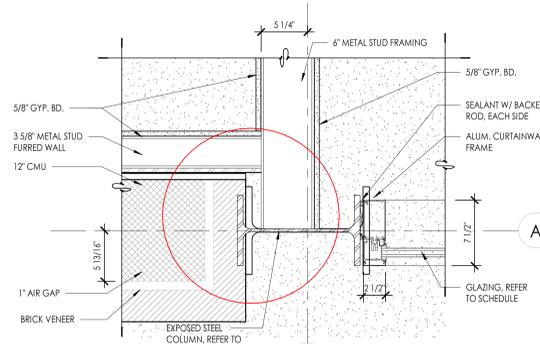


A5 PLAN DETAIL
1 1/2" = 1'-0"

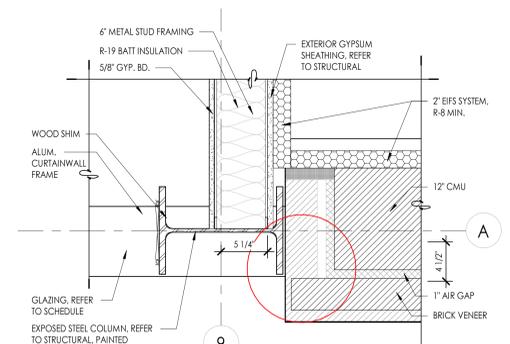

A6 PLAN DETAIL
1 1/2" = 1'-0"

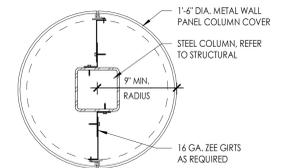

E6 COLUMN COVER DETAIL
1 1/2" = 1'-0"

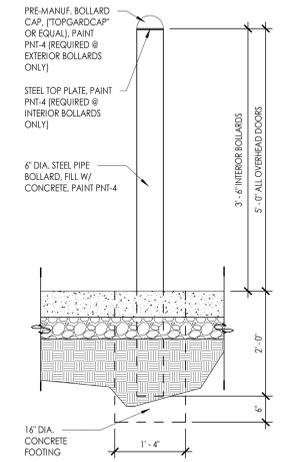

1 6" BOLLARD DETAIL
3/4" = 1'-0"



General Contractor
STACEY CONSTRUCTION
 Stacey Construction
 Construction Manager
 General Contractor
 3788 Pacific Ave.
 Ogden, UT 84405
 801.521.6210
 www.staceycg.com

Consultant

OGDEN-HINCKLEY AIRPORT
TERMINAL EXPANSION
 3909 AIRPORT ROAD
 OGDEN, UT 84405

Project Name


Issued	No.	Date	Description
	1	11-15-2022	BID SET

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No.	Date	Description

SAA Project No. 2021-10
 Drawing Title

PLAN DETAILS
 Sheet Number
AE511

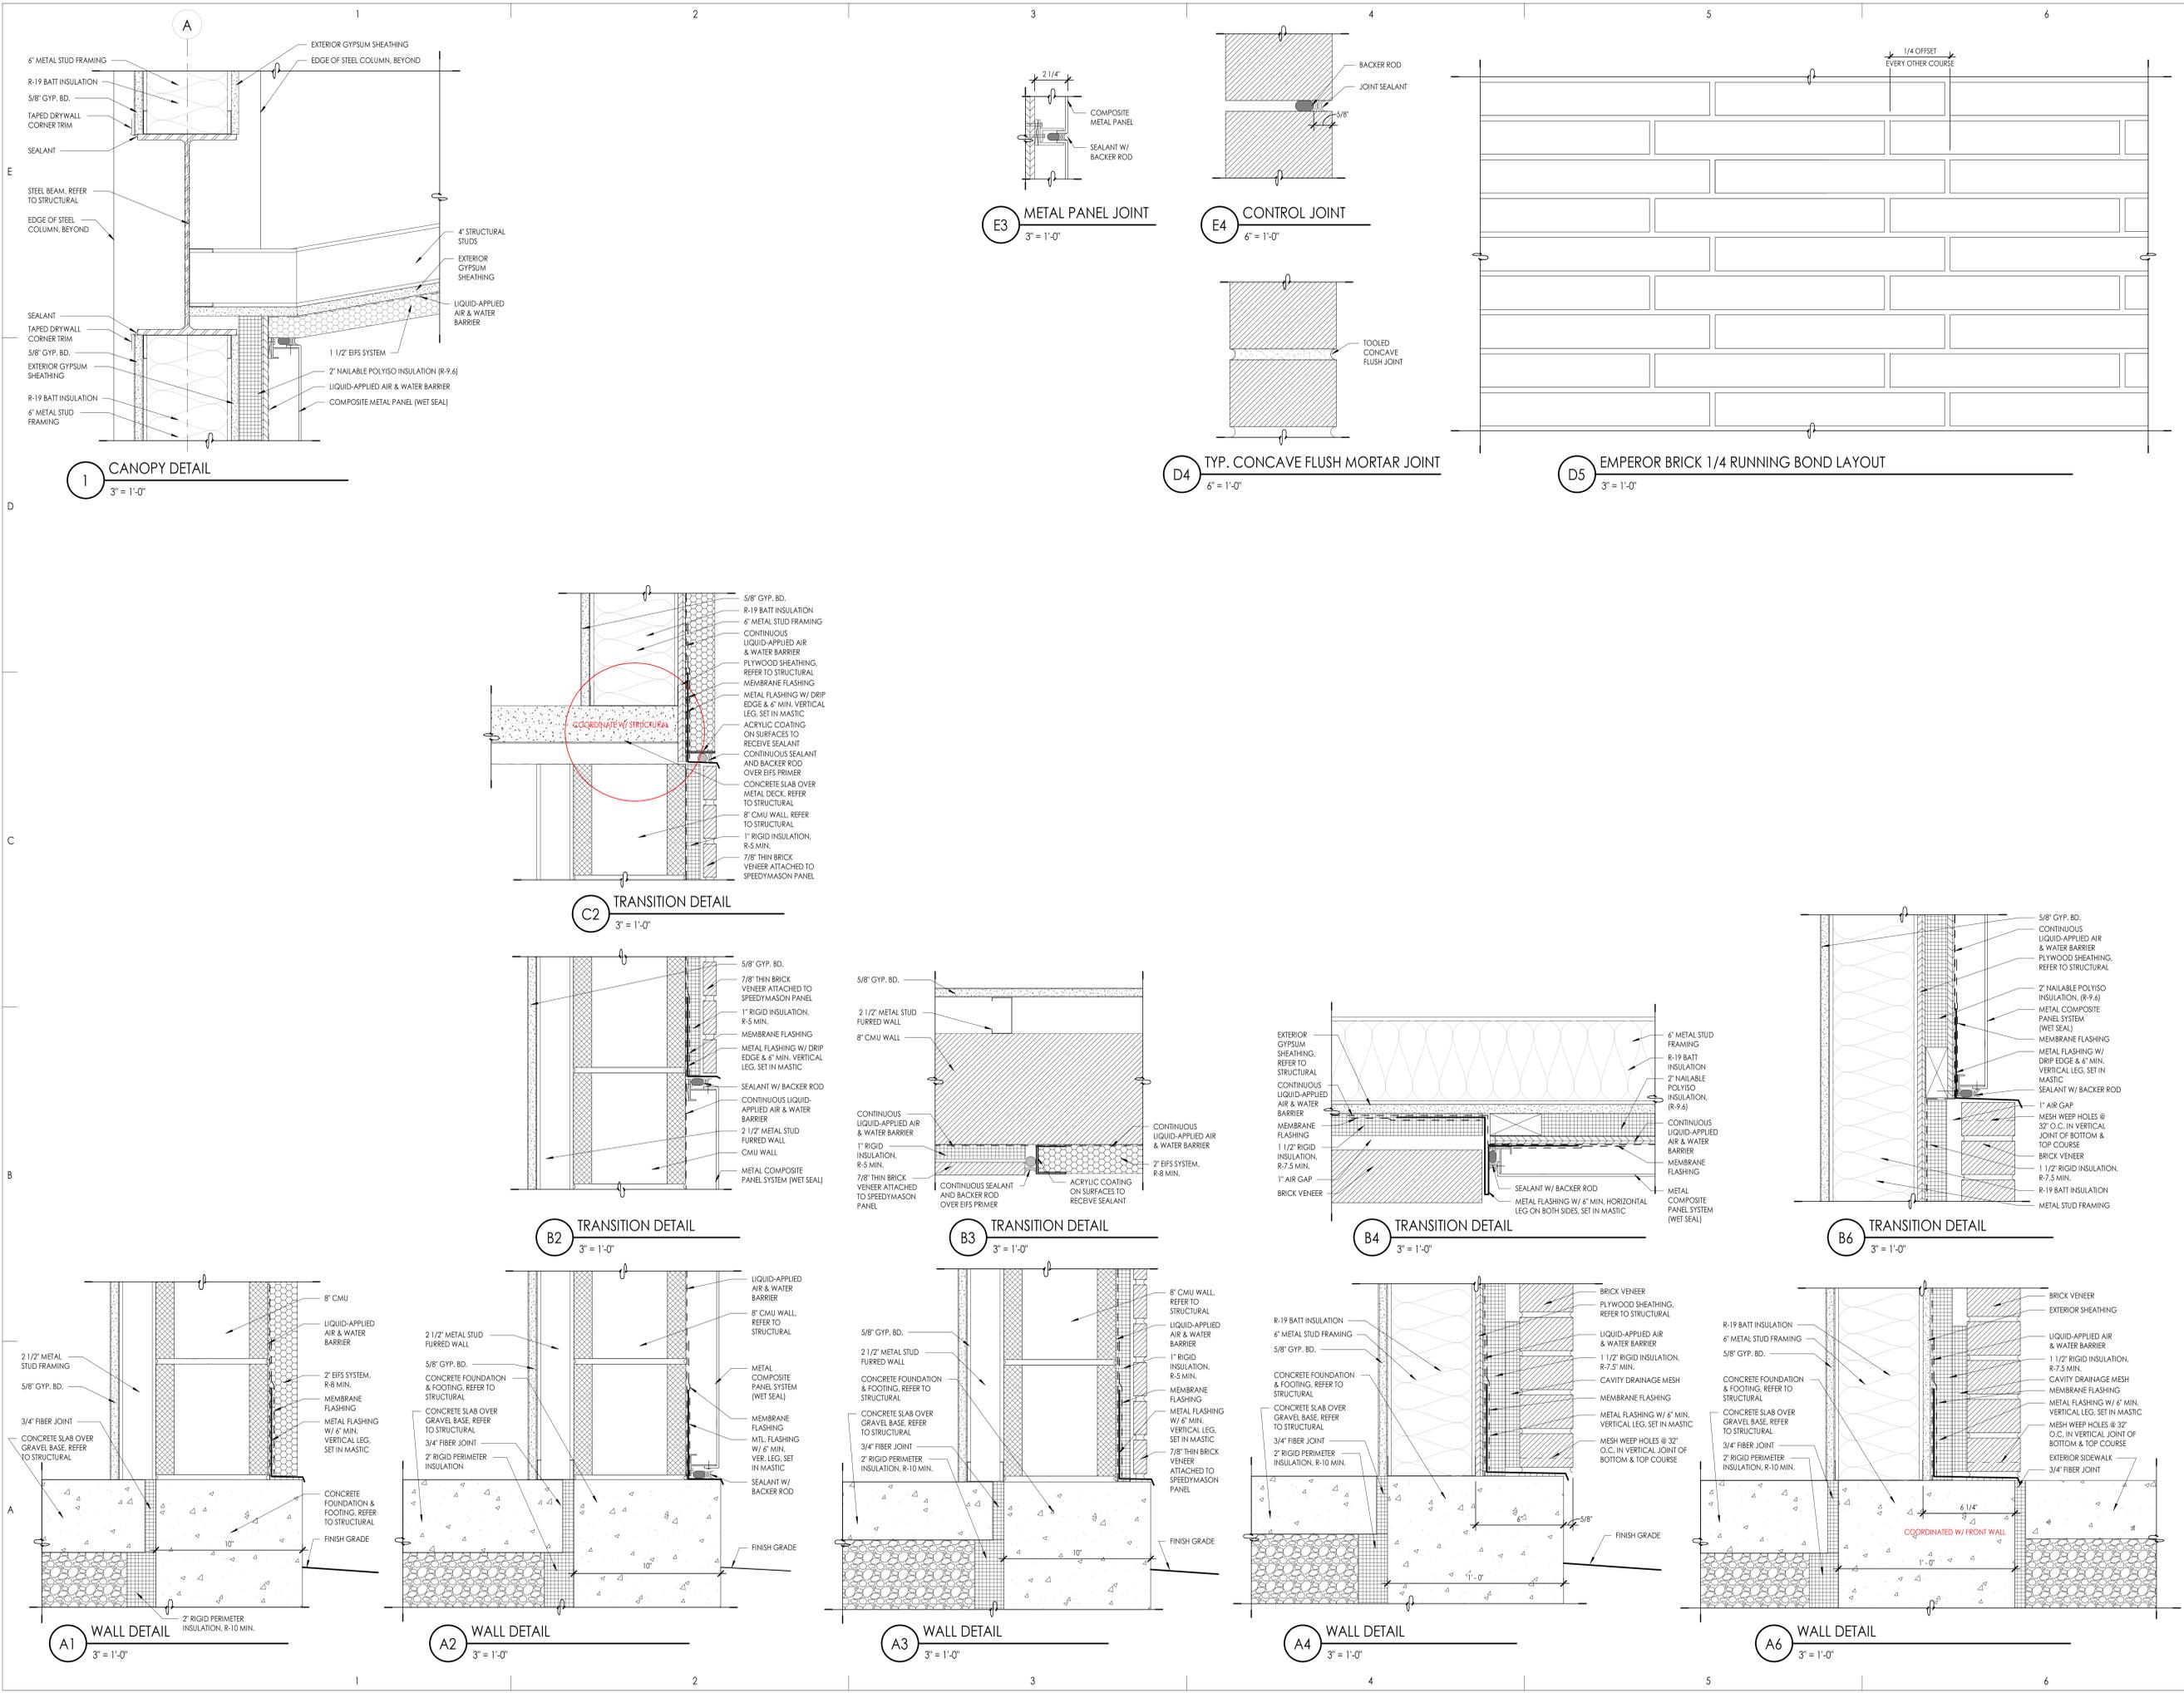


Project Name

Issued	No.	Date	Description
1	11-15-2022	BID SET	

Revision

No.	Date	Description

SAA Project No. 2021-10
 Drawing Title

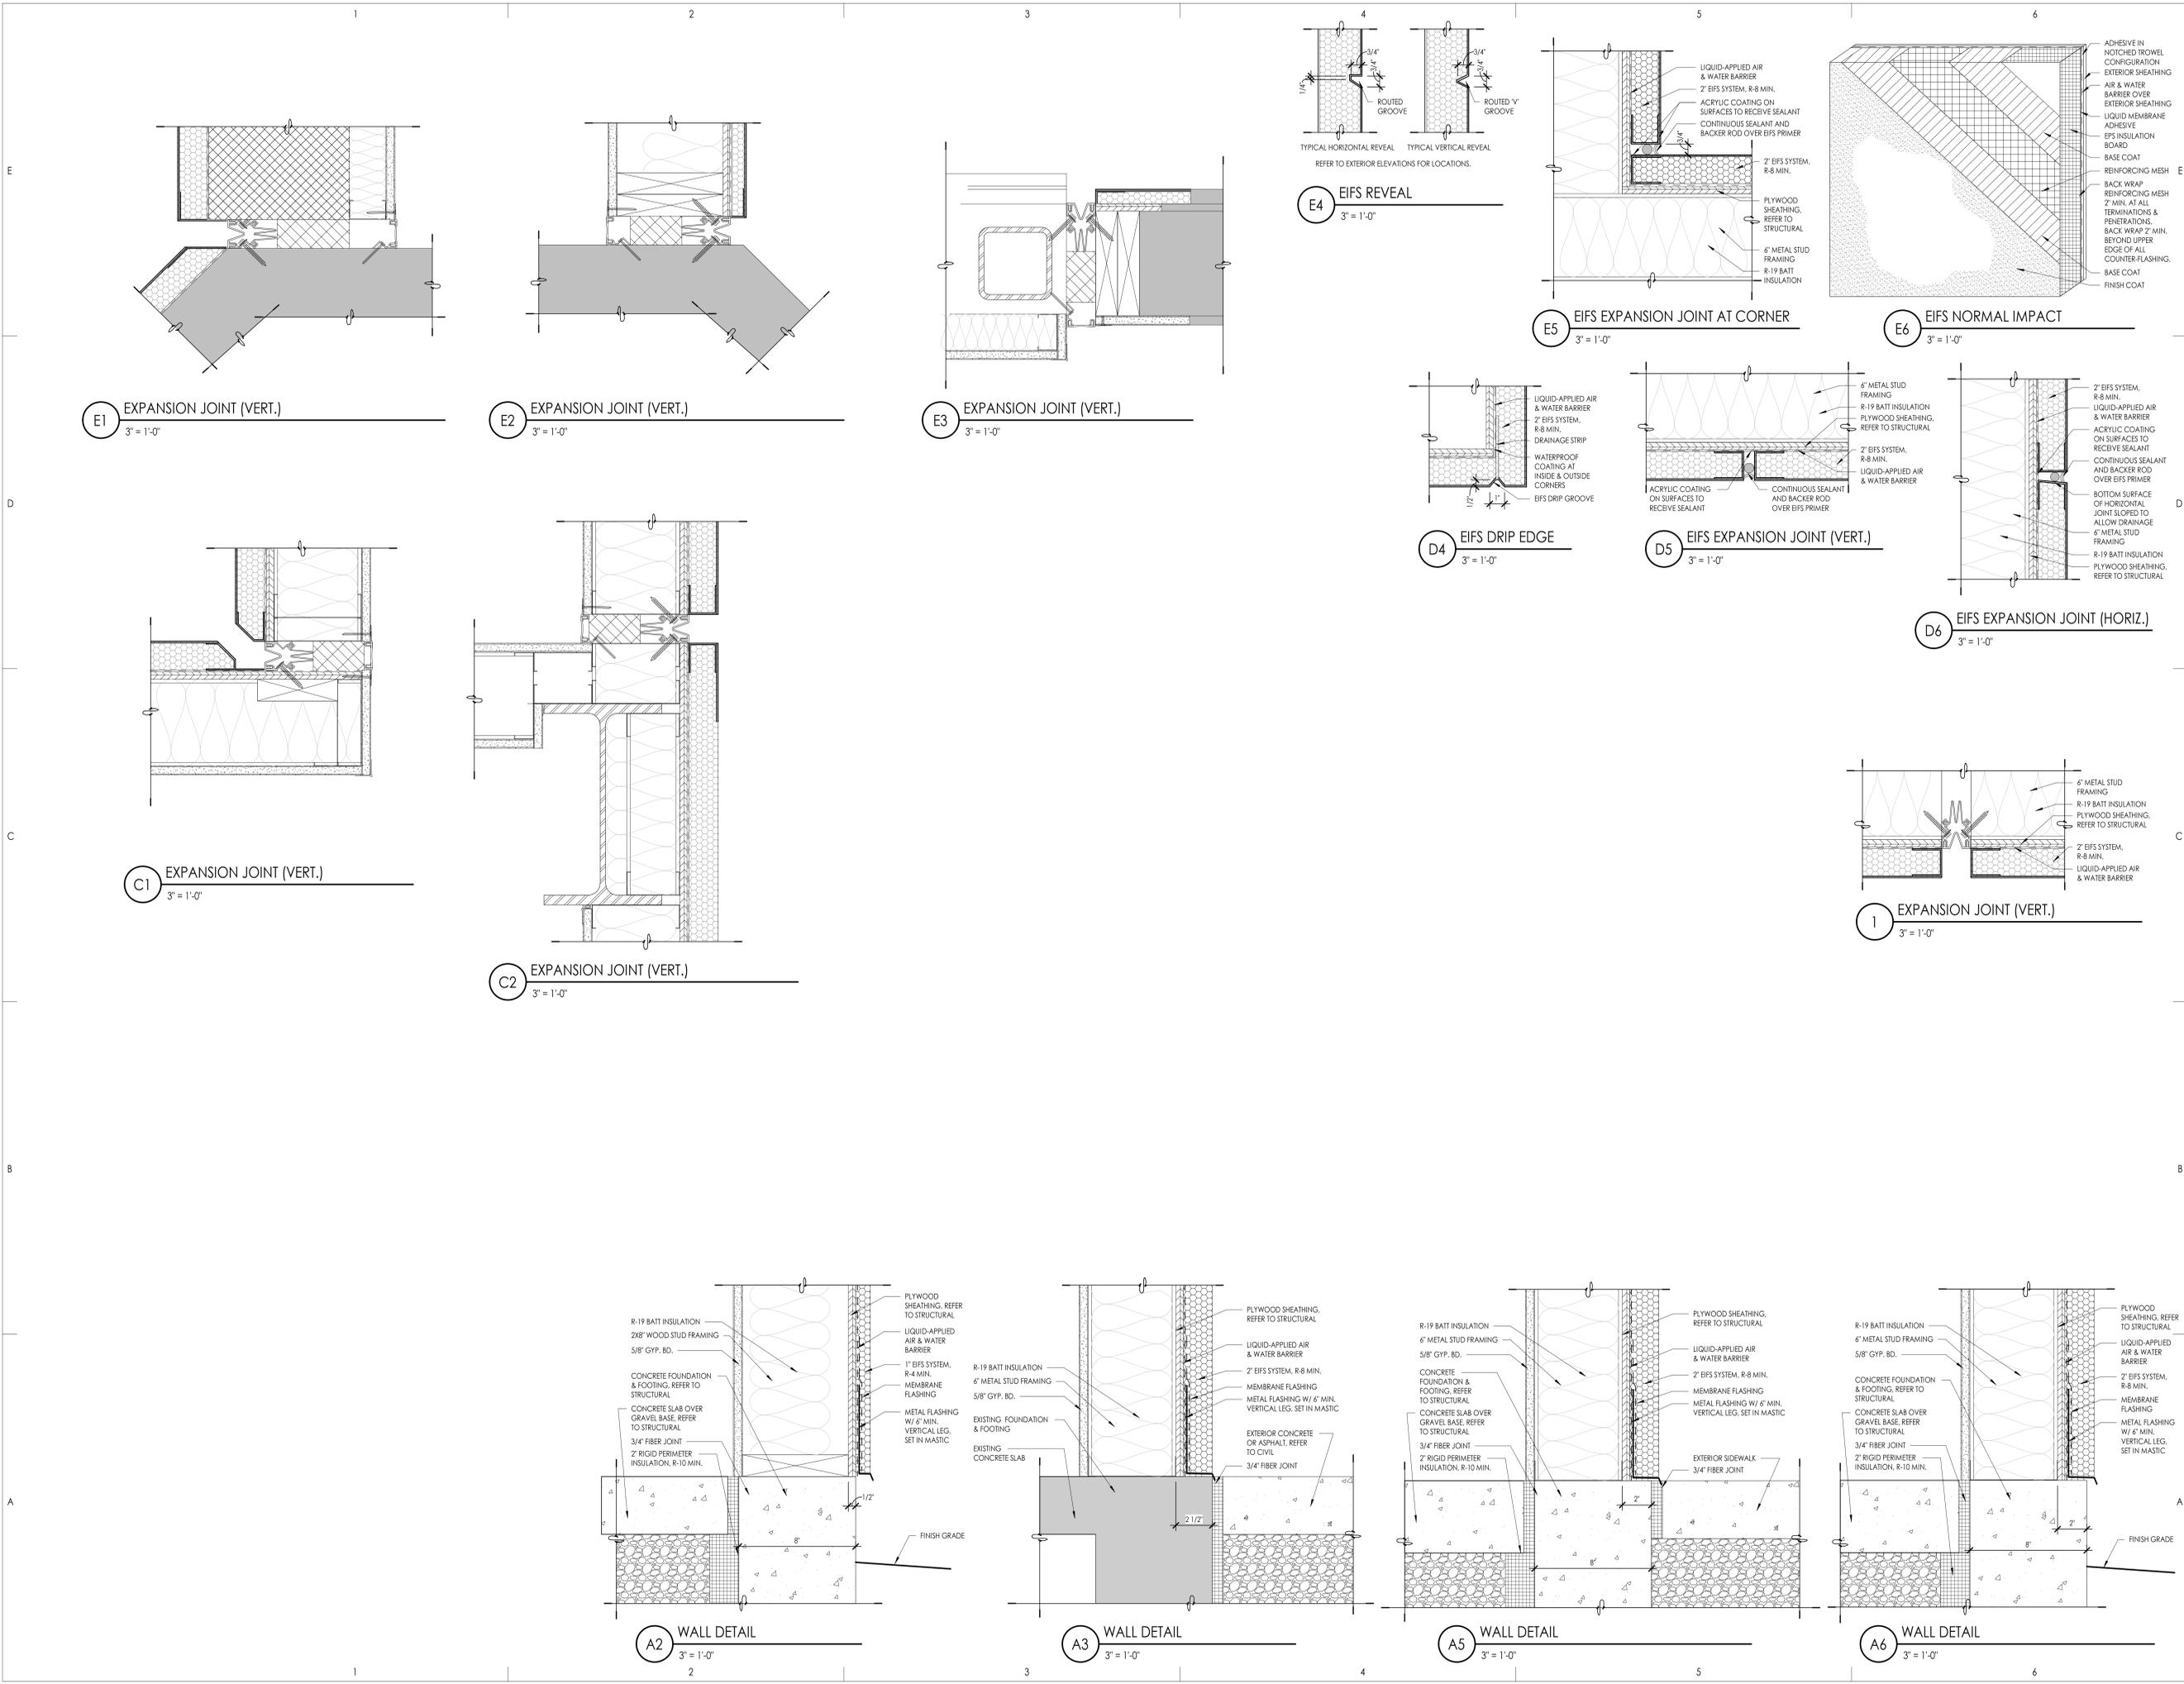

Issued

No.	Date	Description
1	11-15-2022	BID SET

Revision

















No.	Date	Description
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SAA Project No. 2021-10
Drawing Title

EXTERIOR DETAILS

Sheet Number

AE522

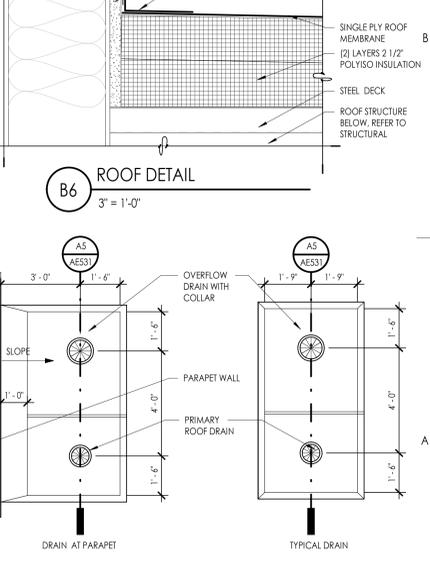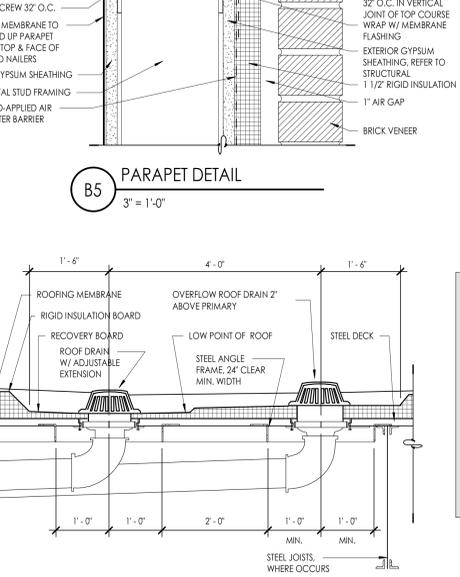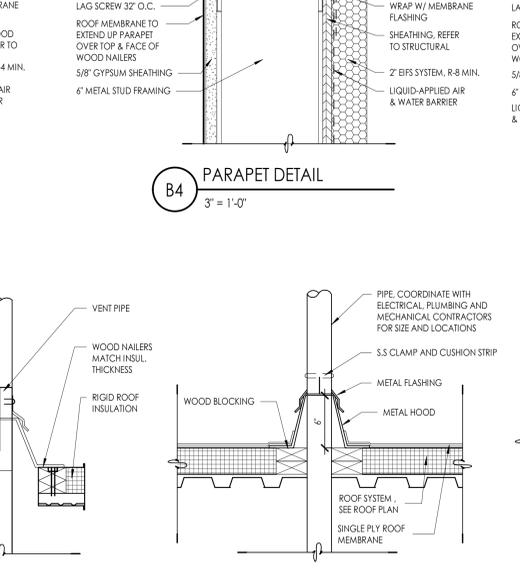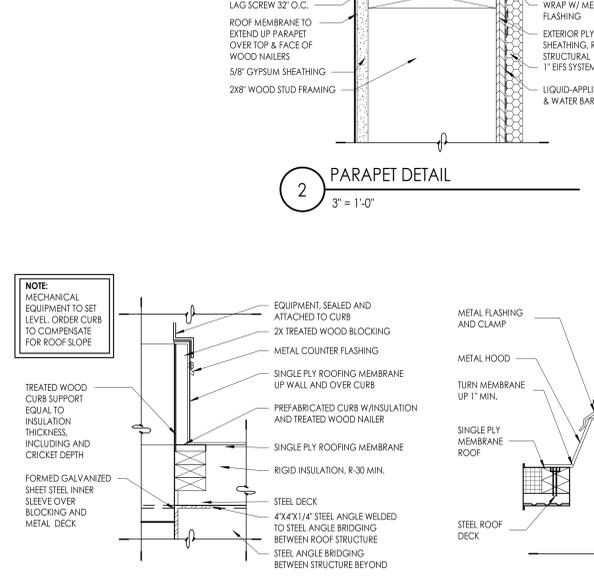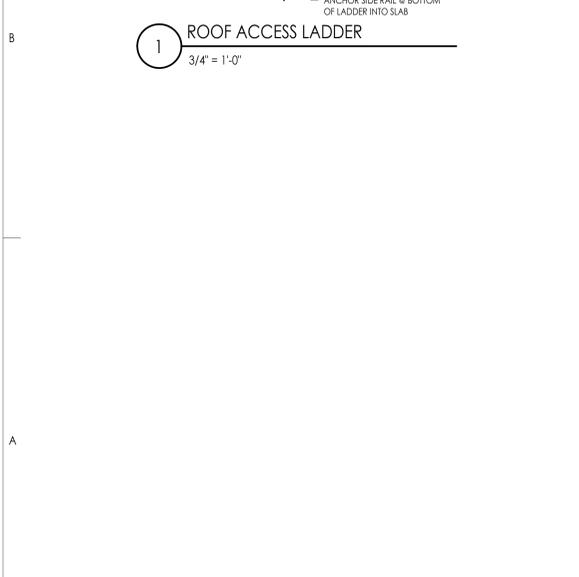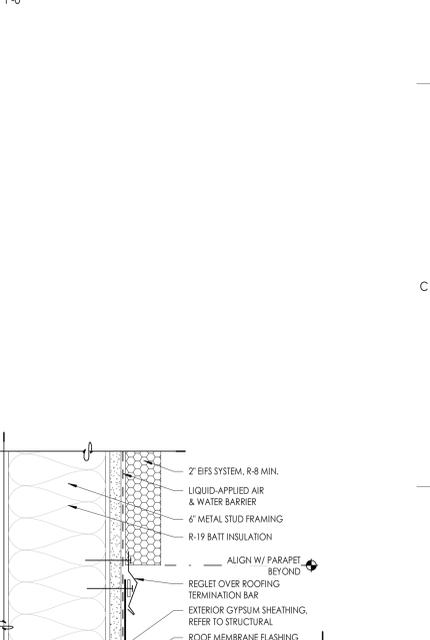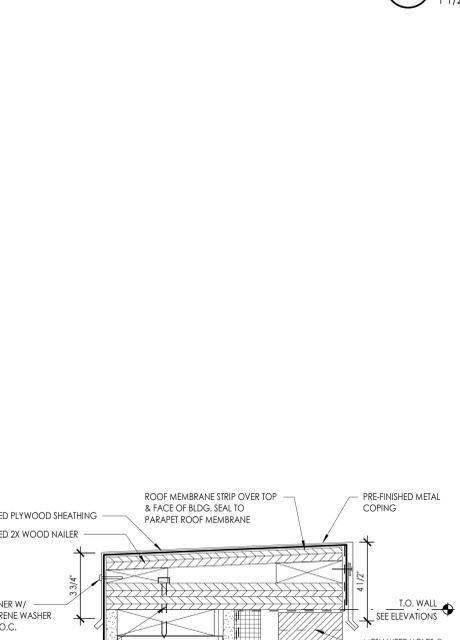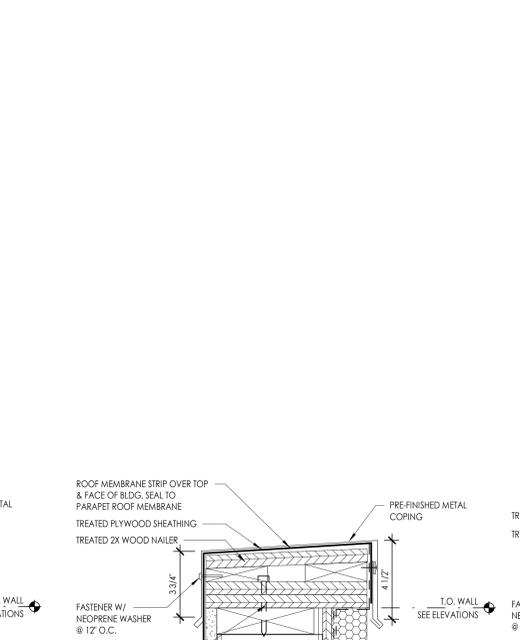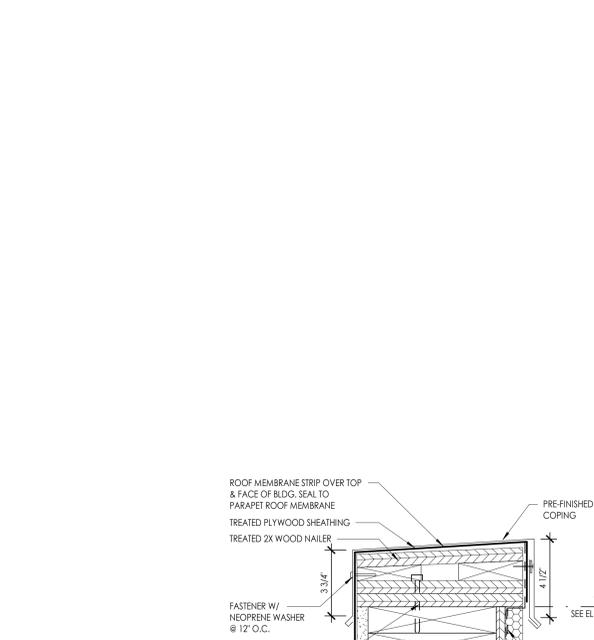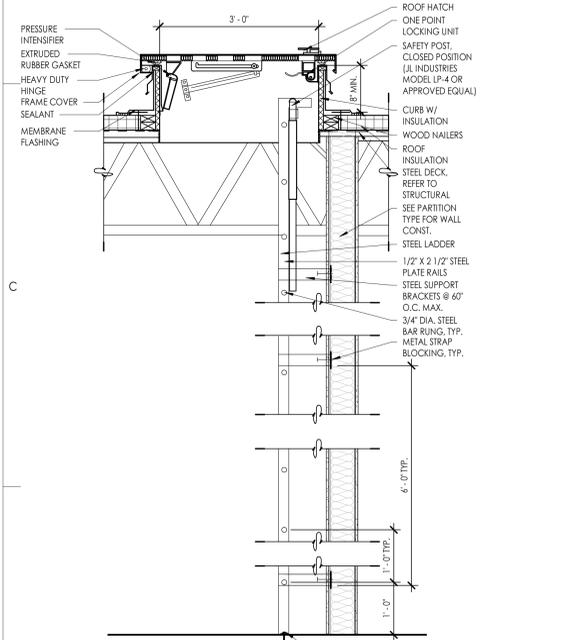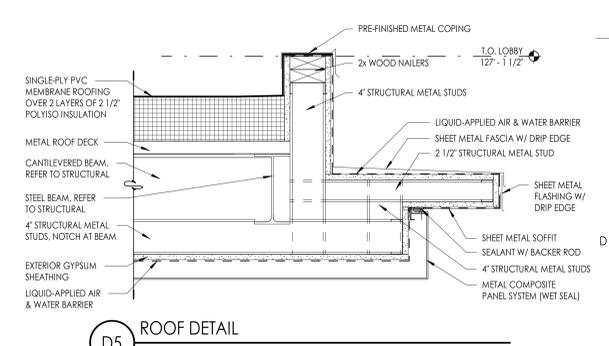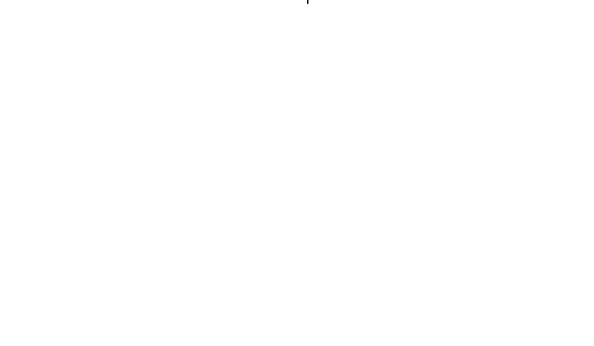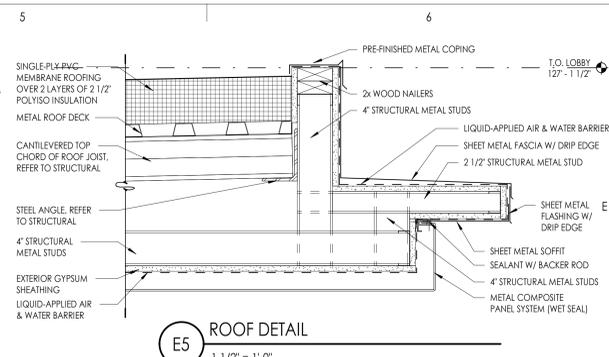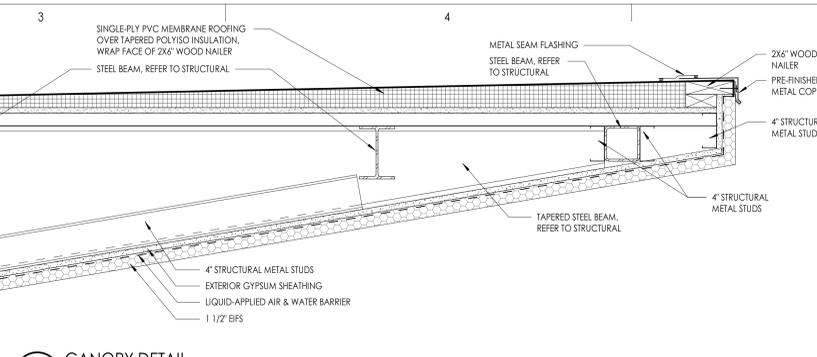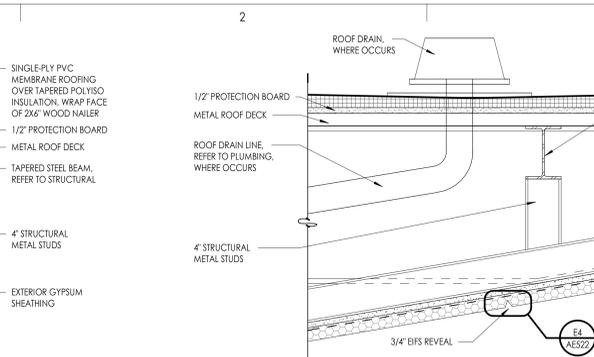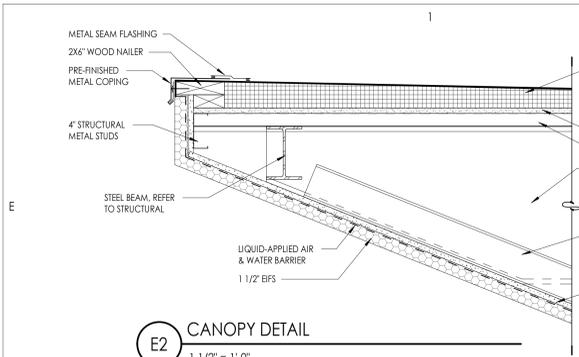

NOTE:
MECHANICAL EQUIPMENT TO SET LEVEL. ORDER CURB TO COMPENSATE FOR ROOF SLOPE.


Project Name

Issued	No.	Date	Description
1	11-15-2022	BID SET	

Revision

No.	Date	Description

SAA Project No. 2021-10
Drawing Title

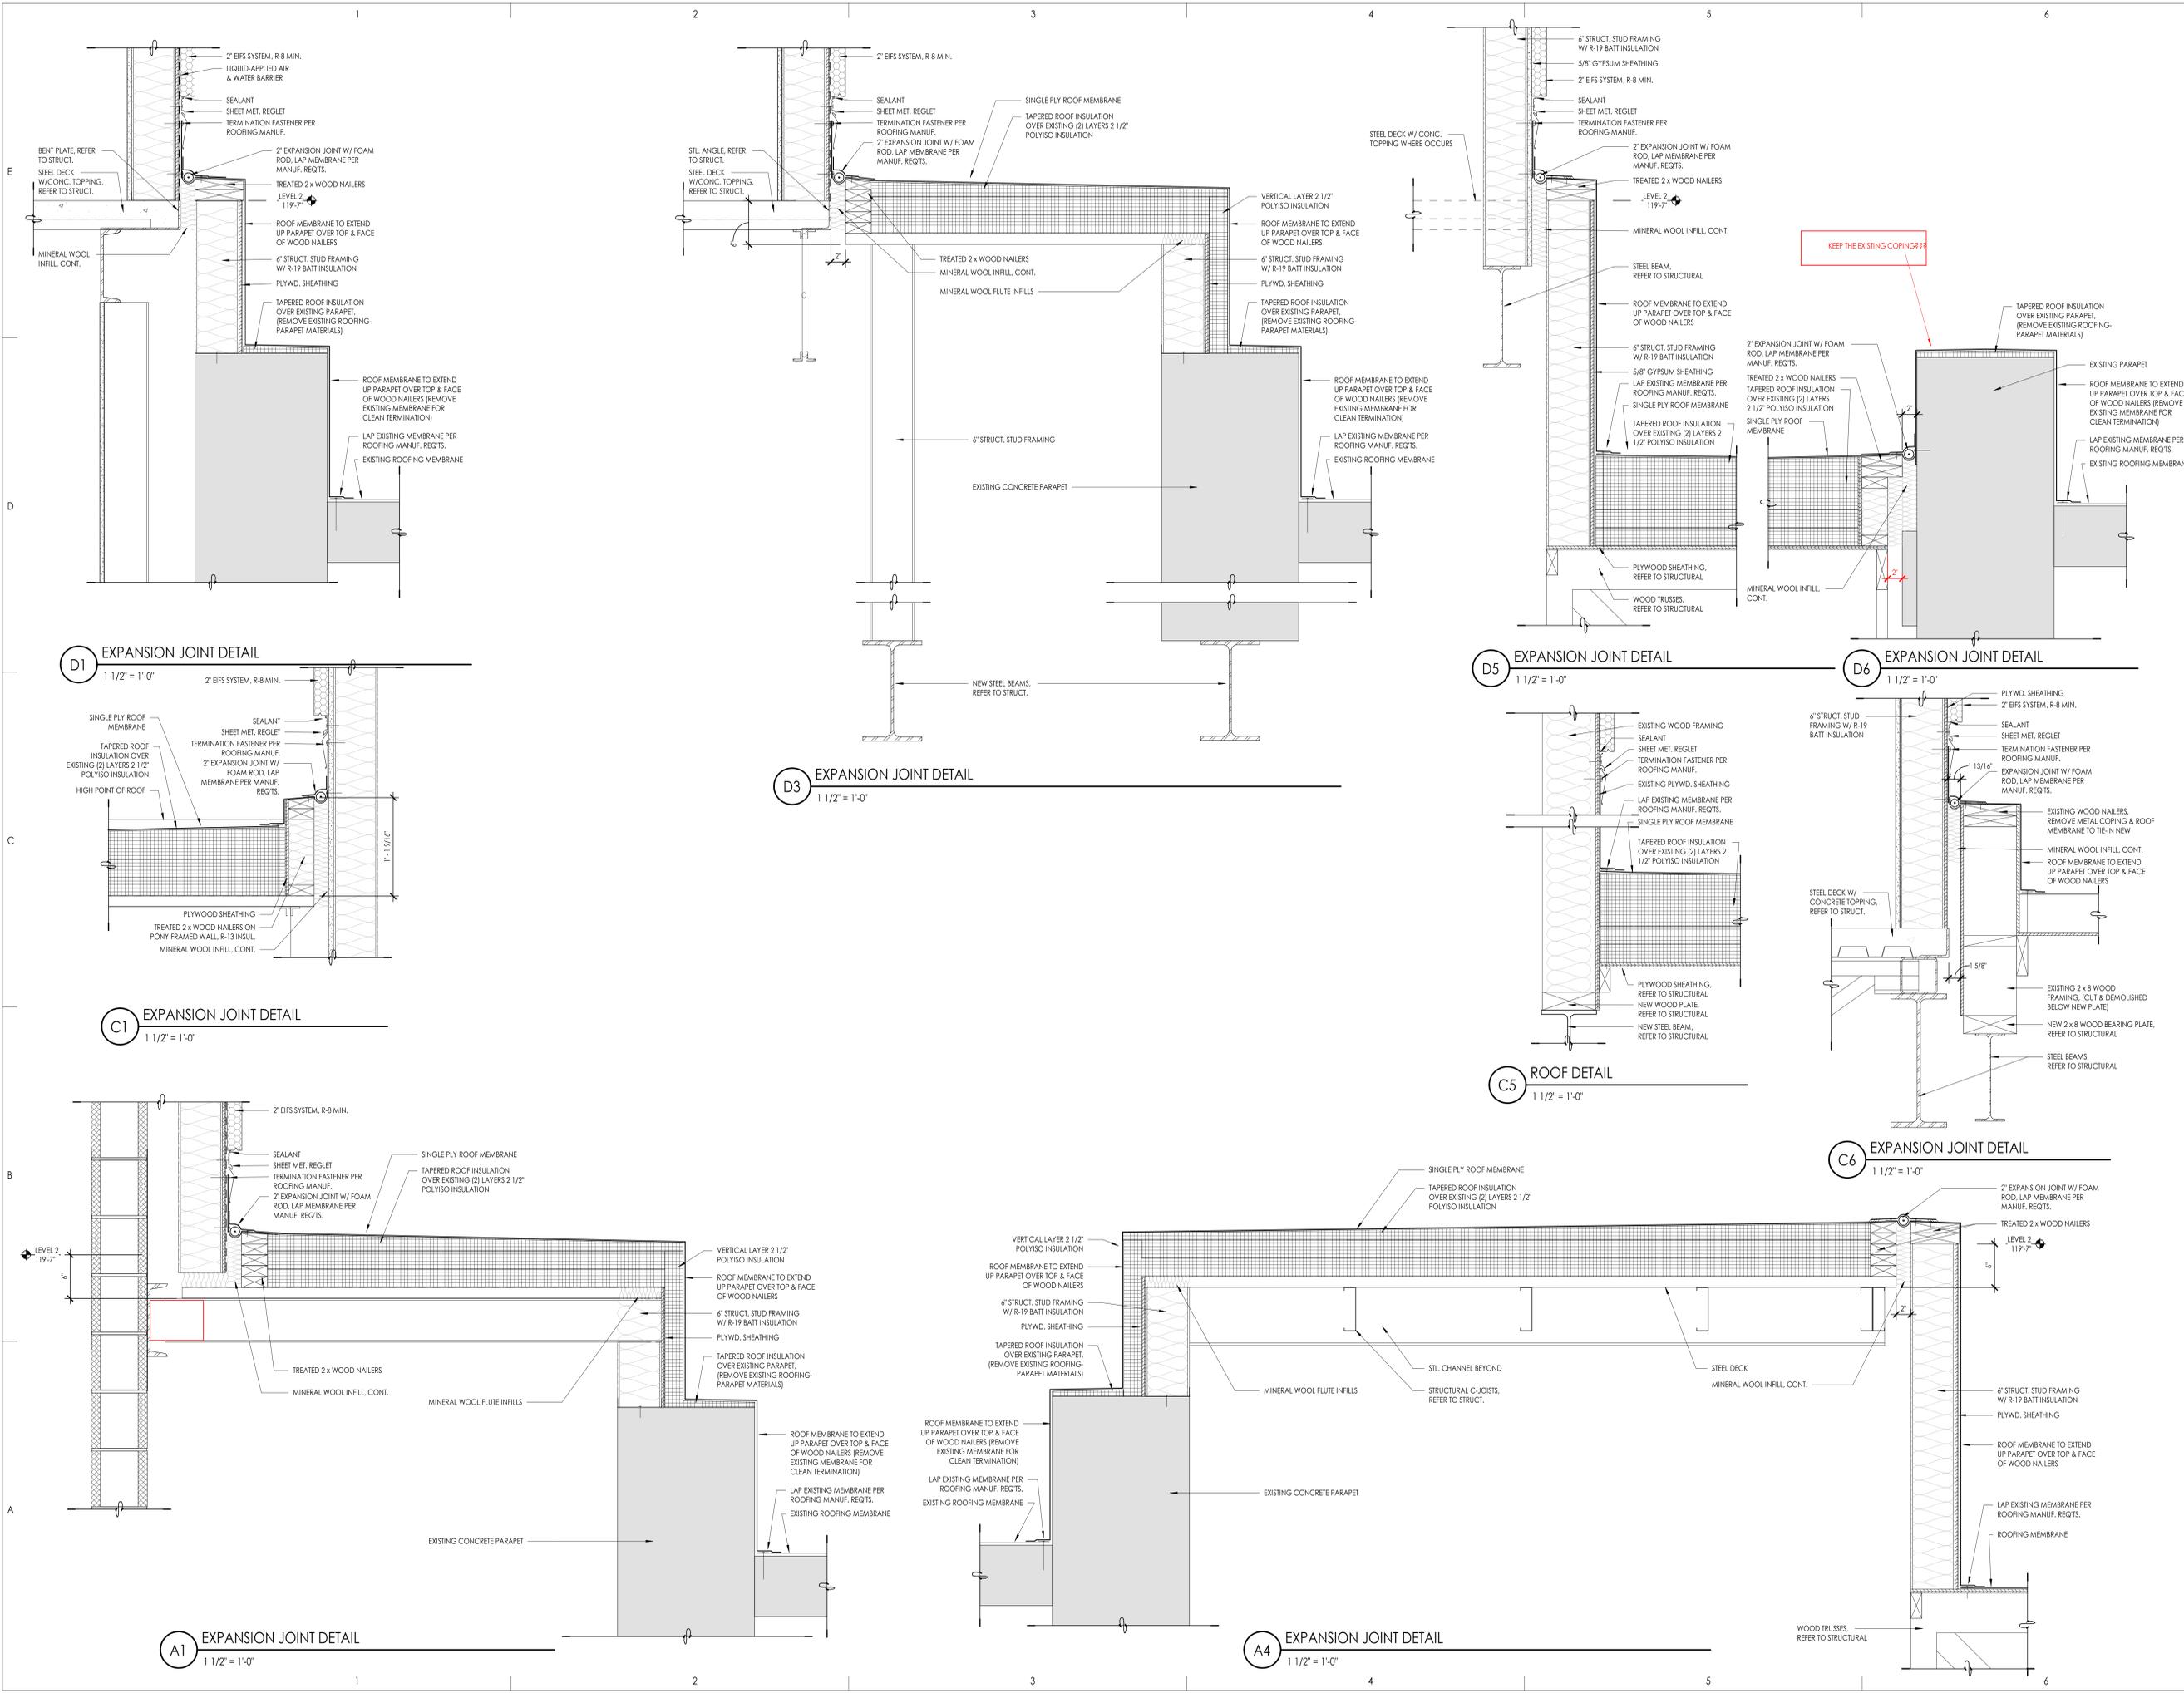

OGDEN-HINCKLEY AIRPORT
TERMINAL EXPANSION
3909 AIRPORT ROAD
OGDEN, UT 84405

Project Name

Issued	No.	Date	Description
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SAA Project No. 2021-10
Drawing Title

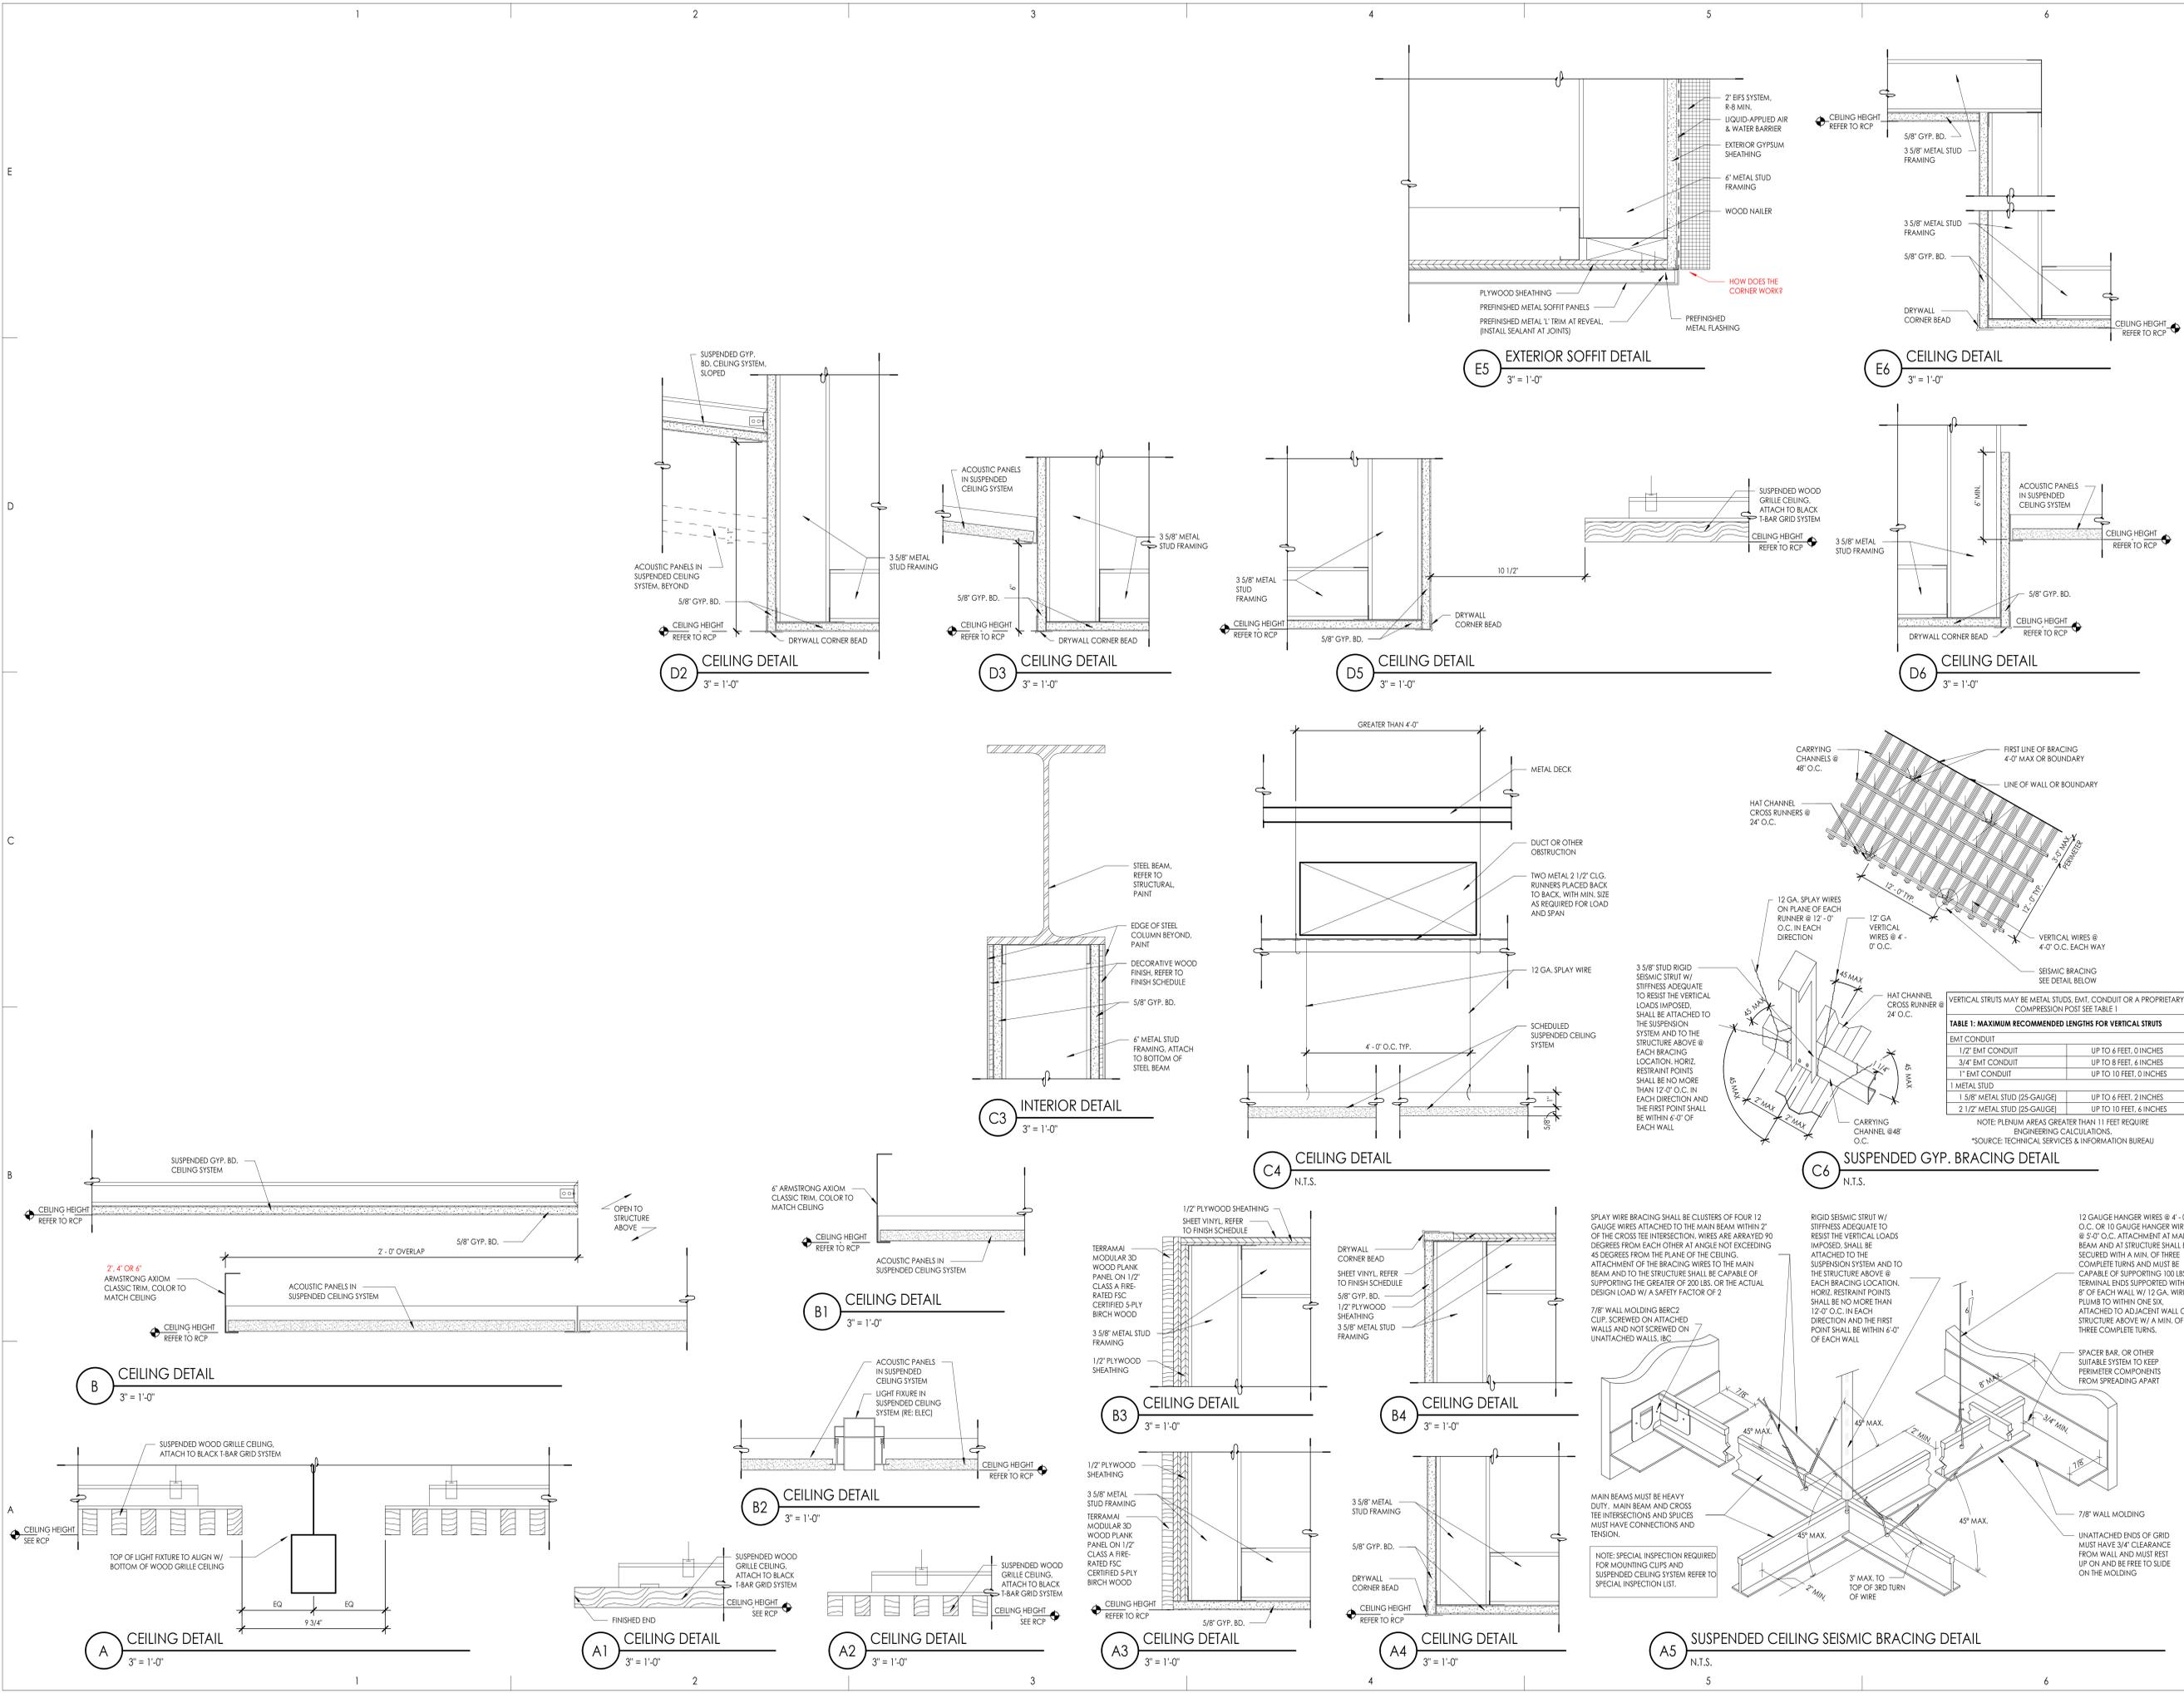


TABLE 1: MAXIMUM RECOMMENDED LENGTHS FOR VERTICAL STRUTS

EMT CONDUIT	UP TO 6 FEET, 0 INCHES
1/2" EMT CONDUIT	UP TO 6 FEET, 0 INCHES
3/4" EMT CONDUIT	UP TO 8 FEET, 6 INCHES
1" EMT CONDUIT	UP TO 10 FEET, 0 INCHES
1" METAL STUD	UP TO 6 FEET, 2 INCHES
1 1/8" METAL STUD (25-GAUGE)	UP TO 10 FEET, 6 INCHES
2 1/2" METAL STUD (25-GAUGE)	UP TO 10 FEET, 6 INCHES

NOTE: PLENUM AREAS GREATER THAN 11 FEET REQUIRE ENGINEERING CALCULATIONS.
*SOURCE: TECHNICAL SERVICES & INFORMATION BUREAU

OGDEN-HINCKLEY AIRPORT
TERMINAL EXPANSION
3909 AIRPORT ROAD
OGDEN, UT 84405

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SAA Project No. 2021-10
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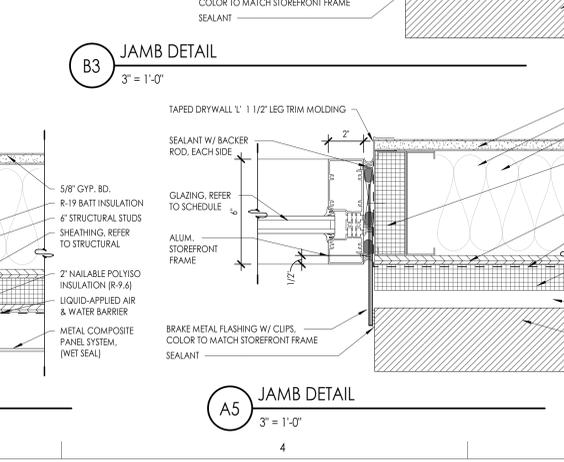
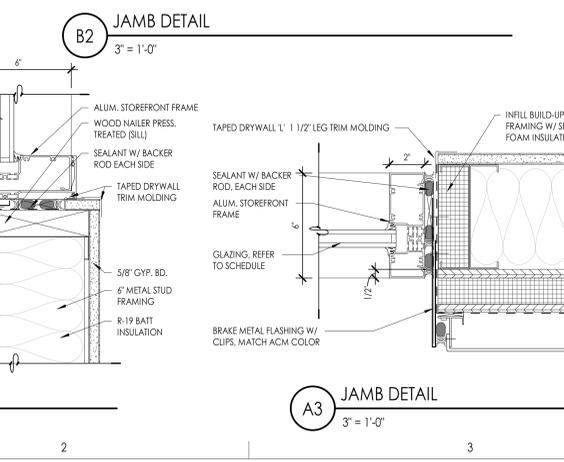
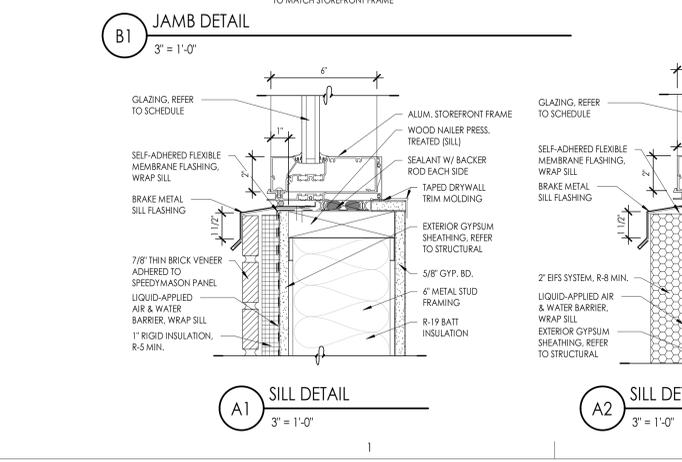
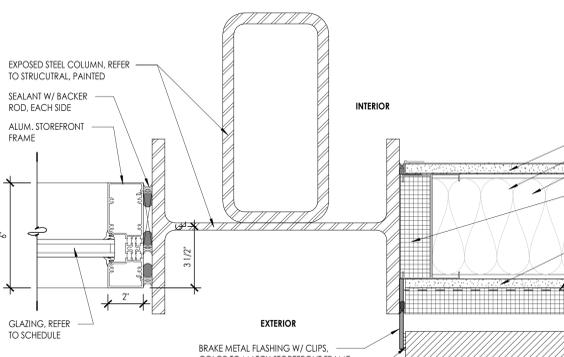
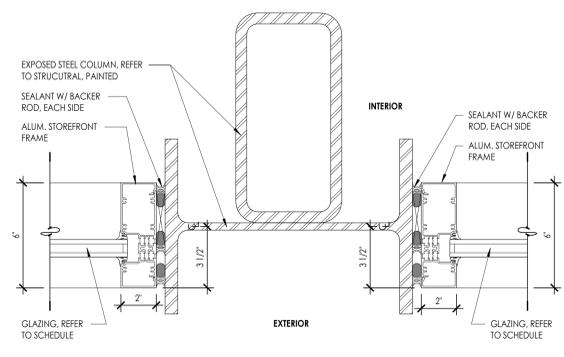
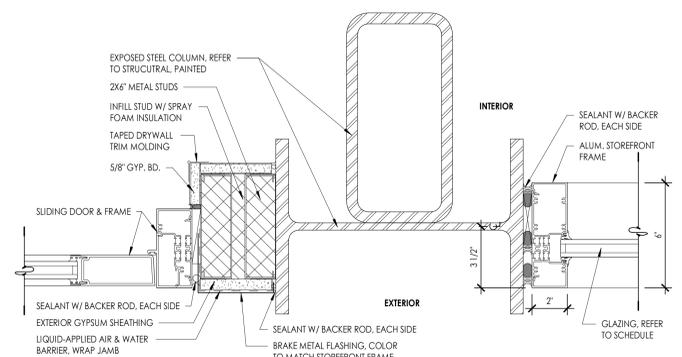
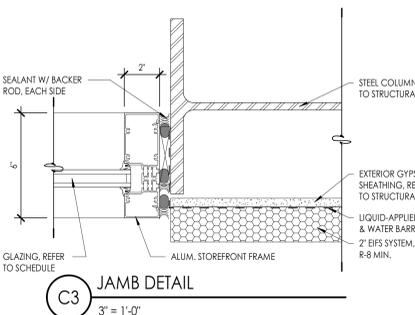
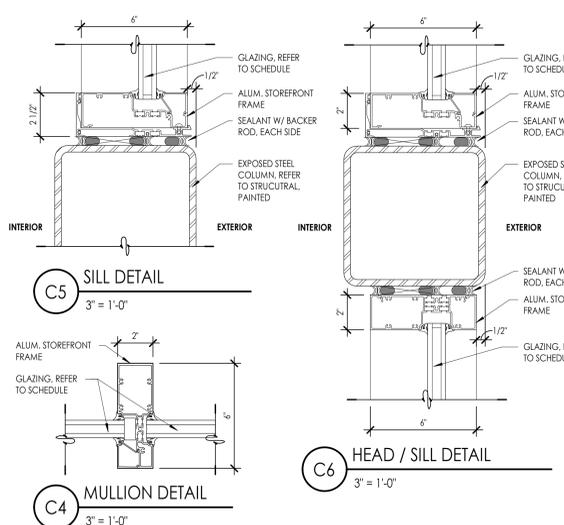
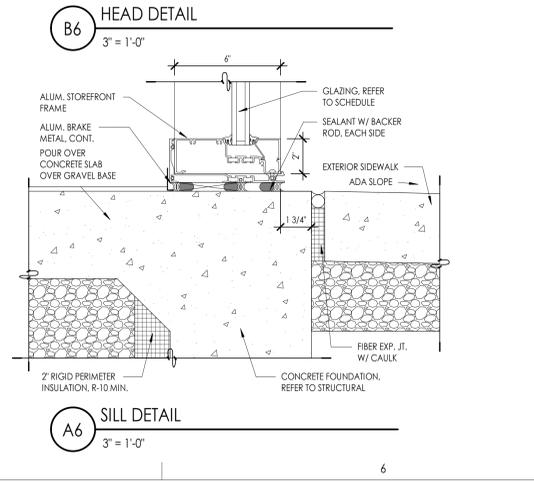
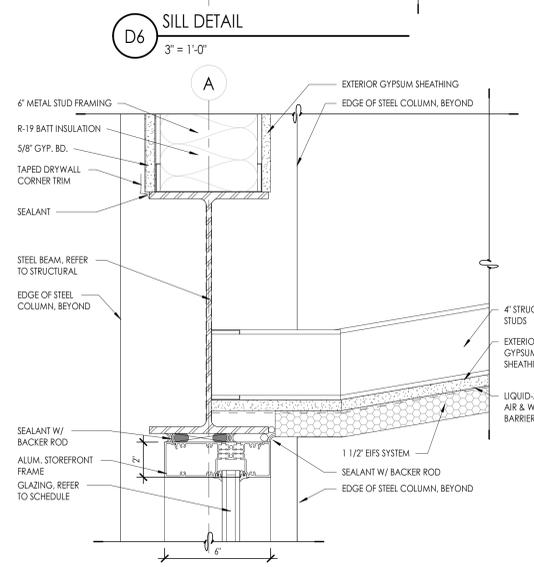
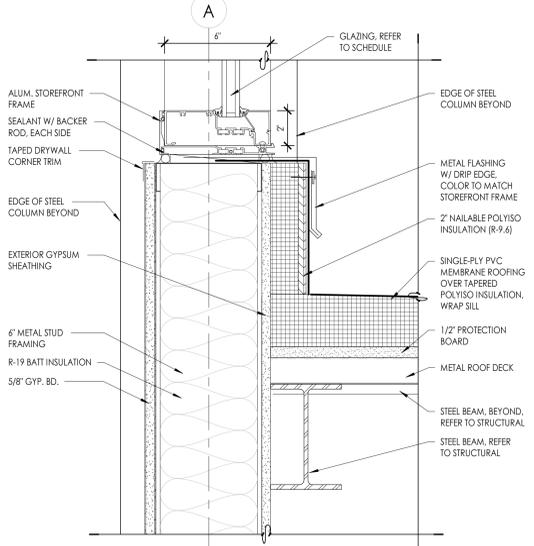
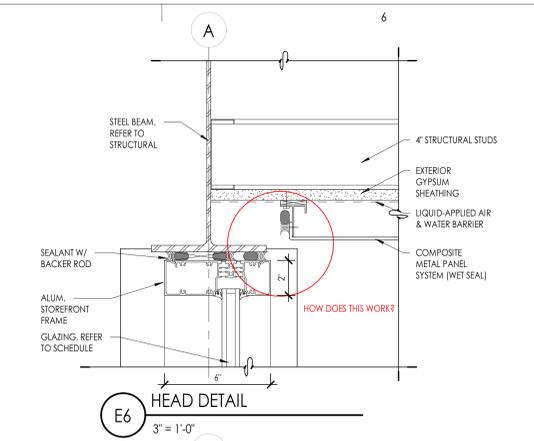
Project Name



Issued	No.	Date	Description
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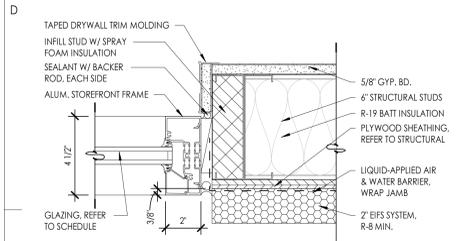
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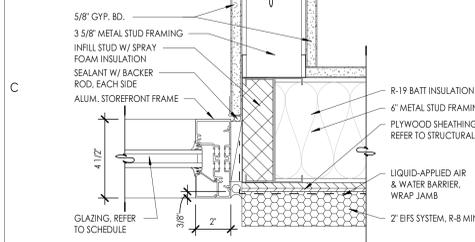





E1 JAMB DETAIL
3" = 1'-0"




D1 JAMB DETAIL
3" = 1'-0"

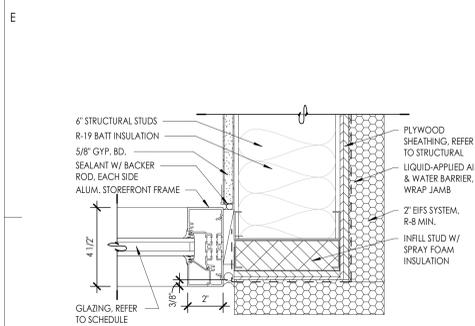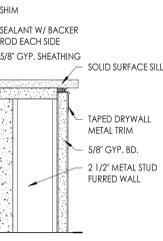


C1 JAMB DETAIL
3" = 1'-0"

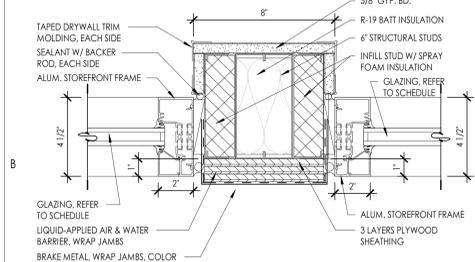


B1 JAMB DETAIL
3" = 1'-0"

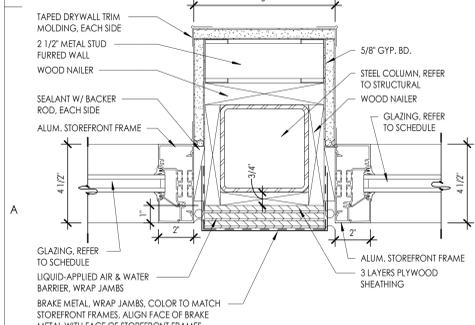


A1 JAMB DETAIL
3" = 1'-0"

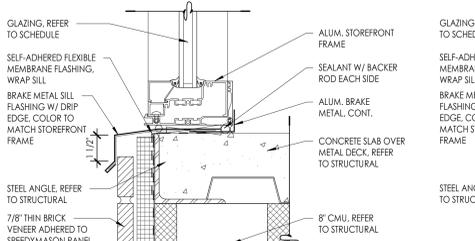


D2 SILL DETAIL
3" = 1'-0"

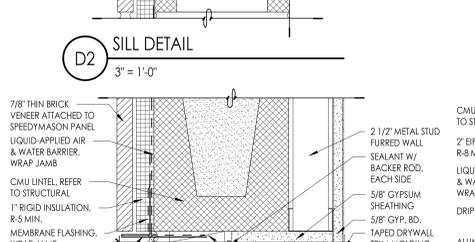


C2 HEAD DETAIL
3" = 1'-0"

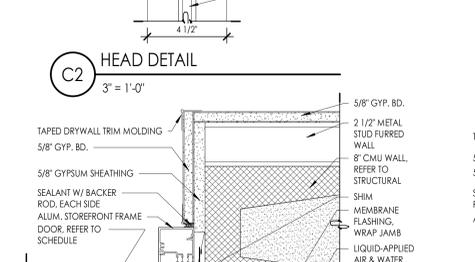


B2 JAMB DETAIL
3" = 1'-0"

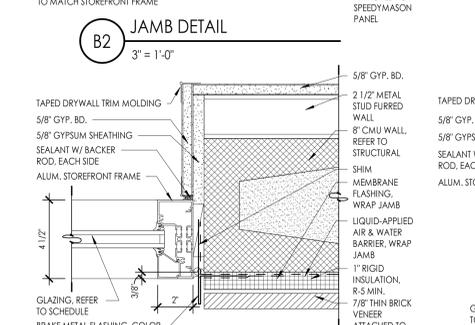


A2 JAMB DETAIL
3" = 1'-0"

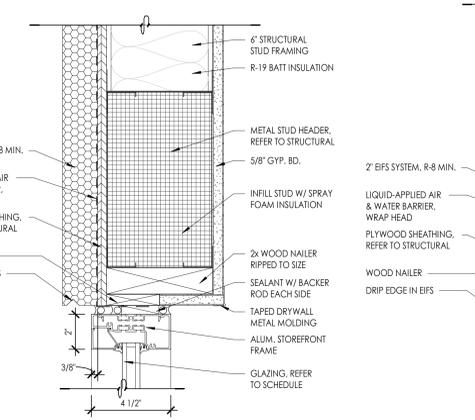


E3 HEAD DETAIL
3" = 1'-0"

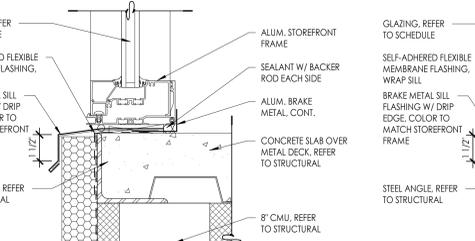


D3 SILL DETAIL
3" = 1'-0"

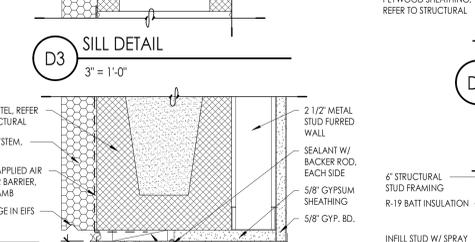


C3 HEAD DETAIL
3" = 1'-0"

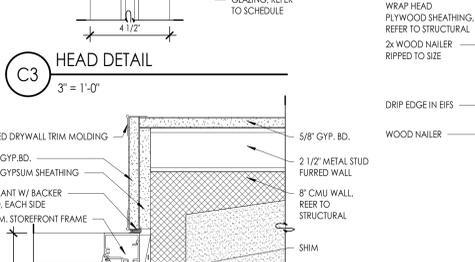


B3 JAMB DETAIL
3" = 1'-0"

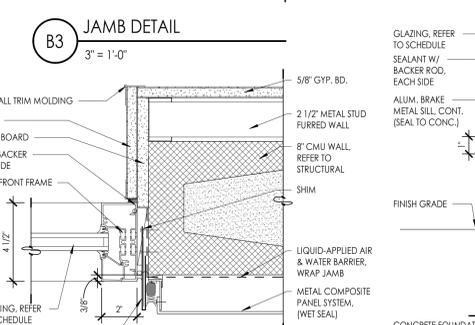


A3 JAMB DETAIL
3" = 1'-0"

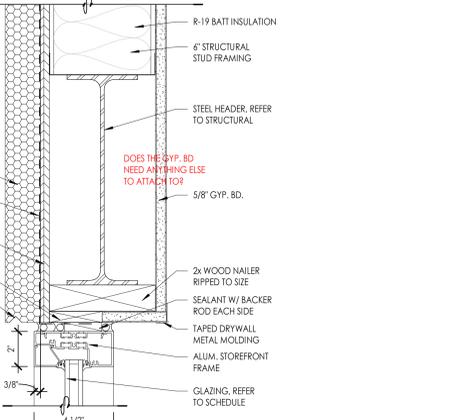


E4 HEAD DETAIL
3" = 1'-0"

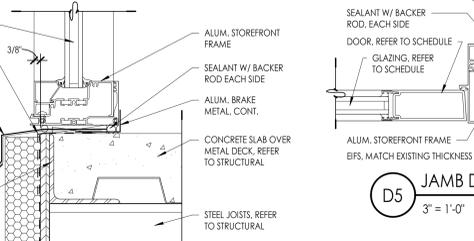


D4 SILL DETAIL
3" = 1'-0"

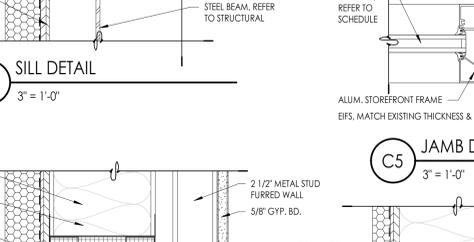


C4 HEAD DETAIL
3" = 1'-0"

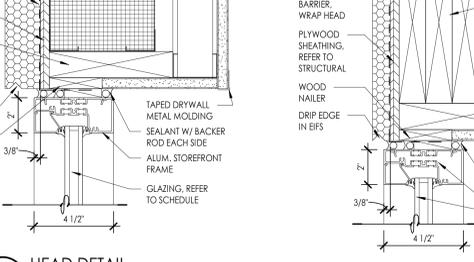


B4 HEAD DETAIL
3" = 1'-0"

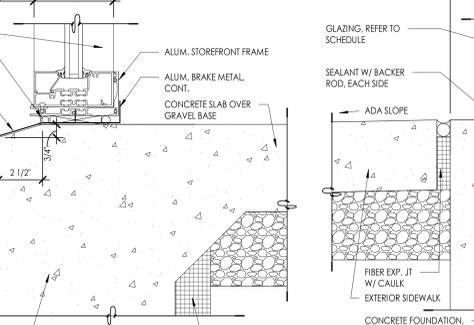


A4 SILL DETAIL
3" = 1'-0"

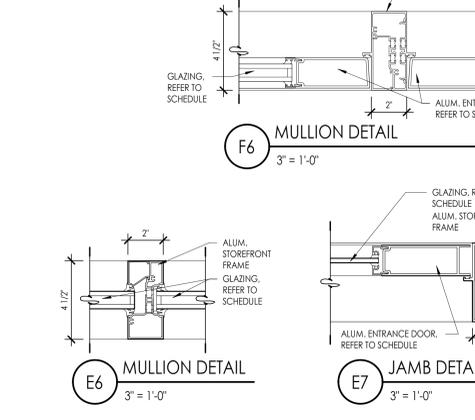


F6 MULLION DETAIL
3" = 1'-0"

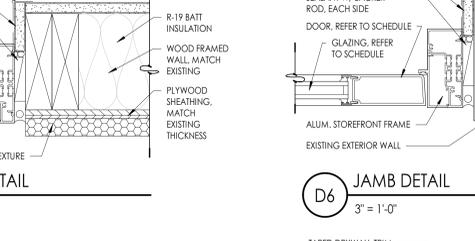


E6 MULLION DETAIL
3" = 1'-0"

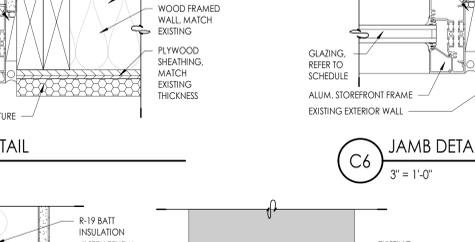


D5 JAMB DETAIL
3" = 1'-0"

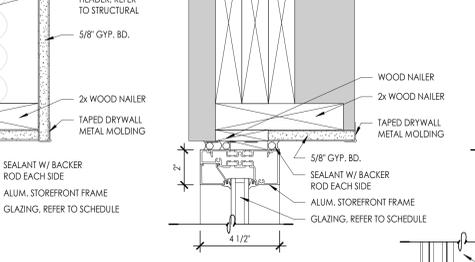


C5 JAMB DETAIL
3" = 1'-0"

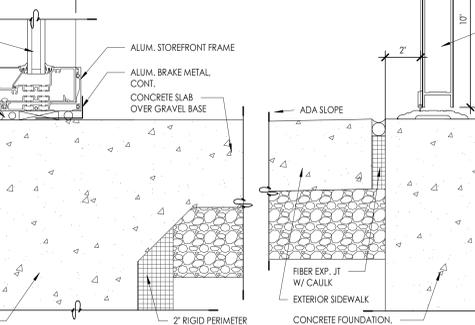


A5 SILL DETAIL
3" = 1'-0"

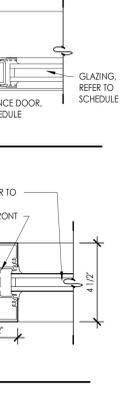


E7 JAMB DETAIL
3" = 1'-0"

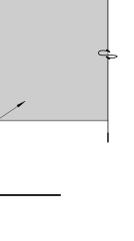

D6 JAMB DETAIL
3" = 1'-0"

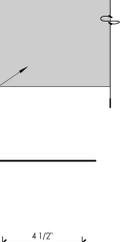


C6 JAMB DETAIL
3" = 1'-0"

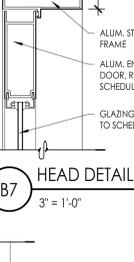

B7 HEAD DETAIL
3" = 1'-0"



A6 SILL DETAIL
3" = 1'-0"

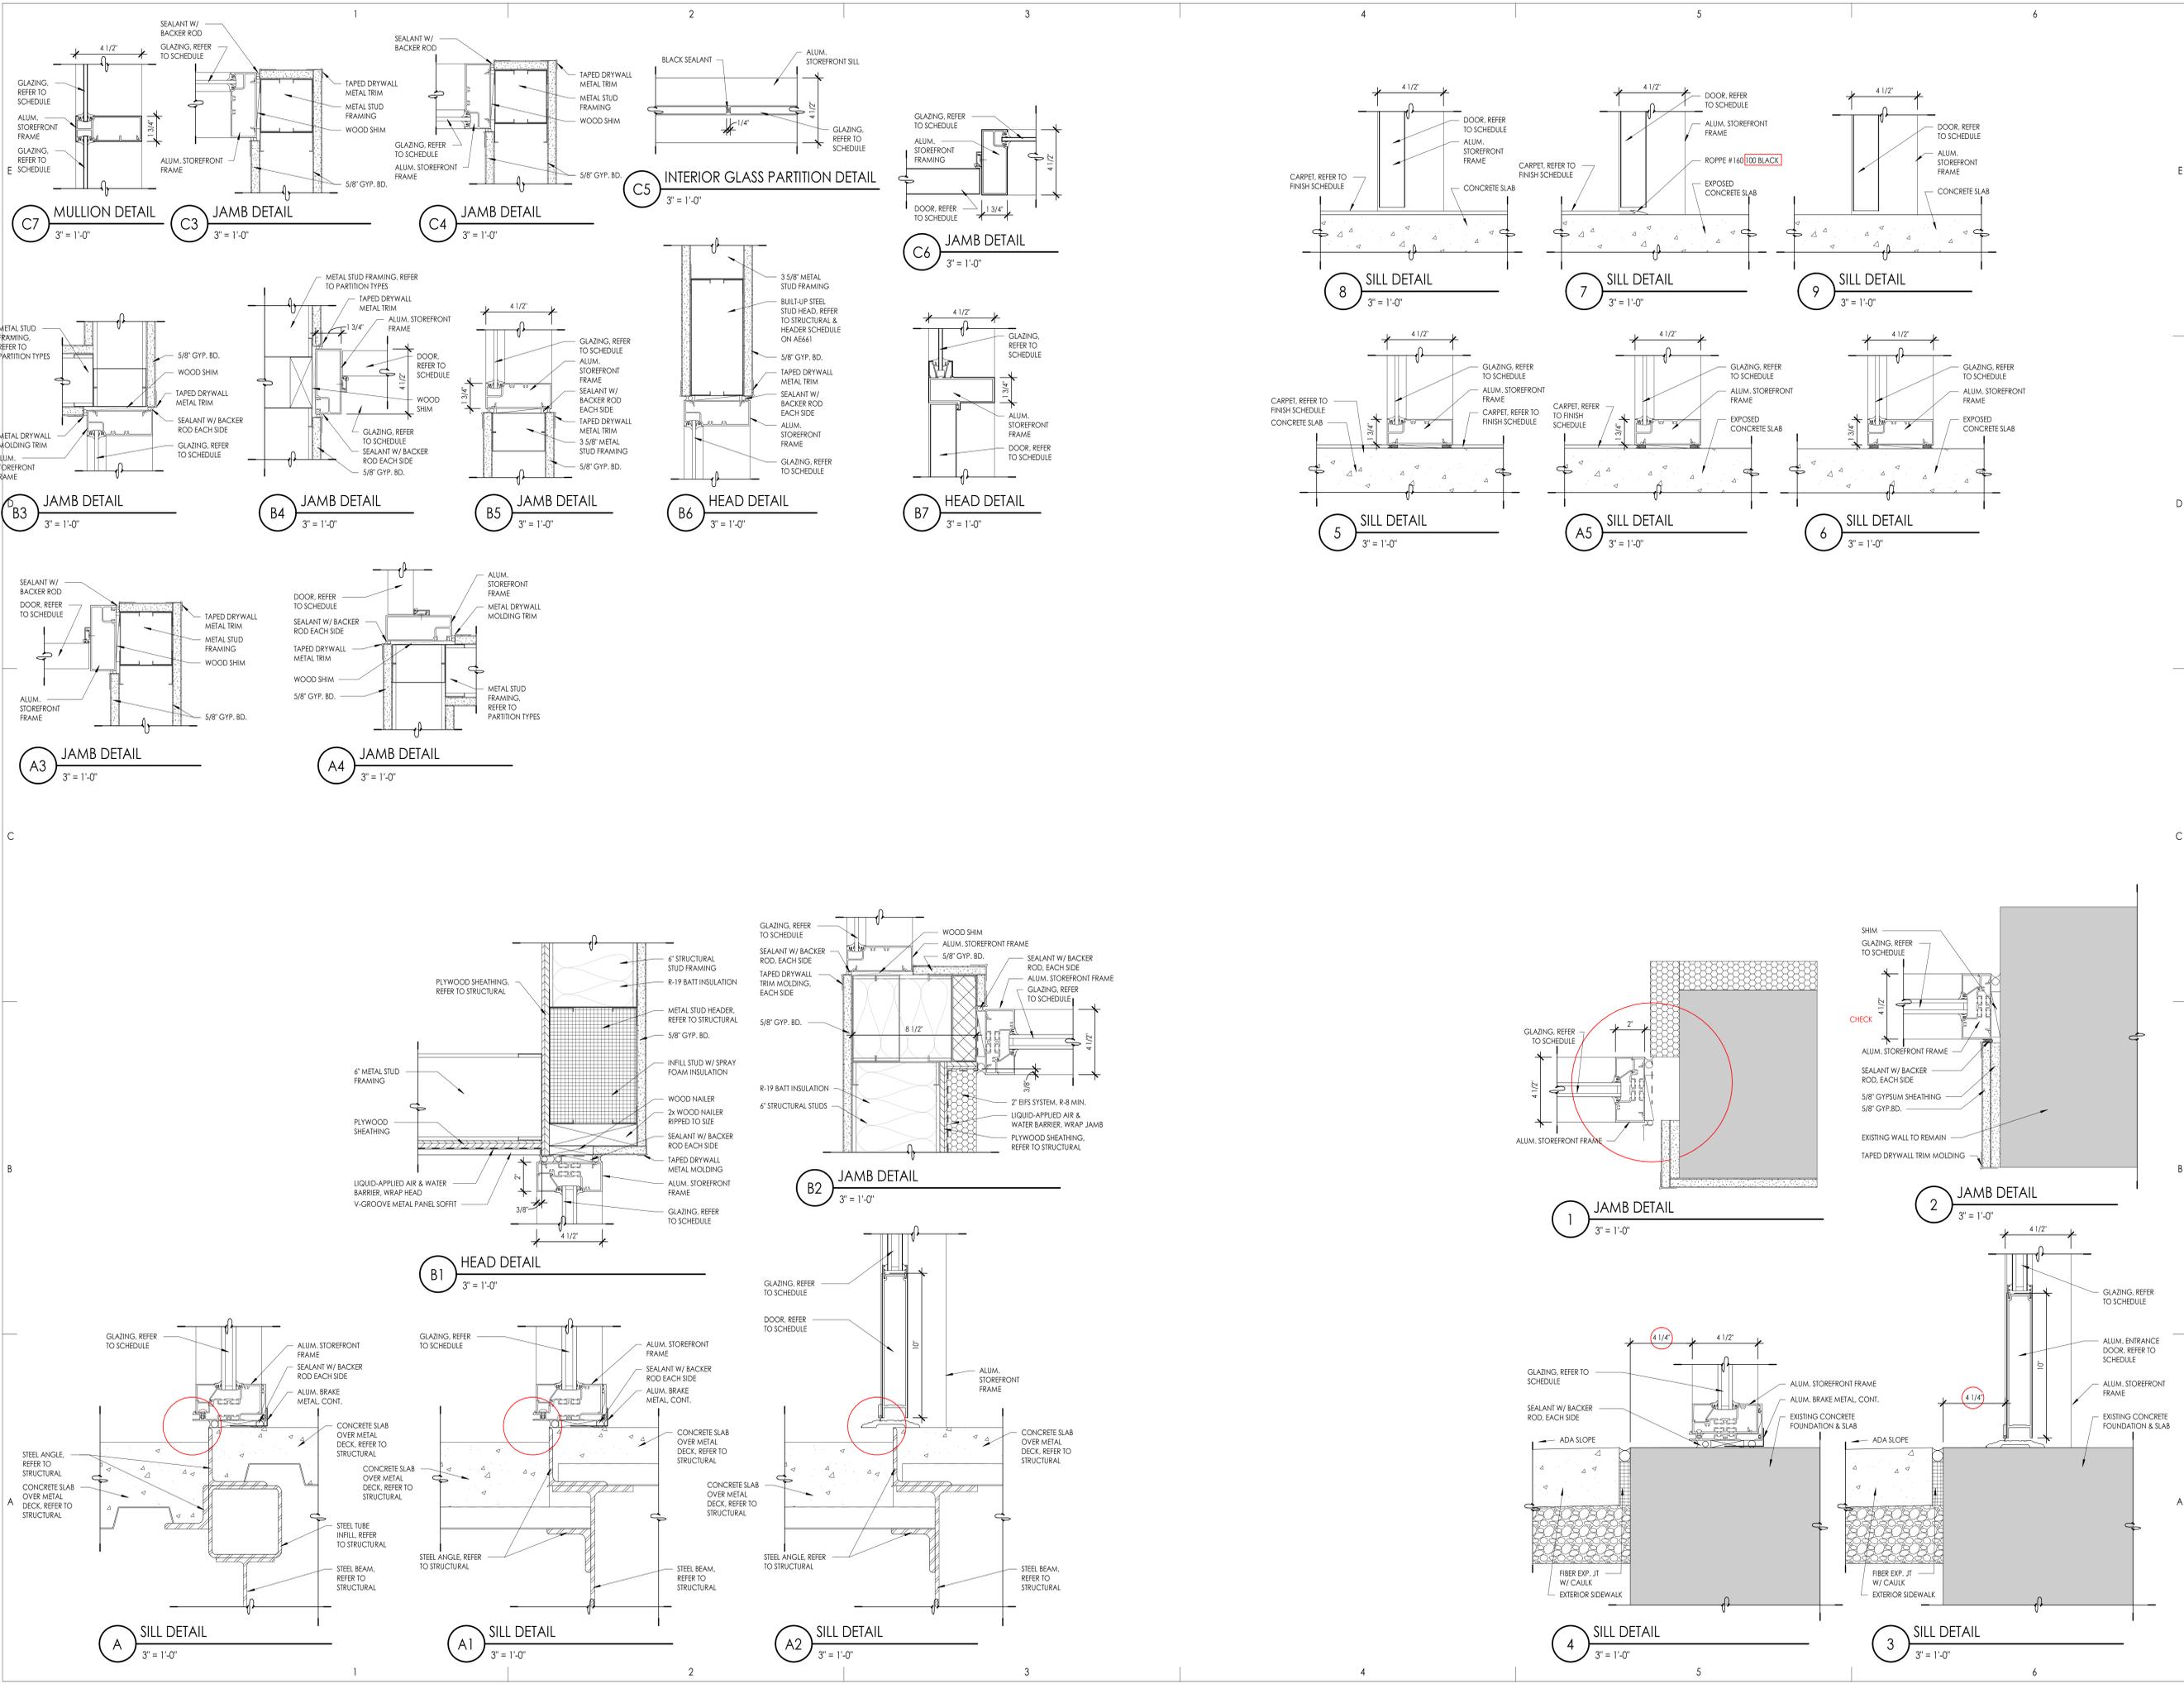

Project Name

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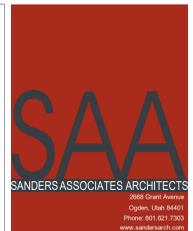
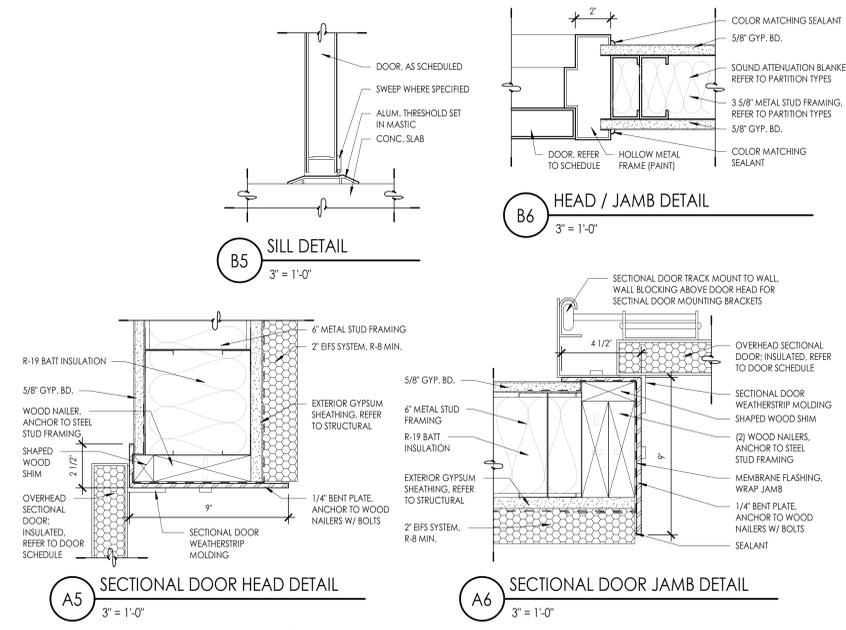
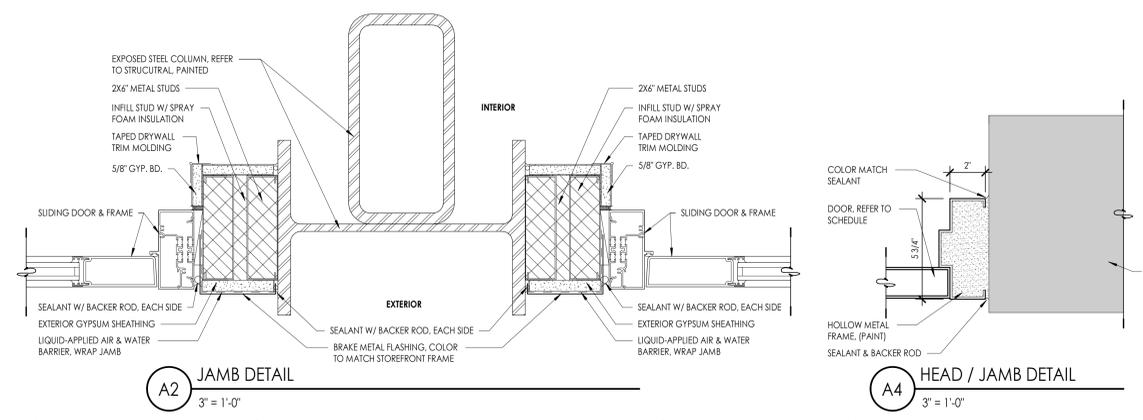
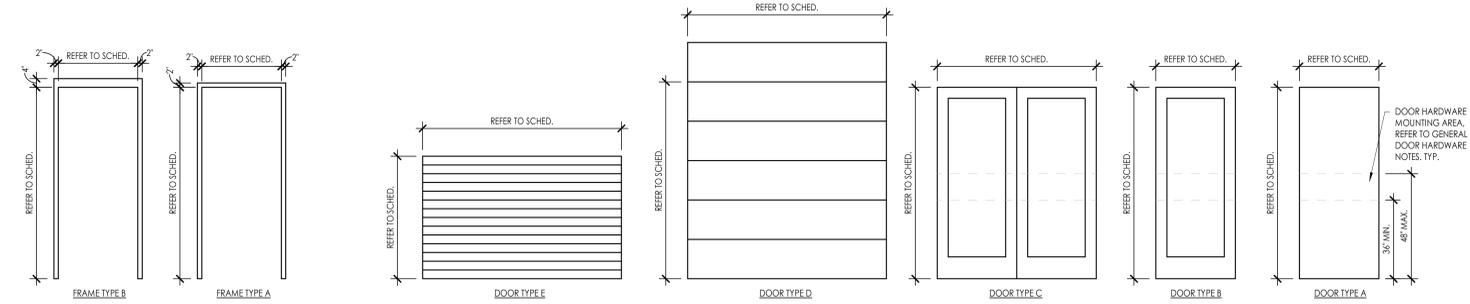
SAA Project No. 2021-10
 Drawing Title

DOOR SCHEDULE - EXISTING DOORS																
DOOR #	ROOM NAME	DOOR						FRAME				HROW/ GROUP	FIRE RATING	COMMENTS	DOOR #	
		DOOR TYPE	WIDTH	HEIGHT	THICK	MTRL	FINSH	GLAZE	FRAME TYPE	MTRL	FINSH					HEAD DETAIL
E-108H	TSA STACKING	A	2'-0"	7'-0"	1 3/4"	EXIST. WD.	-	-	EXIST. WD.	-	EXIST.	EXIST.	EXIST.	-	EXIST. CABINET DBL. DOORS	E-108H
E-115A	TSA SUPERVISOR	A	3'-0"	7'-0"	1 3/4"	EXIST. WD.	-	-	EXIST. H.M.	-	EXIST.	EXIST.	-	CARD READER	E-115A	
E-116A	BAGGAGE SCREENING	A	3'-0"	7'-0"	1 3/4"	EXIST. H.M.	PNT-3	-	EXIST. H.M.	PNT-3	EXIST.	EXIST.	-	CARD READER EACH SIDE	E-116A	
E-124A	DINING ROOM	B	3'-4"	7'-1"	2 1/4"	EXIST. ALUM.	-	EXIST.	EXIST. ALUM.	-	EXIST.	EXIST.	-	CARD READER EACH SIDE, CHEMIST DEVICE, ELECTRIC KEYPAD	E-124A	
E-129A	KITCHEN STORAGE	A	3'-0"	7'-0"	1 3/4"	EXIST. H.M.	-	-	EXIST. H.M.	-	EXIST.	EXIST.	-	ELECTRIC KEYPAD	E-129A	
E-129A-A	EXIT	A	2'-8"	6'-8"	1 3/4"	EXIST. H.M.	-	-	EXIST. H.M.	-	EXIST.	EXIST.	-	EXIST. DOOR TO ROOF	E-129A-A	

DOOR SCHEDULE - NEW DOORS																	
DOOR #	ROOM NAME	DOOR						FRAME				HROW/ GROUP	FIRE RATING	COMMENTS	DOOR #		
		DOOR TYPE	WIDTH	HEIGHT	THICK	MTRL	FINSH	GLAZE	FRAME TYPE	MTRL	FINSH					HEAD DETAIL	JAMB DETAIL
XE-812D	BAGGAGE DROP-OFF	A	3'-0"	7'-0"	1 3/4"	-	-	-	A	HM	PNT-3	B6/AE601	B6/AE601	-	-	XE-812D	
XE-812E	BAGGAGE DROP-OFF	A	3'-0"	7'-0"	1 3/4"	-	-	-	A	HM	PNT-3	B6/AE601	B6/AE601	-	-	XE-812E	
BASEMENT																	
B100A	ENTRY	A	3'-0"	7'-0"	1 3/4"	WD	-	-	A	HM	PNT-3	B6/AE601	B6/AE601	-	CARD READER	60 MIN.	B100A
B102A	MEN	A	3'-0"	7'-0"	1 3/4"	WD	-	-	A	HM	PNT-3	B6/AE601	B6/AE601	-	-	-	B102A
B103A	WOMEN	A	3'-0"	7'-0"	1 3/4"	WD	-	-	A	HM	PNT-3	B6/AE601	B6/AE601	-	-	-	B103A
B109A	HALL	A	3'-0"	7'-0"	1 3/4"	HM	-	-	A	HM	PNT-3	B6/AE601	B6/AE601	-	CARD READER	-	B109A
B109A	REFRESH	A	3'-0"	7'-0"	1 3/4"	WD	-	-	A	HM	PNT-3	B6/AE601	B6/AE601	-	-	-	B109A
B110A	EXISTING UTILITY	A	3'-0"	7'-0"	1 3/4"	HM	-	-	A	HM	PNT-3	B6/AE601	B6/AE601	-	-	-	B110A
B111A	HALL	A	3'-0"	7'-0"	1 3/4"	WD	-	-	A	HM	PNT-3	B6/AE601	B6/AE601	-	CARD READER	60 MIN.	B111A
B112A	STORAGE	A	3'-0"	7'-0"	1 3/4"	HM	-	-	A	HM	PNT-3	B6/AE601	B6/AE601	-	-	-	B112A
B113A	STORAGE	A	3'-0"	6'-8"	1 3/4"	HM	-	-	A	HM	PNT-3	B6/AE601	B6/AE601	-	-	-	B113A
B115A	HALL	A	2'-8"	7'-0"	1 3/4"	HM	-	-	A	HM	PNT-3	B6/AE601	B6/AE601	-	-	-	B115A
B119A	EXISTING FAN ROOM	A	3'-0"	7'-0"	1 3/4"	HM	-	-	A	HM	PNT-3	B6/AE601	B6/AE601	-	CARD READER	-	B119A
B120A	EXISTING ELECTRICAL	A	3'-0"	6'-6"	1 3/4"	HM	-	-	A	HM	PNT-3	B6/AE601	B6/AE601	-	CARD READER	-	B120A
B121A	EXISTING JANITOR	A	2'-8"	7'-0"	1 3/4"	HM	-	-	A	HM	PNT-3	B6/AE601	B6/AE601	-	-	60 MIN.	B121A
LEVEL 1																	
101A	FIRE TRUCK BAY	A	3'-0"	7'-0"	1 3/4"	HM	PNT-3	-	A	HM	PNT-3	B6/AE601	B6/AE601	-	CARD READER	-	101A
101A-A	ELEC.	A	3'-0"	7'-0"	1 3/4"	HM	PNT-3	-	A	HM	PNT-3	B6/AE601	B6/AE601	-	-	-	101A-A
101B	FIRE TRUCK BAY	A	3'-0"	7'-0"	1 3/4"	HM	PNT-3	-	A	HM	PNT-3	B6/AE601	B6/AE601	-	CARD READER	-	101B
101C	FIRE TRUCK BAY	D	13'-10"	15'-10"	1 1/2"	-	-	-	MANUF.	-	-	AS/AE601	A6/AE601	-	-	-	101C
102A	TERMINAL WAITING	B	3'-6"	7'-0"	1 3/4"	ALUM.	DK BRNZ.	GL-2	W29	ALUM.	DK BRNZ.	-	-	-	-	-	102A
102B	TERMINAL WAITING	B	3'-6"	7'-0"	1 3/4"	ALUM.	DK BRNZ.	GL-2	W29	ALUM.	DK BRNZ.	-	-	-	C.R. EA. SIDE	-	102B
102C	TERMINAL WAITING	B	3'-6"	7'-0"	1 3/4"	ALUM.	DK BRNZ.	GL-2	W28	ALUM.	DK BRNZ.	-	-	-	C.R. EA. SIDE	-	102C
102D	TERMINAL WAITING	B	3'-6"	7'-0"	1 3/4"	ALUM.	DK BRNZ.	GL-2	W28	ALUM.	DK BRNZ.	-	-	-	C.R. EA. SIDE	-	102D
102E	TERMINAL WAITING	B	3'-6"	7'-0"	1 3/4"	ALUM.	DK BRNZ.	GL-2	W15	ALUM.	DK BRNZ.	-	-	-	C.R. EA. SIDE	-	102E
105A	JANITOR	A	3'-0"	7'-0"	1 3/4"	WD	-	-	A	HM	PNT-3	B6/AE601	B6/AE601	-	-	-	105A
108A	TSA INSPECTION	A	35'-2 1/2"	10'-0"	-	-	-	-	MANUF.	-	-	-	-	-	-	-	108A
108B	TSA INSPECTION	A	35'-2 1/2"	10'-0"	-	-	-	-	MANUF.	-	-	-	-	-	-	-	108B
109A	PRIVATE SEARCH	A	3'-0"	7'-0"	1 3/4"	WD	-	-	A	HM	PNT-3	B6/AE601	B6/AE601	-	CARD READER	-	109A
110A	STORAGE	A	3'-0"	7'-0"	1 3/4"	WD	-	-	A	HM	PNT-3	B6/AE601	B6/AE601	-	CARD READER	-	110A
114A	ELEC.	A	3'-0"	7'-0"	1 3/4"	WD	-	-	A	HM	PNT-3	B6/AE601	B6/AE601	-	-	-	114A
116A	BAGGAGE SCREENING	A	3'-0"	7'-0"	1 3/4"	WD	-	-	A	HM	PNT-3	B6/AE601	B6/AE601	-	YES	-	116A
116C	BAGGAGE SCREENING	D	8'-0"	8'-0"	1 1/2"	-	-	-	MANUF.	-	-	AS/AE601	A6/AE601	-	-	-	116C
117A	TSA BREAK ROOM	A	3'-0"	7'-0"	1 3/4"	WD	-	-	A	HM	PNT-3	B6/AE601	B6/AE601	-	YES	-	117A
119A	MEN	A	3'-0"	7'-0"	1 3/4"	WD	-	-	A	HM	PNT-3	B6/AE601	B6/AE601	-	-	-	119A
120A	WOMEN	A	3'-0"	7'-0"	1 3/4"	WD	-	-	A	HM	PNT-3	B6/AE601	B6/AE601	-	-	-	120A
121A	LOBBY	B	3'-6"	7'-0"	1 3/4"	ALUM.	DK BRNZ.	GL-2	W27	ALUM.	DK BRNZ.	-	-	-	CARD READER	-	121A
128A	LOBBY	A	3'-0"	7'-0"	1 3/4"	WD	-	-	A	HM	PNT-3	B6/AE601	B6/AE601	-	-	-	128A
129A	EXIT	A	3'-0"	7'-0"	1 3/4"	WD	-	-	A	HM	PNT-3	B6/AE601	B6/AE601	-	-	60 MIN.	129A
130A	LOBBY	A	3'-0"	7'-0"	1 3/4"	WD	-	-	A	HM	PNT-3	B6/AE601	B6/AE601	-	-	-	130A
131A	FAMILY RESTROOM	A	3'-0"	7'-0"	1 3/4"	WD	-	-	A	HM	PNT-3	B6/AE601	B6/AE601	-	-	-	131A
134A	BAGGAGE DROP-OFF	A	3'-0"	7'-0"	1 3/4"	HM	PNT-3	-	A	HM	PNT-3	B6/AE601	B6/AE601	-	-	-	134A
134B	BAGGAGE DROP-OFF	D	8'-0"	8'-0"	1 1/2"	-	-	-	MANUF.	-	-	AS/AE601	A6/AE601	-	-	-	134B
134C	BAGGAGE DROP-OFF	D	8'-0"	8'-0"	1 1/2"	-	-	-	MANUF.	-	-	AS/AE601	A6/AE601	-	-	-	134C
134D	BAGGAGE DROP-OFF	E	8'-0"	4'-0"	1 1/2"	-	-	-	MANUF.	-	-	AS/AE601	A6/AE601	-	-	-	134D
135A	BAGGAGE OFFICE	A	3'-0"	7'-0"	1 3/4"	WD	-	-	A	HM	PNT-3	B6/AE601	B6/AE601	-	-	-	135A
135B	BAGGAGE OFFICE	A	3'-0"	7'-0"	1 3/4"	WD	-	-	A	HM	PNT-3	B6/AE601	B6/AE601	-	-	-	135B
140A	LOBBY	A	13'-8 1/2"	7'-0"	1 3/4"	ALUM.	DK BRNZ.	GL-2	MANUF.	ALUM.	DK BRNZ.	-	-	-	-	-	140A
140B	LOBBY	A	13'-8 1/2"	7'-0"	1 3/4"	ALUM.	DK BRNZ.	GL-2	MANUF.	ALUM.	DK BRNZ.	-	-	-	-	-	140B
142A	RENTAL OFFICE	A	3'-0"	7'-0"	1 3/4"	WD	-	-	A	HM	PNT-3	B6/AE601	B6/AE601	-	-	-	142A
143A	RENTAL OFFICE	A	3'-0"	7'-0"	1 3/4"	WD	-	-	A	HM	PNT-3	B6/AE601	B6/AE601	-	-	-	143A
144A	RENTAL OFFICE	A	3'-0"	7'-0"	1 3/4"	WD	-	-	A	HM	PNT-3	B6/AE601	B6/AE601	-	-	-	144A
LEVEL 2																	
202A	HALL	A	3'-0"	7'-0"	1 3/4"	ALUM.	DK BRNZ.	GL-4	W30	ALUM.	DK BRNZ.	-	-	YES	-	-	202A
204A	MEN	A	3'-0"	7'-0"	1 3/4"	WD	-	-	A	HM	PNT-3	B6/AE601	B6/AE601	-	-	-	204A
205A	WOMEN	A	3'-0"	7'-0"	1 3/4"	WD	-	-	A	HM	PNT-3	B6/AE601	B6/AE601	-	-	-	205A
206A	JANITOR / STORAGE	A	3'-0"	7'-0"	1 3/4"	WD	-	-	A	HM	PNT-3	B6/AE601	B6/AE601	-	-	-	206A
207A	BAGGING	A	3'-0"	7'-0"	1 3/4"	WD	-	-	A	HM	PNT-3	B6/AE601	B6/AE601	-	-	-	207A
208A	WORKROOM	A	3'-0"	7'-0"	1 3/4"	WD	-	-	A	HM	PNT-3	B6/AE601	B6/AE601	-	-	-	208A
209A	MANAGER OFFICE	A	3'-0"	7'-0"	1 3/4"	WD	-	-	W31	ALUM.	DK BRNZ.	-	-	-	-	-	209A
211A	EXTERIOR PATIO	B	3'-0"	7'-0"	1 3/4"	ALUM.	DK BRNZ.	GL-2	W21	ALUM.	DK BRNZ.	-	-	YES	-	-	211A
214A	CONFERENCE	A	3'-0"	7'-0"	1 3/4"	WD	DK BRNZ.	-	W32	ALUM.	DK BRNZ.	-	-	-	-	-	214A

- GENERAL DOOR HARDWARE NOTES**
- ALL LOCKS, DOOR HANDLES, PULLS, LATCHES, OR OTHER OPERATING HARDWARE IS REQUIRED TO BE LOCATED BETWEEN 36 AND 48 INCHES A.F.F. PER IBC 1010.1.9.2.
 - HARDWARE SHALL NOT REQUIRE PINCHING, TIGHT GRASPING, OR TWISTING OF THE WRIST TO OPERATE PER IBC 1010.1.9.1.

PANEL SCHEDULE		
MARK	GLASS TYPE	COMMENTS
GL-1	1" INSUL - LOW E - TINTED	SEE SPECIFICATIONS
GL-2	1" INSUL - LOW E - TINTED - TEMPERED	SEE SPECIFICATIONS
GL-4	1/4" CLEAR	SEE SPECIFICATIONS
GL-5	1/2" CLEAR - TEMPERED	SEE SPECIFICATIONS



General Contractor

STACEY CONSTRUCTION
Stacey Construction
Construction Manager
General Contractor
376B Pacific Ave.
Ogden, UT 84405
801.621.6210
www.staceycg.com

Consultant

Project Name
OGDEN-HINCKLEY AIRPORT
TERMINAL EXPANSION
3909 AIRPORT ROAD
OGDEN, UT 84405


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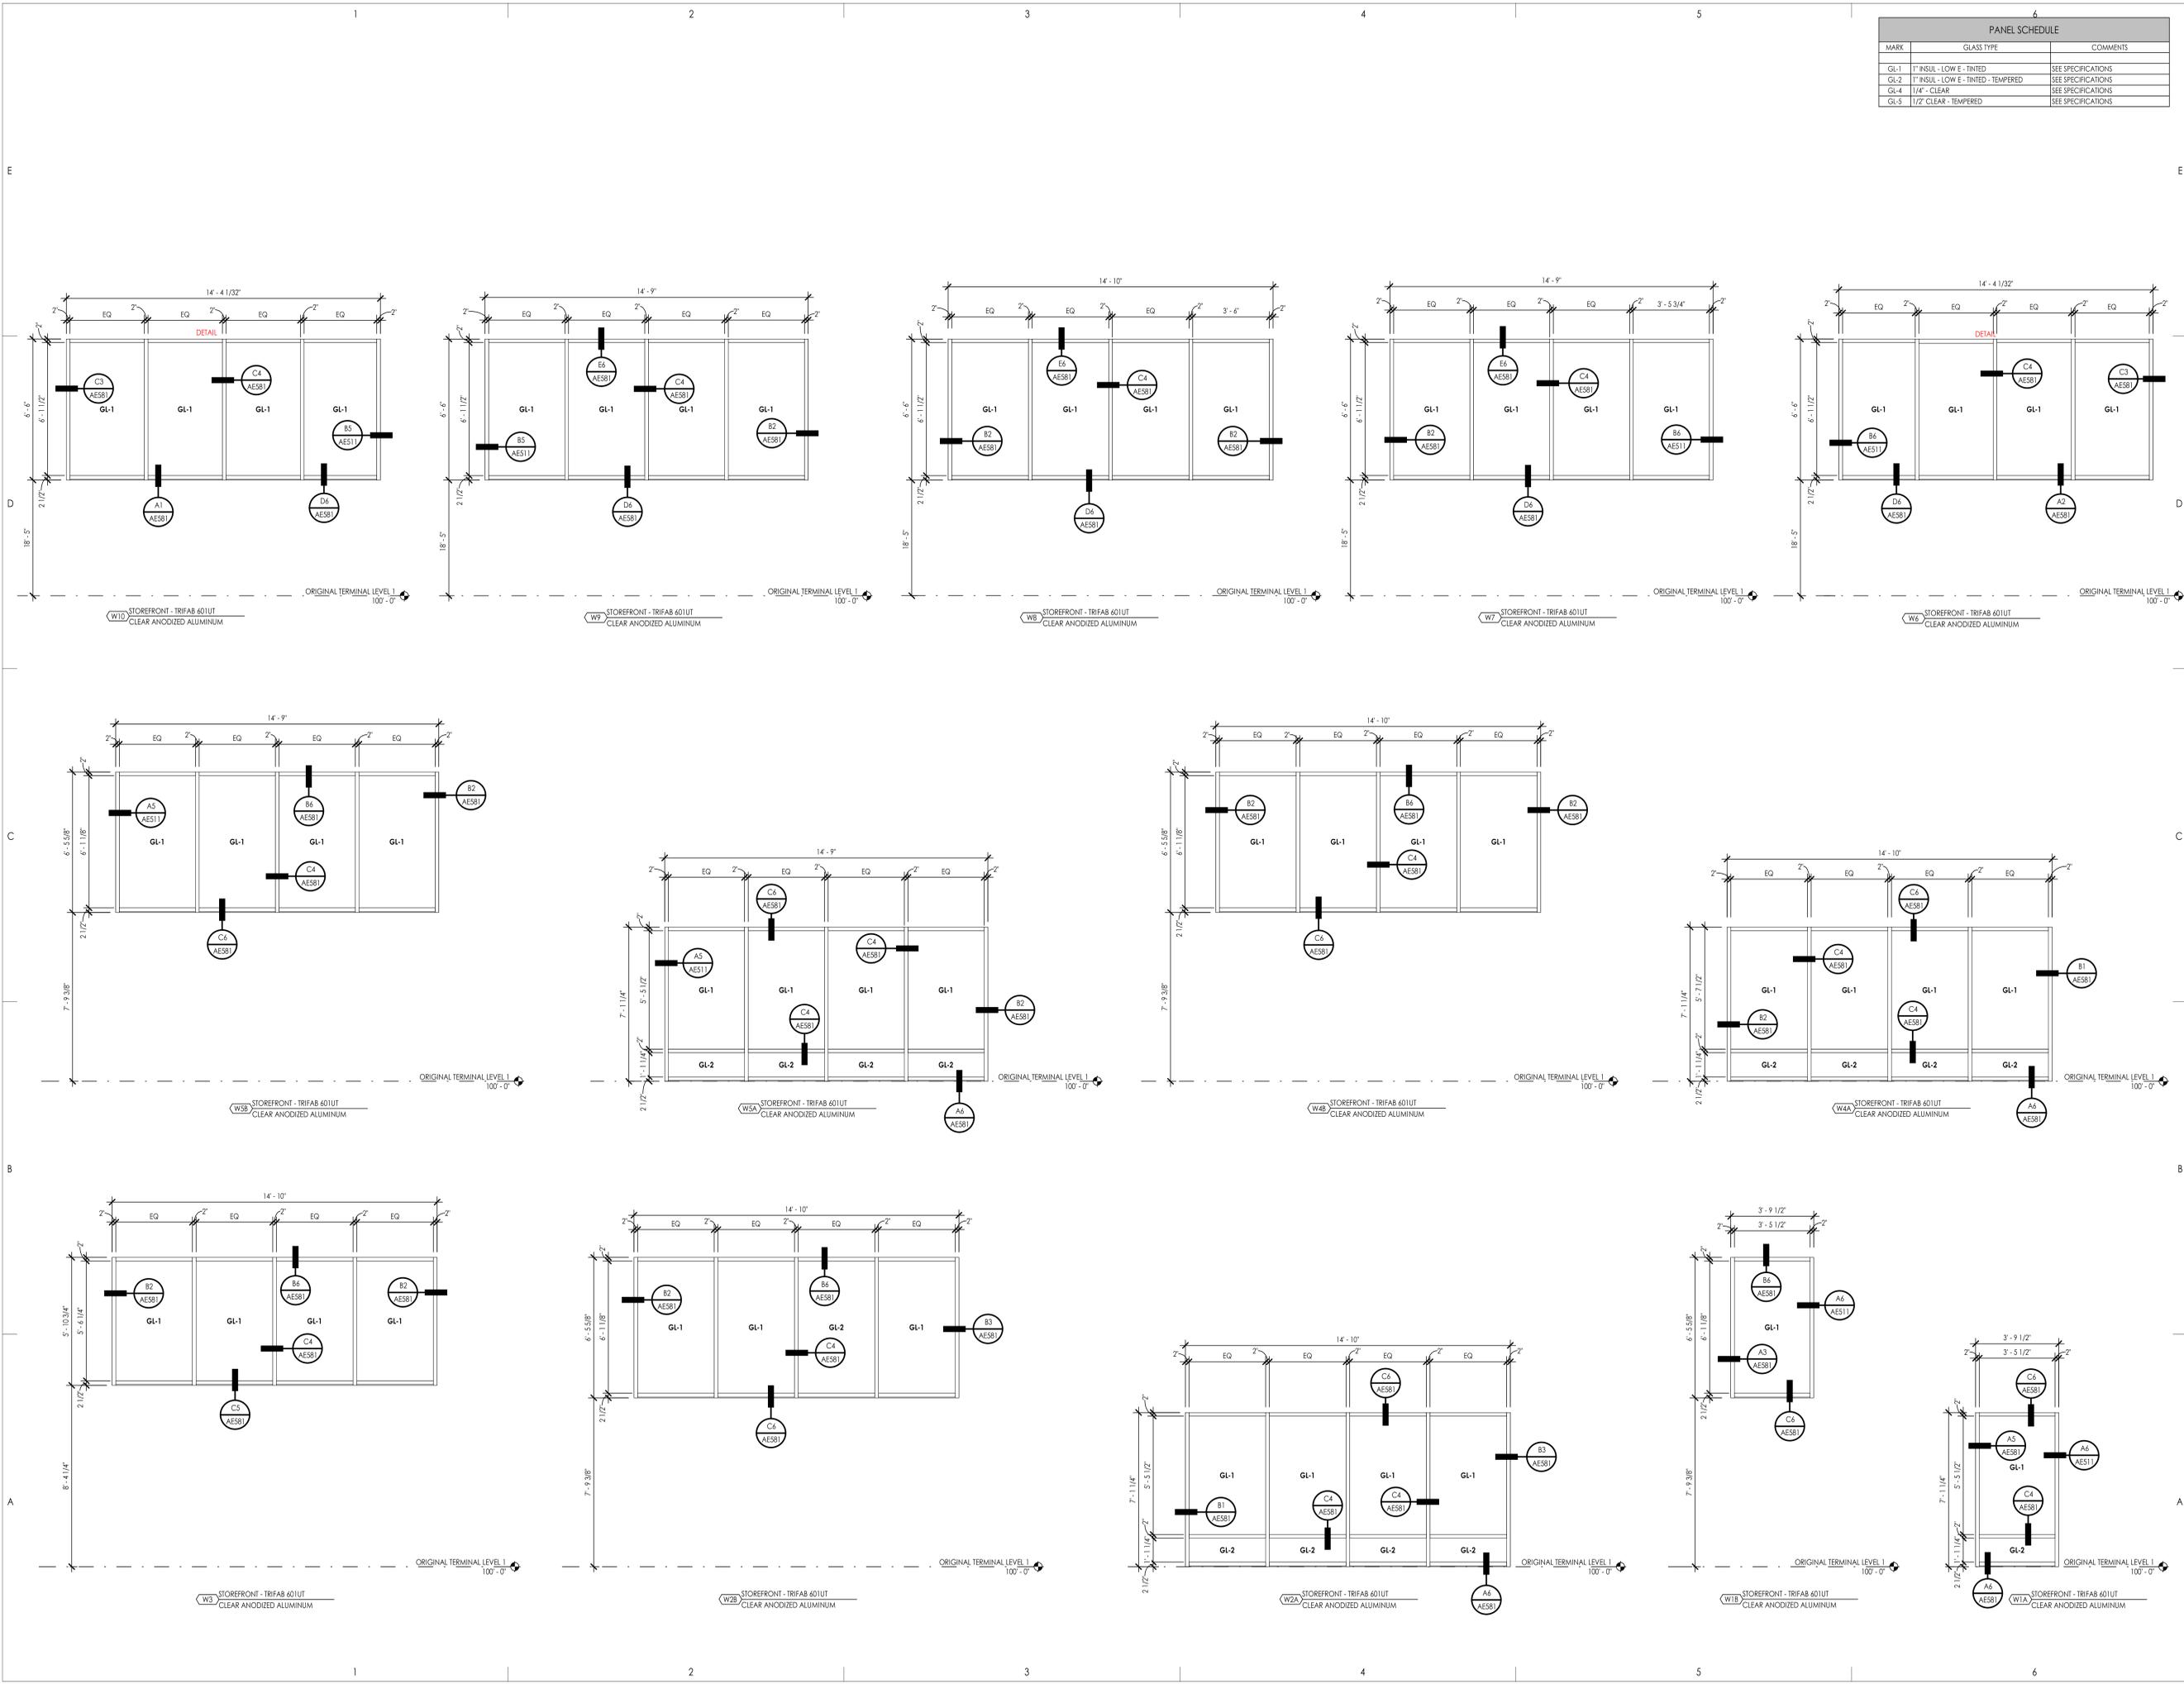
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No.	Date	Description
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PANEL SCHEDULE		
MARK	GLASS TYPE	COMMENTS
GL-1	1" INSUL - LOW E - TINTED	SEE SPECIFICATIONS
GL-2	1" INSUL - LOW E - TINTED - TEMPERED	SEE SPECIFICATIONS
GL-4	1/4" - CLEAR	SEE SPECIFICATIONS
GL-5	1/2" CLEAR - TEMPERED	SEE SPECIFICATIONS



General Contractor
STACEY CONSTRUCTION
 Stacey Construction
 Construction Manager
 General Contractor
 3768 Pacific Ave.
 Ogden, UT 84405
 801.621.6210
 www.staceygc.com
 Consultant



Project Name
OGDEN-HINCKLEY AIRPORT
TERMINAL EXPANSION
 3909 AIRPORT ROAD
 OGDEN, UT 84405
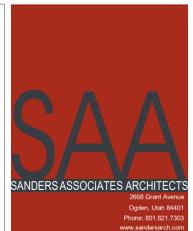
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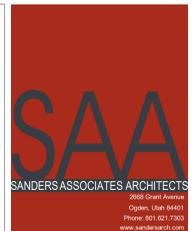
Revision		
No.	Date	Description

SAA Project No. 2021-10
 Drawing Title

FRAME TYPES
 Sheet Number


AE621

PANEL SCHEDULE		
MARK	GLASS TYPE	COMMENTS
GL-1	1" INSUL. LOW E. TINTED	SEE SPECIFICATIONS
GL-2	1" INSUL. LOW E. TINTED - TEMPERED	SEE SPECIFICATIONS
GL-4	1/4" CLEAR	SEE SPECIFICATIONS
GL-5	1/2" CLEAR - TEMPERED	SEE SPECIFICATIONS



Stacey Construction
 Construction Manager
 General Contractor
 3768 Pacific Ave.
 Ogden, UT 84405
 801.621.6210
 www.staceyco.com

Consultant

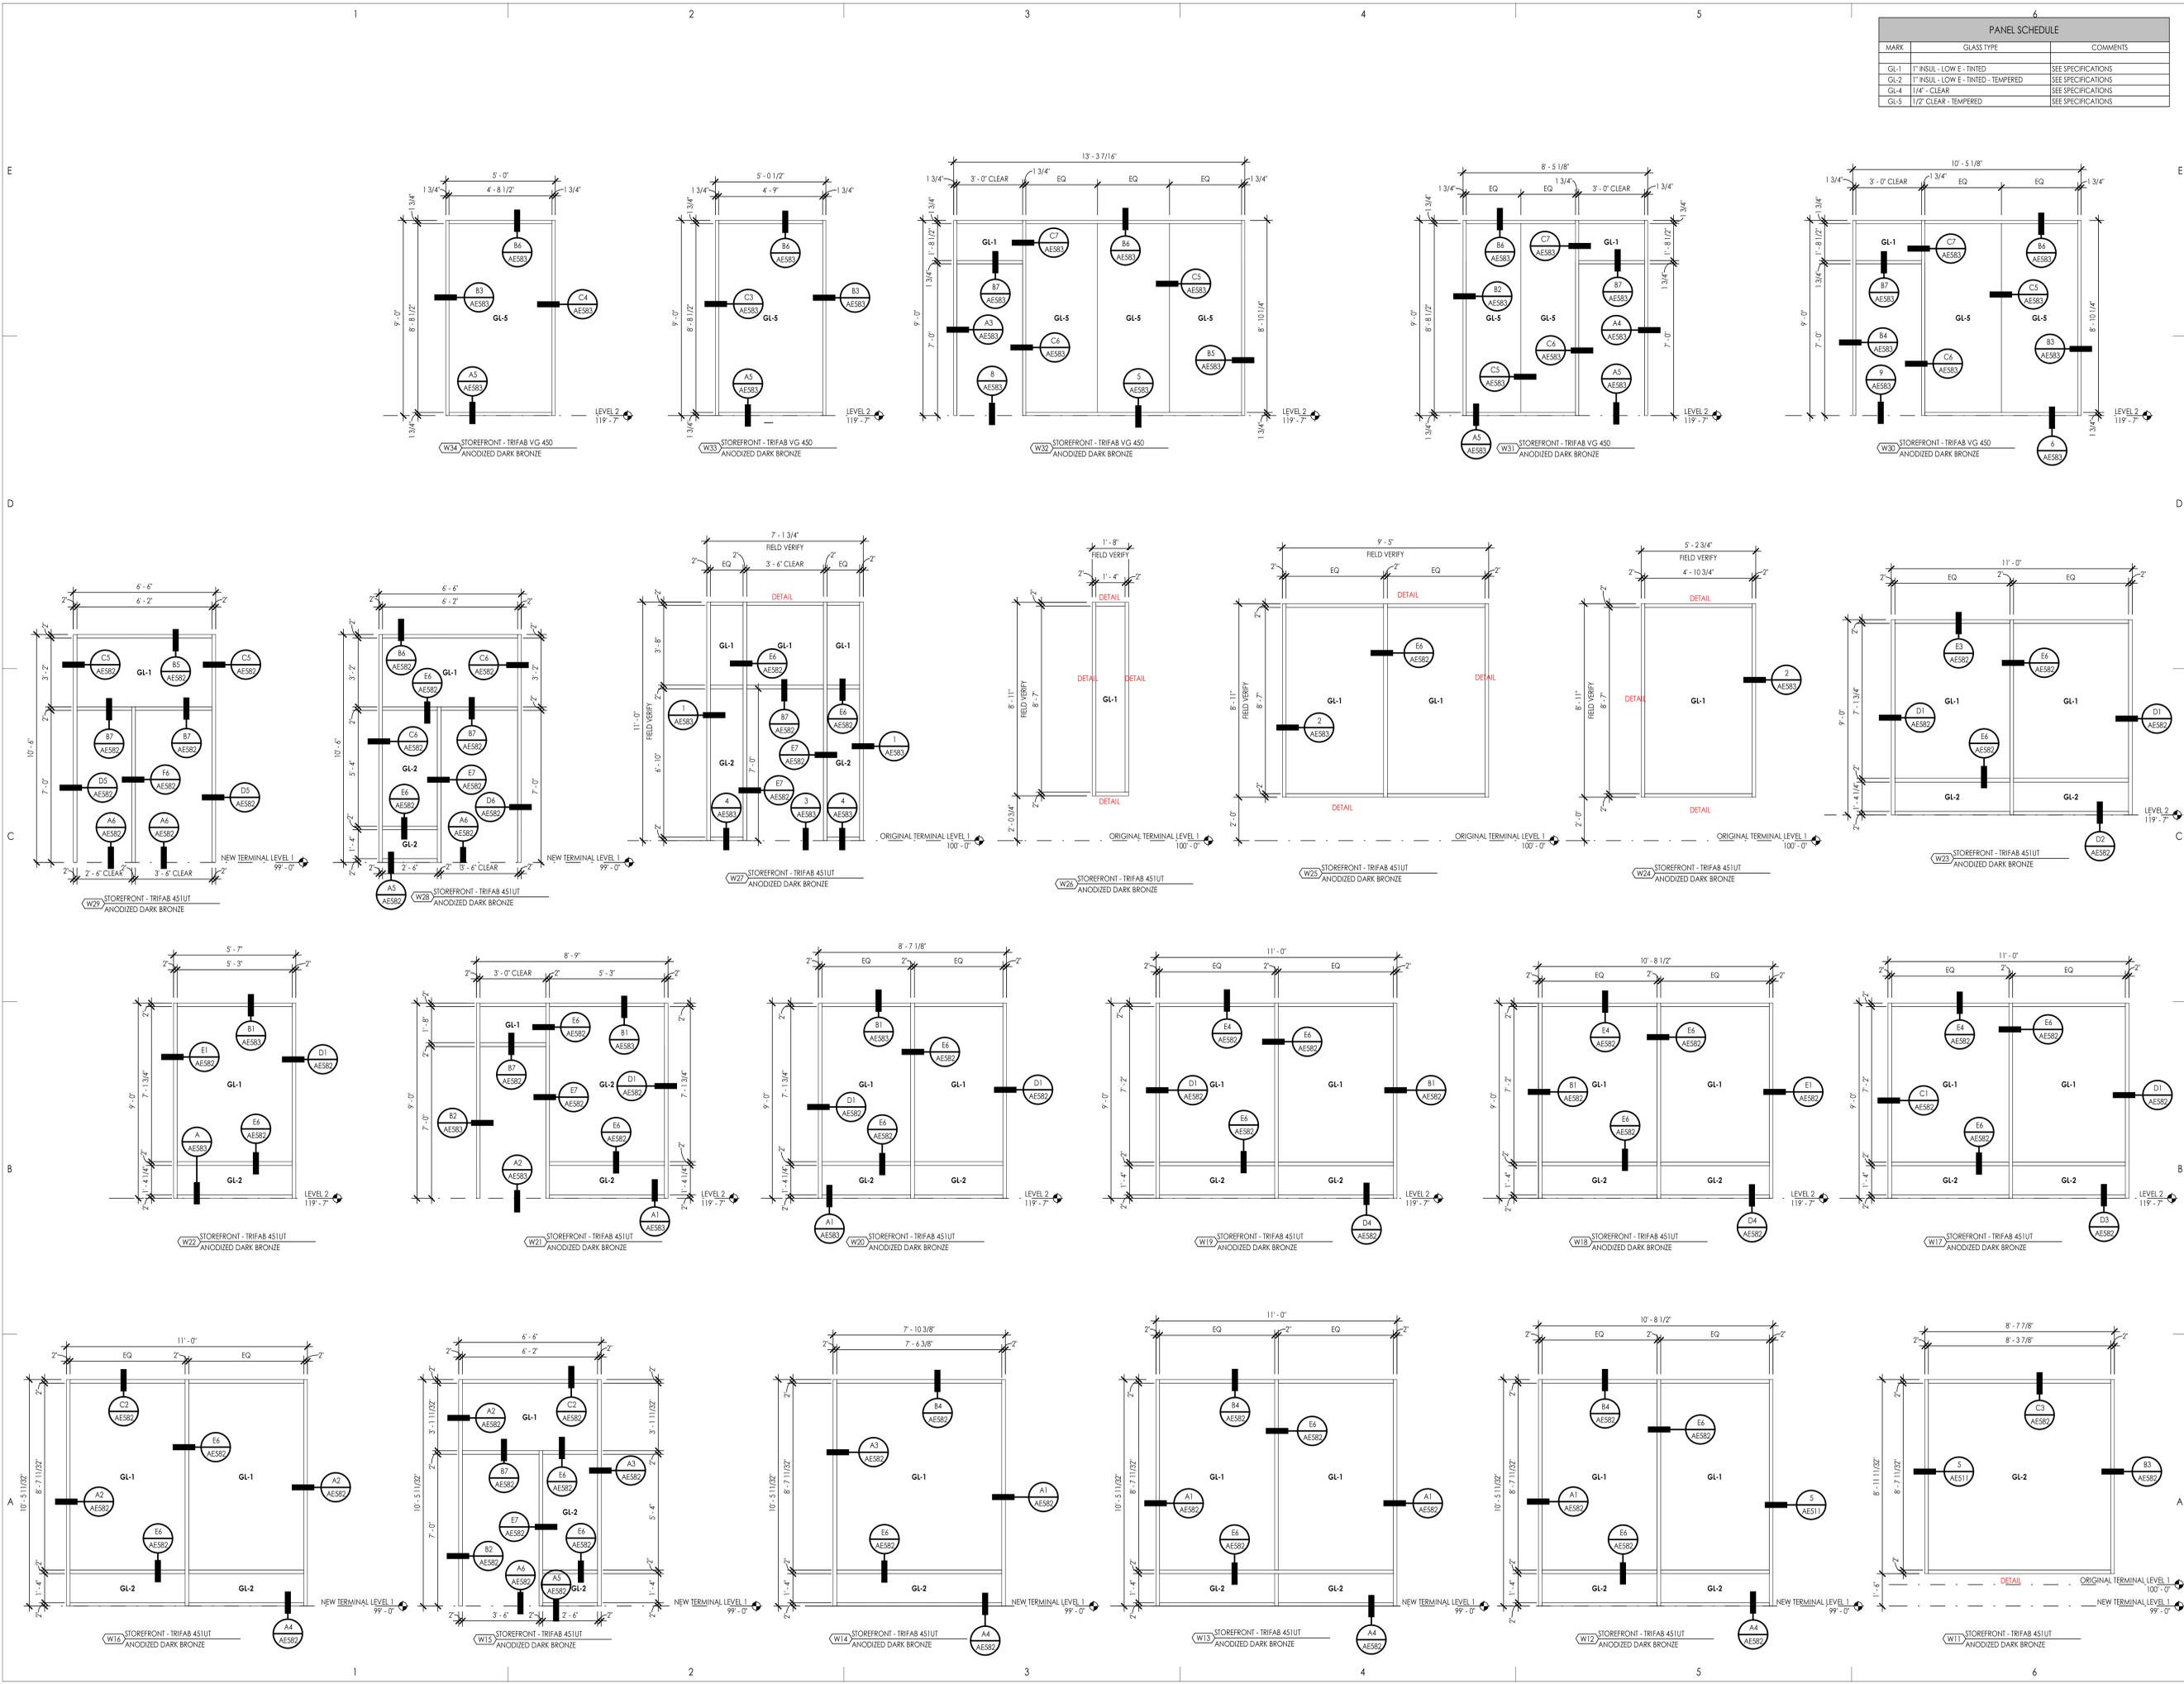

OGDEN-HINCKLEY AIRPORT
TERMINAL EXPANSION
 3909 AIRPORT ROAD
 OGDEN, UT 84405

Project Name

Issued	No.	Date	Description
1	11-15-2022	BID SET	

Revision

No.	Date	Description


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 Drawing Title

FRAME TYPES

Sheet Number

AE622


INTERIOR FINISH LEGEND							ROOM FINISH SCHEDULE												
CODE	MATERIAL	MANUFACTURER	PRODUCT	COLOR/FINISH	SIZE	COMMENTS	NO.	NAME	FLOOR	BASE FINSH	NORTH WALL	SOUTH WALL	EAST WALL	WEST WALL	CEILING FINISH	CASEWORK/COUNTER	CASEWORK CABINET	NO.	
CARPET							BASEMENT												
B100	ENTRY	PC-1	RB-1	PNT-1	PNT-1	PNT-1	B100	ENTRY	PC-1	RB-1	PNT-1	PNT-1	PNT-1	PNT-1	PNT-2	-	-	B100	
CPT-1	CARPET TILE						B101	HALL	PC-1	RB-1	PNT-1 / 1-2222	PNT-1 / 1-2222	PNT-1	PNT-1 / 1-2222	PNT-2	-	-	B101	
CPT-2	CARPET TILE						B102	MEN	PC-1	-	-	-	-	-	PNT-5	Q-1	-	B102	
CONCRETE							LEVEL 1												
PC-1	POLISHED CONCRETE						B103	WOMEN	PC-1	-	-	-	-	-	PNT-5	Q-1	-	B103	
GROUT							LEVEL 2												
G-1	GROUT	MAPEI	FLEXCOLOR CQ				B104	EXISTING UTILITY	EXIST.	EXIST.	EXIST.	EXIST.	EXIST.	EXIST.	EXIST.	-	-	B104	
G-2	GROUT	MAPEI	FLEXCOLOR CQ				B105	EXISTING MAINTENANCE	EXIST.	EXIST.	EXIST.	EXIST.	EXIST.	EXIST.	EXIST.	-	-	B105	
PAINT							LEVEL 3												
PNT-1	FIELD PAINT	SHERWIN WILLIAMS		SW7008 ALABASTER (255-C2) / EGG SHELL			B106	EXISTING UTILITY	EXIST.	EXIST.	EXIST.	EXIST.	EXIST.	EXIST.	EXIST.	-	-	B106	
PNT-2	CEILING PAINT	SHERWIN WILLIAMS		SW7008 ALABASTER (255-C2) / FLAT			B107	EXISTING UTILITY	EXIST.	EXIST.	EXIST.	EXIST.	EXIST.	EXIST.	EXIST.	-	-	B107	
PNT-3	ACCENT PAINT	SHERWIN WILLIAMS		SW7069 IRON ORE (251-C7) / SEMI-GLOSS		HOLLOW METAL DOORS & FRAMES	B108	TRAINING	PC-1	RB-1	PNT-1	PNT-1	PNT-1	PNT-1	PNT-2	-	-	B108	
PNT-4	CEILING PAINT	SHERWIN WILLIAMS		SW7069 IRON ORE (251-C7) / FLAT			B109	REFRESH	PC-1	RB-1	PNT-1	PNT-1	PNT-1	PNT-1	PNT-2	Q-1	PL-1	B109	
PNT-5	EPOXY CEILING PAINT	SHERWIN WILLIAMS		SW7008 ALABASTER (255-C2) / FLAT		RESTROOM CEILINGS	B110	EXISTING UTILITY	EXIST.	EXIST.	EXIST.	EXIST.	EXIST.	EXIST.	EXIST.	-	-	B110	
WALL COVERING							LEVEL 4												
WP-1	WALL PROTECTION FRP PANEL		FRP PANEL	WHITE			B111	HALL	PC-1	RB-1	PNT-1	PNT-1	PNT-1	PNT-1	PNT-2	-	-	B111	
WOOD CEILING							LEVEL 5												
WOC-1	SUSPENDED WOOD CEILING SYSTEM	RULON	PANEL GRILLE	SEE SPEC.	SEE SPEC.		B112	STORAGE	PC-1	RB-1	PNT-1	PNT-1	PNT-1	PNT-1	PNT-2	-	-	B112	
WOOD VENEER							LEVEL 6												
WG-1	SURFACE-MOUNTED WOOD GRILLE						B113	STORAGE	PC-1	RB-1	PNT-1	PNT-1	PNT-1	PNT-1	PNT-2	-	-	B113	
PLASTIC LAMINATE							LEVEL 7												
PL-1	PLASTIC LAMINATE						B114	HALL	PC-1	RB-1	PNT-1	PNT-1	PNT-1	PNT-1	PNT-2	-	-	B114	
ML-1	WHITE MELAMINE						B115	STORAGE	PC-1	RB-1	PNT-1	PNT-1	PNT-1	PNT-1	PNT-2	-	-	B115	
SOLID SURFACE							LEVEL 8												
SS-1	SOLID SURFACE		SOLID SURFACE	COLOR TO MATCH EXISTING WINDOW SILLS	WINDOW SILL		B116	EXISTING UTILITY	EXIST.	EXIST.	EXIST.	EXIST.	EXIST.	EXIST.	EXIST.	-	-	B116	
QUARTZ							LEVEL 9												
Q-1	QUARTZ						B117	EXISTING UTILITY	EXIST.	EXIST.	EXIST.	EXIST.	EXIST.	EXIST.	EXIST.	-	-	B117	
ACOUSTICAL							LEVEL 10												
AC-1	ACOUSTIC CEILING TILE	CERTAINTEED	CASHMERE TEGULAR MINERAL FIBER CEILING	WHITE	2' X 4'	STANDARD METAL SUSPENSION	B118	STAIRS	PC-1	RB-1	PNT-1	PNT-1	PNT-1	PNT-1	PNT-2	-	-	B118	
AC-2	ACOUSTIC CEILING TILE	CERTAINTEED	CASHMERE TEGULAR MINERAL FIBER CEILING	WHITE	2' X 2'	STANDARD METAL SUSPENSION	B119	MEN	PC-1	-	-	-	-	-	PNT-2	Q-1	-	B119	
BLINDS							LEVEL 11												
B-1	RECESSED BLINDS	SEE SPEC.					B120	EXIST. STOR.	PC-1	RB-1	PNT-1	PNT-1	PNT-1	PNT-1	PNT-2	-	-	B120	
B-2	SURFACE-MOUNTED BLINDS - MOTORIZED	SEE SPEC.					B121	FAMILY RESTROOM	PC-1	-	-	-	-	-	PNT-2	Q-1	PL-1	B121	
B-3	SURFACE-MOUNTED BLINDS - MANUAL	SEE SPEC.					B122	TICKETING	PC-1	RB-1	PNT-1	PNT-1	PNT-1	PNT-1	PNT-2	Q-1	PL-1	B122	
FINISH SCHEDULE							LEVEL 12												
FINISH SCHEDULE							LEVEL 13												
FINISH SCHEDULE							LEVEL 14												
FINISH SCHEDULE							LEVEL 15												
FINISH SCHEDULE							LEVEL 16												
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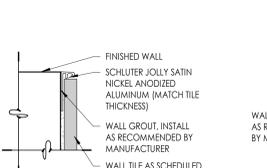
6 TILE TRANSITION DETAIL
6" = 1'-0"

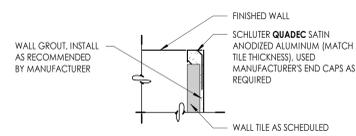


B2 TILE TRANSITION DETAIL
6" = 1'-0"




B3 TILE TRANSITION DETAIL
6" = 1'-0"

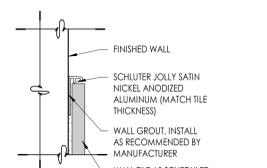


B4 TILE TRANSITION DETAIL
6" = 1'-0"

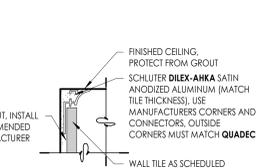


B5 TILE TRANSITION DETAIL
6" = 1'-0"

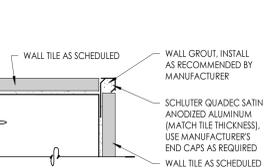


B6 TILE TRANSITION DETAIL
6" = 1'-0"

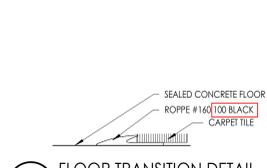


1 FLOOR TRANSITION DETAIL
6" = 1'-0"

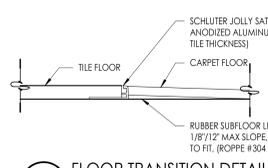

A3 FLOOR TRANSITION DETAIL
6" = 1'-0"

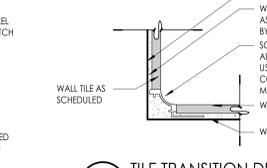


A4 TILE TRANSITION DETAIL
6" = 1'-0"

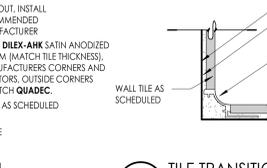

A5 TILE TRANSITION DETAIL
6" = 1'-0"



A6 TILE TRANSITION DETAIL
6" = 1'-0"

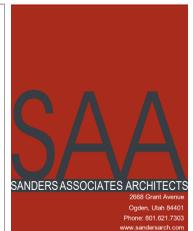

Consultant

Project Name
OGDEN-HINCKLEY AIRPORT
TERMINAL EXPANSION
3909 AIRPORT ROAD
OGDEN, UT 84405

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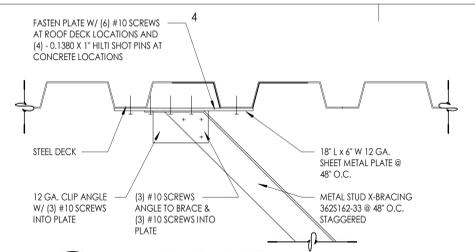
Revision	No.	Date	Description

SAA Project No. 2021-10
Drawing Title


FINISH SCHEDULE & DETAILS

Sheet Number


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D3 WALL X-BRACING DETAIL
3" = 1'-0"



D4 SLIP TRACK DETAIL
1 1/2" = 1'-0"

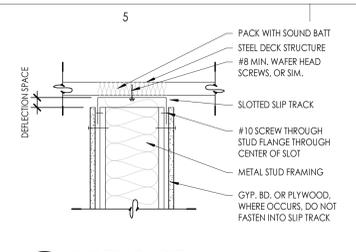

C4 SLIP TRACK ISOMETRIC DETAIL
3/4" = 1'-0"

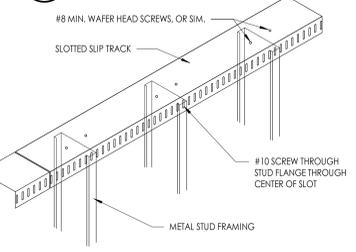NON-BEARING METAL STUD GAUGE

MEMBER DEPTH	STUD HEIGHT	MIN. GA. & SPACING
2 1/2" (2505125-33)	14'-0"	208 1/4" O.C. (Composite)
3 5/8" (3625125-33)	17'-0"	208 1/4" O.C. (Composite)
5 5/8" (3625125-43)	17'-0"	188 1/4" O.C. (Fully Braced)
6" (6005162-33)	15'-0"	208 1/4" O.C. w/ Bridging Hds Span
6" (6005162-33)	18'-0"	208 1/4" O.C. w/ Bridging 5 O.C.
6" (6005162-43)	22'-0"	188 1/4" O.C. w/ Bridging 5 O.C.
6" (6005162-54-50/3)	30'-0"	168 1/4" O.C. w/ Bridging 5 O.C.

- STEEL STUDS SHALL MEET ICC REPORT ESR-304P AND SSMVA STANDARDS HEIGHT BASED ON SSMVA 2015 CATALOG AND PROJECT REQUIREMENTS
- SEE SCHEDULE FOR STUD SPACING AND GAUGE. ALL STUDS AND BRACES SHALL BE 33 KSI UNLESS NOTED OTHERWISE IN THESE DRAWINGS
- AT ALL DOORS PROVIDE TWO TABBED 18 GAUGE STUDS AT BOTH SIDES

NON-BEARING HEADER SCHEDULE (1/4" AFF)

MAX. SPAN	HEADER STUDS	3 5/8" TRACKS	6" TRACKS	6" WALL TUBE STEEL	OPTION
7'-0"	(2) 3625162-33	(2) 3627150-33	(2) 4001150-33	HSS 6 x 6 x 1/8	
10'-0"	(2) 6005162-33	(2) 3627150-43	(2) 4001150-33	HSS 6 x 6 x 1/8	
11'-0"	(2) 6005162-43	(2) 3627150-43	(2) 4001150-33	HSS 6 x 6 x 1/8	
14'-0"	(2) 8005162-54	(2) 3627150-54	(2) 4001150-33	HSS 6 x 6 x 1/8	
16'-0"	(2) 8005162-54	(2) 3627150-54	(2) 4001150-33	HSS 6 x 6 x 1/8	
19'-0"	(2) 10005162-54	(2) 3627150-97	(2) 4001150-33	HSS 6 x 6 x 3/16	
21'-0"	(2) 10005250-48	-	(2) 4001150-33	HSS 10 x 6 x 3/16	
25'-0"	-	-	-	HSS 12 x 6 x 3/16	
27'-0"	-	-	-	HSS 12 x 6 x 1/4	

- SCHEDULE TO BE USED FOR NON-BEARING WALLS (1/4" AFF)
- HEADERS TO BE CONSTRUCTED AS BOX HEADERS PER SSMVA


NON-BEARING HEADER SCHEDULE (3/4" AFF)

MAX. SPAN	HEADER STUDS	3 5/8" TRACKS	6" TRACKS	6" WALL TUBE STEEL	OPTION
4'-0"	(2) 3625162-33	(2) 3627150-33	(2) 4001150-33	HSS 3.5x3.5x1/8	
7'-0"	(2) 6005162-33	(2) 3627150-33	(2) 4001150-33	HSS 3.5x3.5x1/8	
9'-0"	(2) 6005162-43	(2) 3627150-33	(2) 4001150-33	HSS 3.5x3.5x1/8	
10'-0"	(2) 8005162-54	(2) 3627150-33	(2) 4001150-33	HSS 3.5x3.5x1/8	
12'-0"	(2) 10005162-54	(2) 3627150-97	(2) 4001150-33	HSS 3.5x3.5x1/8	
15'-0"	(2) 10005250-48	-	(2) 4001150-33	HSS 7.6x5.1/6	
17'-0"	-	-	-	HSS 8x3x3/8	
19'-0"	-	-	-	HSS 10x5.5x1/6	
21'-0"	-	-	-	HSS 10x5.5x1/2	
25'-0"	-	-	-	HSS 12x6x1/4	
27'-0"	-	-	-	HSS 14x6x1/4	

- SCHEDULE TO BE USED FOR NON-BEARING WALLS (3/4" AFF)
- HEADERS TO BE CONSTRUCTED AS BOX HEADERS PER SSMVA

PARTITION NOTES

- PARTITION TYPE INDICATIONS ARE INDEPENDENT OF APPLIED FINISHES. SEE THE FINISH SHEET AND INTERIOR ELEVATIONS FOR WALL FINISHES AND ON PLANS FOR ADDITIONAL INFORMATION REGARDING APPLIED FINISHES
- WHERE NEW WALLS OR FURRING ARE INDICATED TO BE DIMENSIONED OFF OF AN EXISTING WALL, THE NEW WALL SHALL BE STRAIGHT AND PLUMB REGARDLESS OF THE CONDITION OF THE EXISTING WALL
- AT ALL INTERIOR WALLS, STUDS, INSULATION AND GYPSUM BOARD ARE TO EXTEND TO THE DECK ABOVE, UNLESS NOTED OTHERWISE
- WALL TYPES NOT NOTED ARE ASSUMED TO MATCH ADJACENT ROOMS. SEE SHEETS FOR FINISHES. NOTIFY ARCHITECT OF ANY DISCREPANCIES
- WHERE PARTITION TYPE DESIGNATION ON FLOOR PLANS IS INTERRUPTED BY DOOR OPENING, GLAZING PARTITIONS, ETC., CONSTRUCTION ABOVE INTERRUPTION IS TO BE THE SAME AS THAT DESIGNATION FOR THE PARTITION IN WHICH THE INTERRUPTION OCCURRED
- THE MINIMUM REQUIREMENTS FOR THE CONSTRUCTION OF EACH PARTITION TYPE AS EXPRESSED BY THE INDICATED REFERENCE ARE INCORPORATED BY REFERENCE AND ARE APPLICABLE TO THE WORK OF THIS PROJECT, HOWEVER ADDITIONAL AND/OR MORE RESTRICTIVE REQUIREMENTS MAY BE INDICATED BY THE SPECIFICATIONS AND DRAWINGS. SUCH REQUIREMENTS ALSO APPLY TO WALL COVERINGS. SUCH REQUIREMENTS INCLUDE BUT ARE NOT LIMITED TO: USE 5/8" THICK GYPSUM BOARD THROUGHOUT UNLESS NOTED OTHERWISE; B. USE 1/4" O.C. MAX STUD SPACING UNLESS NOTED OTHERWISE IN THESE DOCUMENTS. THE SPACING STATED BY THE REFERENCED APPROVAL OR TEST REPORT IS THE MAX SPACING ALLOWED IN THESE DOCUMENTS. C. USE STUDS OF GAUGE INDICATED ON THE DRAWINGS OR IN THE SPECIFICATIONS. THE GAUGE STATED BY THE REFERENCED APPROVAL OR TEST REPORT IS THE MINIMUM GAUGE TESTED, 20 GA (30 MIL) IS THE MINIMUM ALLOWED IN THESE DOCUMENTS
- USE STUDS OF DEPTH INDICATED BY THIS SET OF DOCUMENTS. THE DEPTH STATED BY THE REFERENCED APPROVAL OR TEST REPORT IS THE MINIMUM DEPTH TESTED DEPTH ALLOWED IN THESE DOCUMENTS. SEE STRUCTURAL DOCUMENTS FOR ADDITIONAL INFORMATION PERTAINING TO THE CONSTRUCTION OF CONCRETE, MASONRY, AND STUD WALLS
- PROVIDE FIRE RATED CONSTRUCTION ASSEMBLIES WHERE INDICATED ON SHEETS
- ALL DIMENSIONS ARE FACE OF STUD OR FACE OF CONCRETE, MASONRY, OR ROUGH OPENING UNLESS OTHERWISE NOTED
- ALL METAL STUD PARTITIONS ARE CONSIDERED ACOUSTIC PARTITIONS AND ARE TO RECEIVE A TYPE 1 SOUND ATTENUATION BLANKET, THICKNESS TO MATCH STUD DEPTH, UNLESS NOTED OTHERWISE
- PROVIDE CONTROL JOINTS IN METAL FRAMED WALLS AT APPROXIMATELY 30 FEET ON CENTER. LOCATE AT CORNER ABOVE DOORS OR INSIDE CORNER OF PLASTER OTHER INCONSPICUOUS LOCATION WHERE POSSIBLE. CONSULT WITH ARCHITECT PRIOR TO COMMENCING FRAMING. INSTALL PER DETAILS FOR CONTROL JOINTS
- AT WALL OPENINGS FOR PENETRATION OF PIPES, DUCTS, DEVICES, ETC., GYPSUM BOARD IS TO BE CUT TO MATCH THE SHAPE AND DIMENSION OF THE PENETRATING OBJECT AND THE CAP BETWEEN THE OBJECT AND THE WALL IS TO BE SEALED W/ACOUSTICAL, OR FIRE SEALANT ON ALL SIDES WITH A 3/4" JOINT AT ALL SIDES. MAXIMUM THE OPENING FOR THE DUCTS OR LARGER PENETRATIONS SHALL BE FRAMES WITH A HEADER. ADD AN ANGLED CORNER BRACE IF THE GAP EXCEEDS 3" FROM THE FRAMING
- CONTRACTOR TO PROVIDE BLOCKING/BRACING FOR ALL WALL MOUNTED EQUIPMENT. SEE FLOOR PLANS AND INTERIOR ELEVATIONS FOR CABINETS, GRAB BARS, ETC. INSTALL BLOCKING AS DETAILED OR AS REQUIRED TO MOUNT SUCH DEVICES. ALL BLOCKING IS TO BE FIRE RETARDANT TREATED
- WHERE THERE IS LIMITED WATER EXPOSURE, INSTALL ONE LAYER OF 5/8" TYPE X WATER RESISTANT GYPSUM BOARD PER ASTM C 1396 (WHERE GYPSUM BOARD OCCURS) OR BASIC PARTITION AT THE FOLLOWING: A. WITH IN 2 FEET HORIZONTALLY AND 4 FEET VERTICALLY OF JANITORS SHEETS. B. AT OTHER LOCATIONS I.E. TOILET ROOMS AND KITCHEN, AND AS INDICATED ON THE ARCHITECTURAL FINISH PLANS AND ELEVATIONS
- INSTALL ONE LAYER OF 5/8" GYPSUM BOARD WITH TILE BACKER BOARD IN LIEU OF GYPSUM BOARD (WHERE GYPSUM BOARD OCCURS) OF BASIC PARTITION WHERE THERE IS PARTITIONS AT THE FOLLOWING LOCATIONS: A. AT WEI LOCATIONS, SUCH AS SHOWER STALLS AND THE SURROUNDINGS. B. WHERE CERAMIC TILE FINISHES ARE INDICATED PER THE FINISH PLANS AND/OR INTERIOR ELEVATIONS. C. AT OTHER LOCATIONS AS INDICATED BY THE ARCHITECTURAL FINISH PLANS AND ELEVATIONS

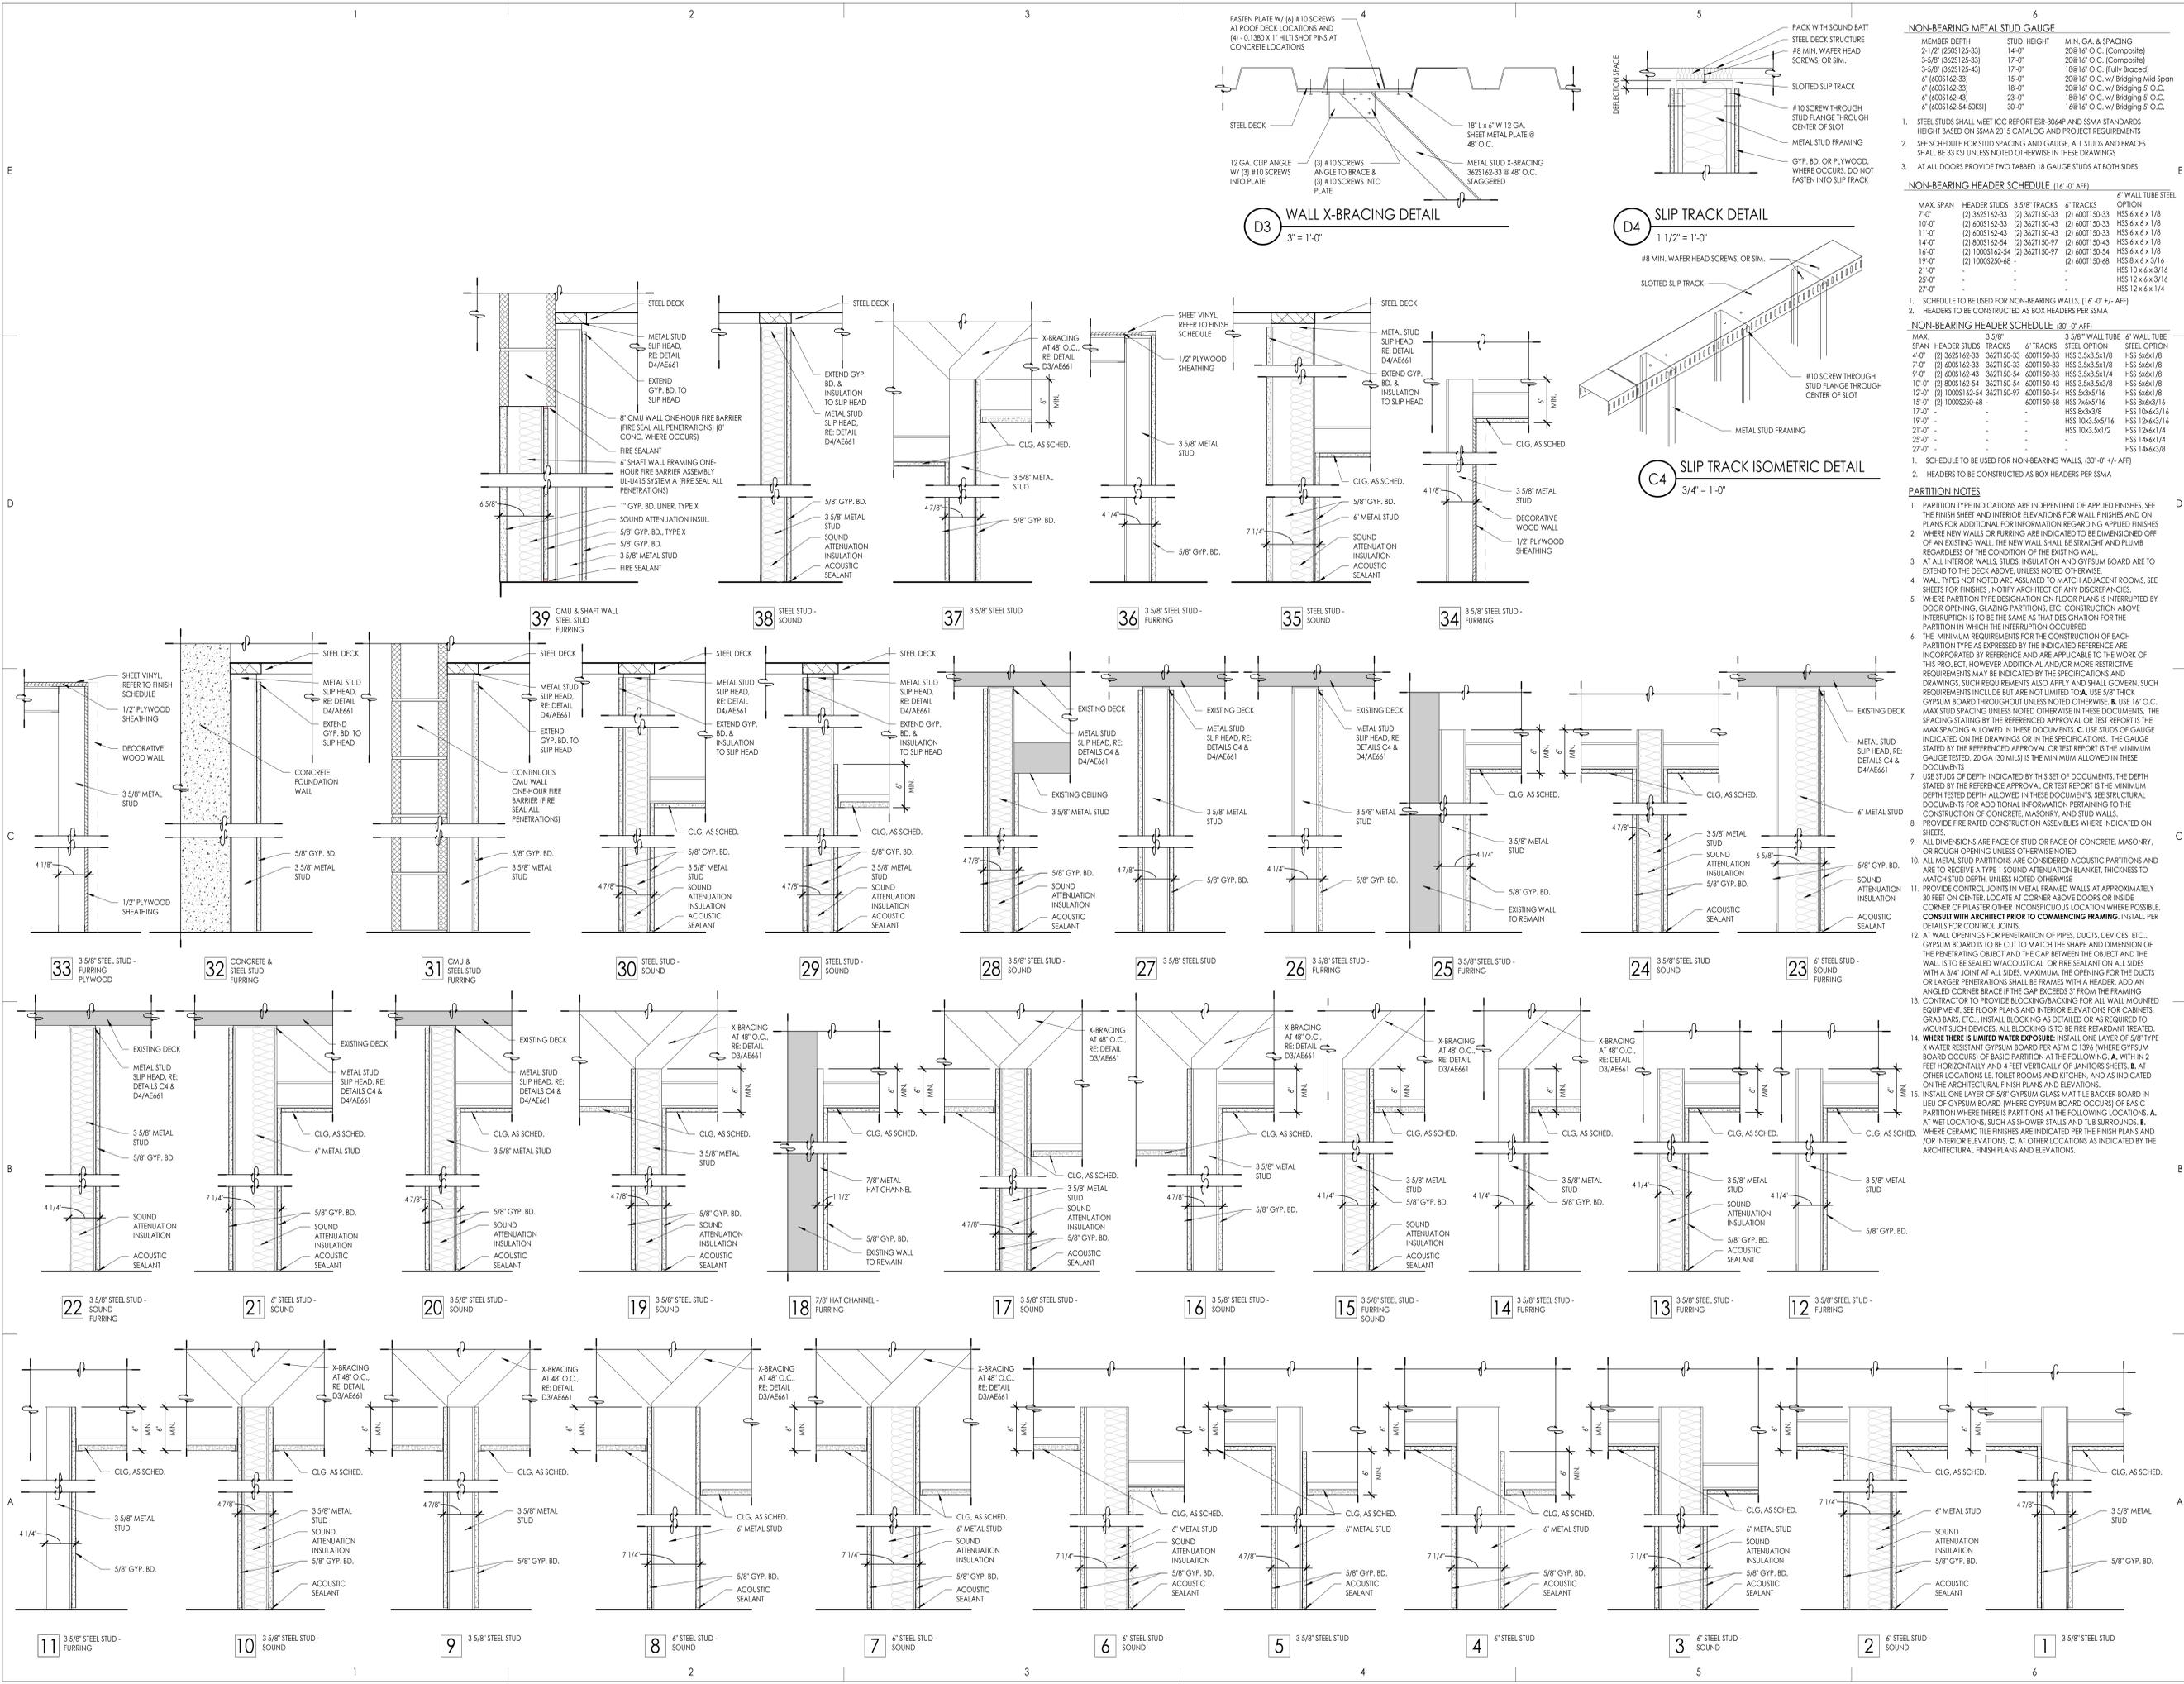

SAA
SANDERS ASSOCIATES ARCHITECTS
2008 Grant Avenue
Ogden, Utah 84403
Phone: 801.831.7300
www.sandersaai.com

STATE OF UTAH
No. 6826583
10.26.24
LICENSED ARCHITECT

General Contractor

STACEY CONSTRUCTION

Stacey Construction
Construction Manager
General Contractor
375B Pacific Ave.
Ogden, UT 84405
801.621.6210
www.staceycg.com

Consultant

OGDEN-HINCKLEY AIRPORT
TERMINAL EXPANSION
3909 AIRPORT ROAD
OGDEN, UT 84405

Project Name

Issued

No.	Date	Description
1	11-15-2022	BID SET

Revision

No.	Date	Description
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Drawing Title

PARTITION TYPES

Sheet Number

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